






PROPOSED FRONT ELEVATION
Scale 1:50

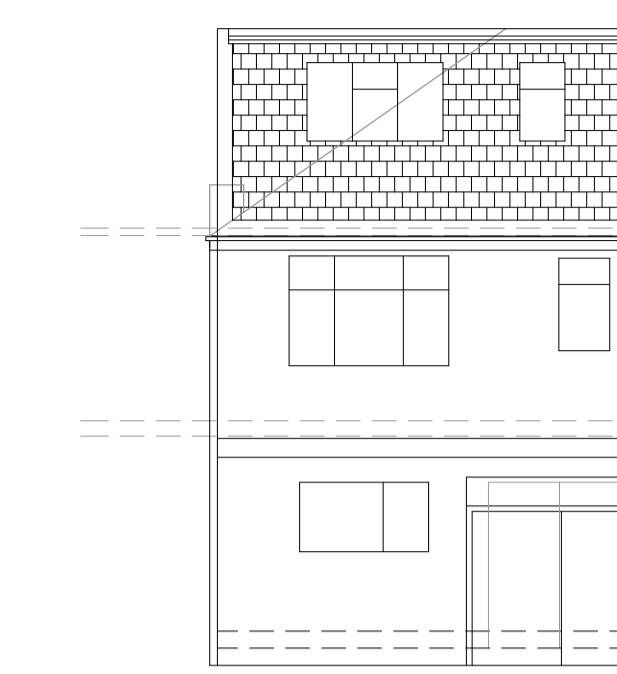




PROPOSED REAR ELEVATION
Scale 1:50

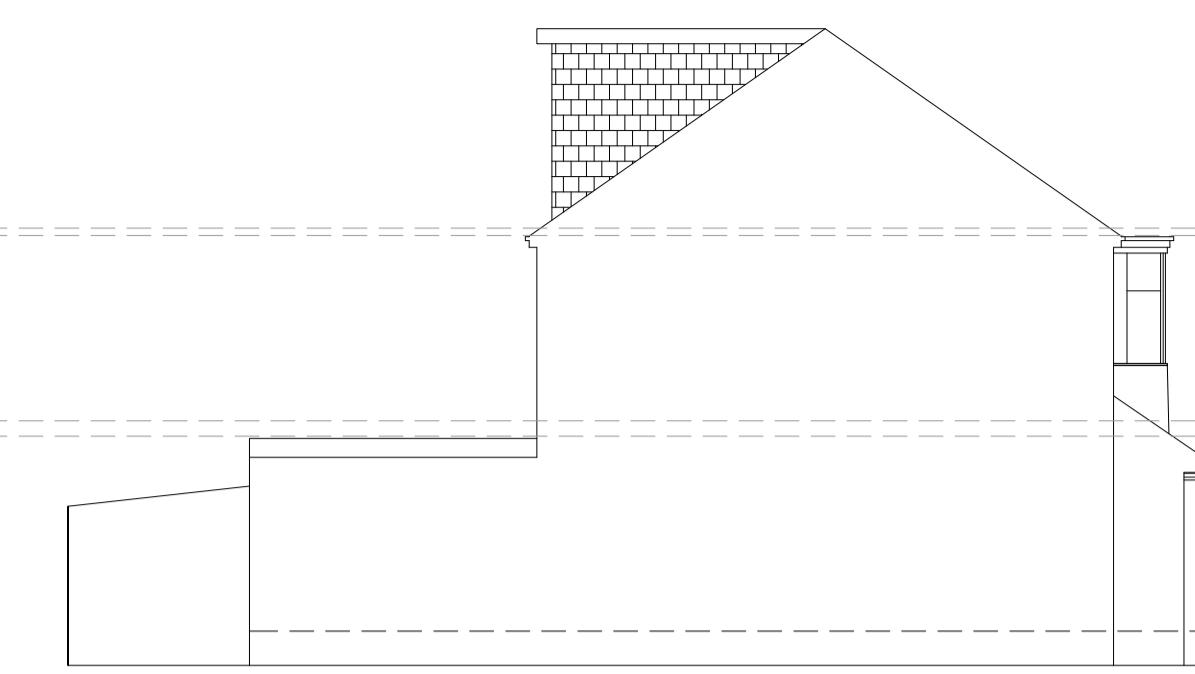


PROPOSED REAR ELEVATION
Scale 1:50

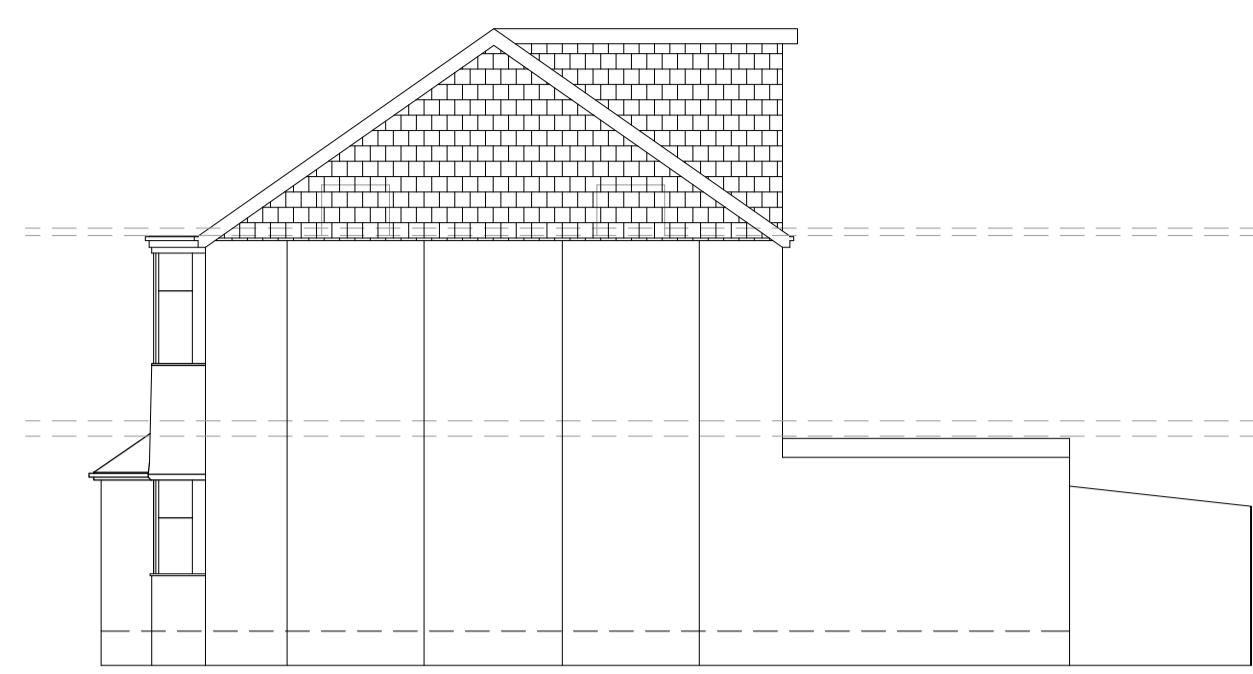


PROPOSED REAR ELEVATION
Scale 1:50

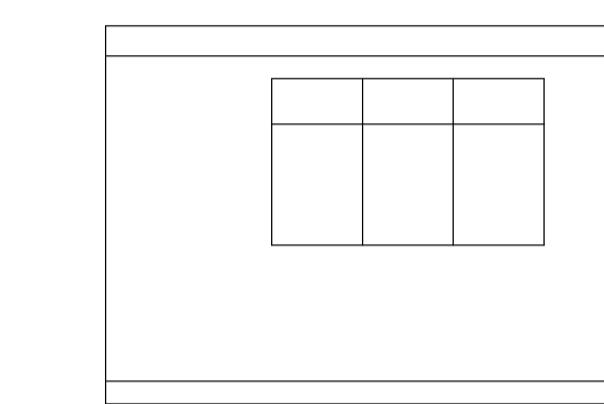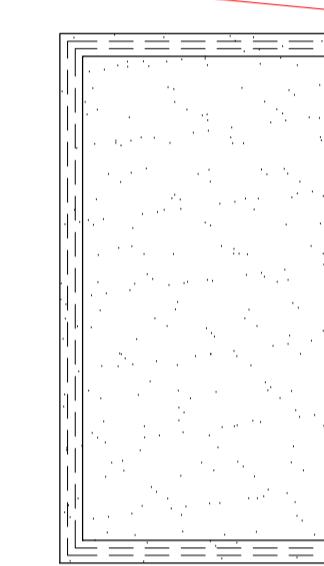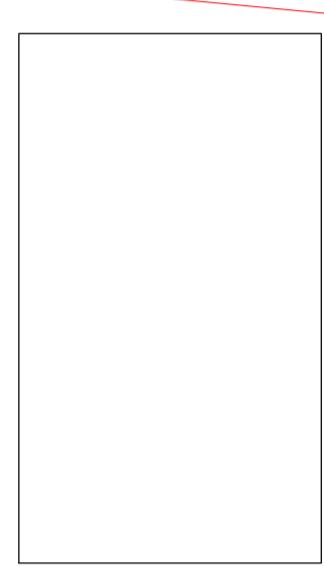


PROPOSED FRONT ELEVATION
Scale 1:50

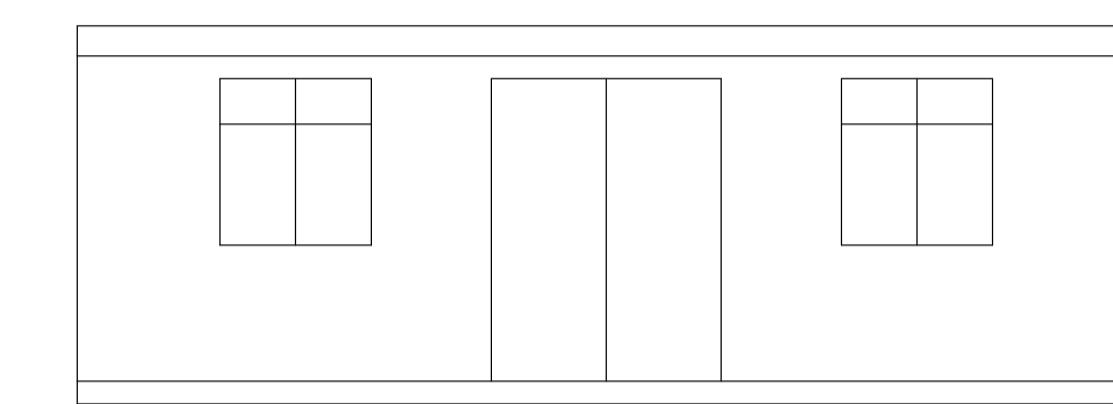


PROPOSED SIDE ELEVATION
Scale 1:50

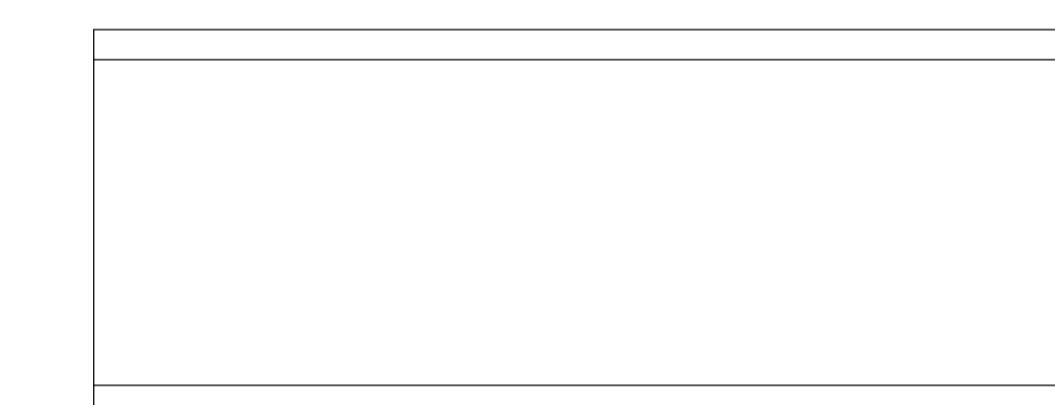


PROPOSED SIDE ELEVATION
Scale 1:50

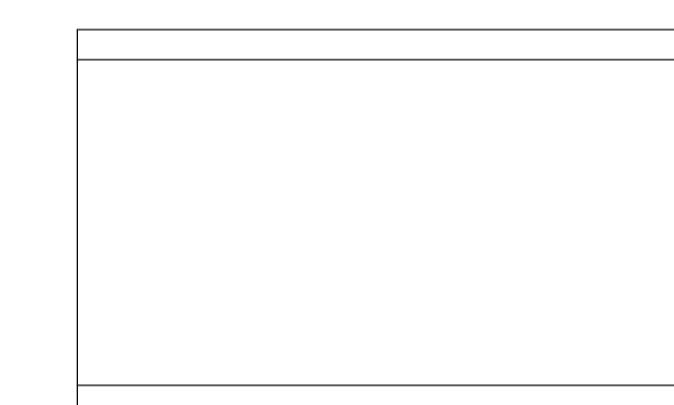


PROPOSED REAR ELEVATION
Scale 1:50

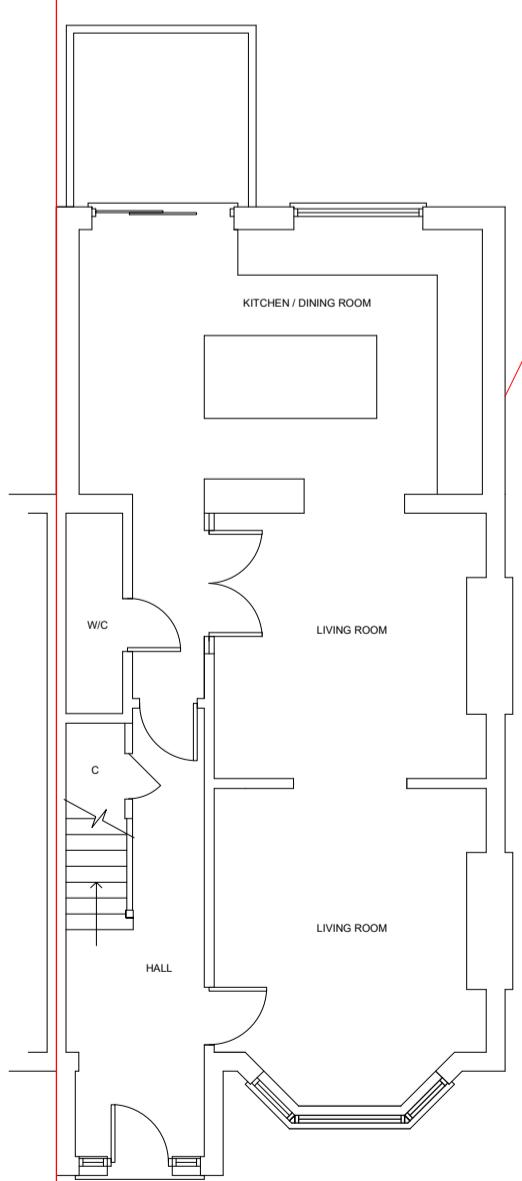


PROPOSED GROUND FLOOR PLAN
Scale 1:50

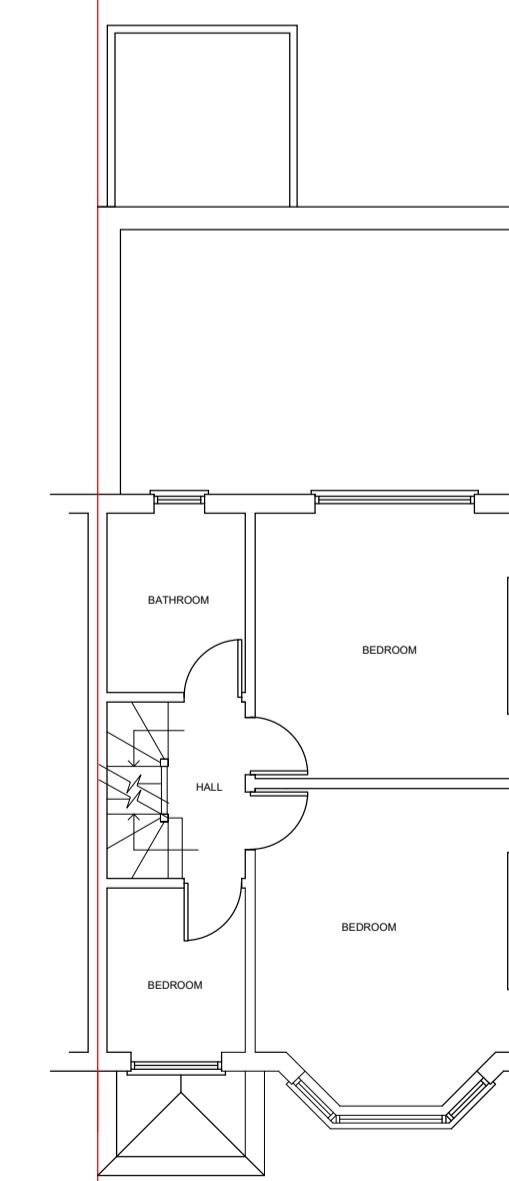

PROPOSED FIRST FLOOR PLAN
Scale 1:50

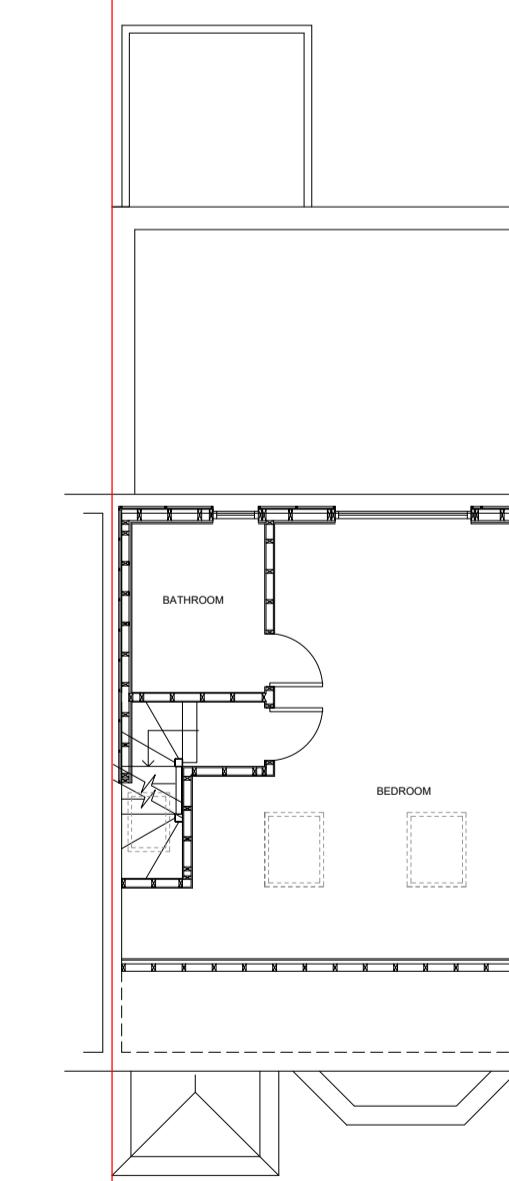

PROPOSED SECOND FLOOR PLAN
Scale 1:50

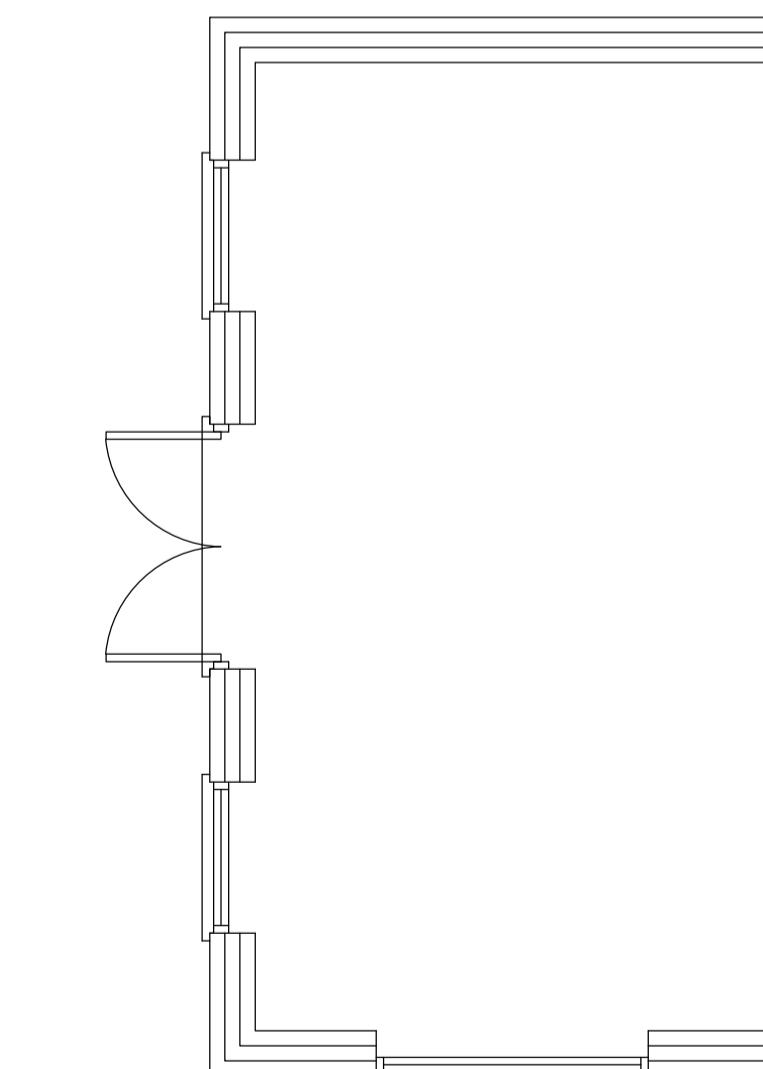

PROPOSED FLOOR PLAN
Scale 1:50

LOFT CONVERSION
VOLUME OF DORMER = $\frac{1}{2} \times 5.0 \times 3.1 \times 4.1 = 31.77\text{cu.m}$
VOLUME OF HIP TO GABLE = $\frac{1}{6} \times 7.3 \times 3.5 \times 3.5 = 14.9\text{cu.m}$
VOLUME 50cu.m > 46.67cu.m
TOTAL VOLUME EXTENDED ROOF AREA = 46.67cu.m

Rev | Description
 |

Project

86 Merton Avenue
Hillingdon
UB10 9BL

Drawing

PROPOSED PLANS AND ELEVATIONS

| | |
|-------------------|---------------------------------|
| SCALE As Shown | Date Drawing no. 25_06_02 |
|-------------------|---------------------------------|