

VOLUME CALCULATION

PROPOSED GABLE ROOF


① Vol =  $\frac{0.5 \times 7.23 \times 2.67 \times 3.62}{3}$  = 11.6m³

PROPOSED DORMER

② Vol =  $\frac{3.38 \times 2.50}{2} \times 5.88$  = 24.8m³

TOTAL VOLUME PROPOSED = Vol 1 + Vol 2  
= 36.4m³

LESS THAN THE 50m³ ALLOWED UNDER PERMITTED  
DEVELOPMENT FOR LOFT EXTENSIONS

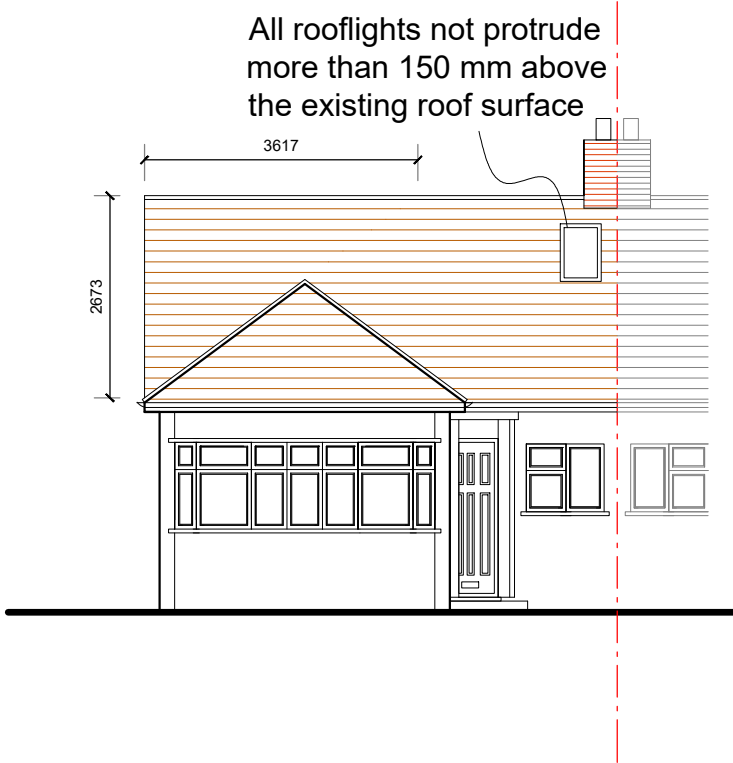

East Elevation




South Elevation

All proposed materials to match existing




West Elevation

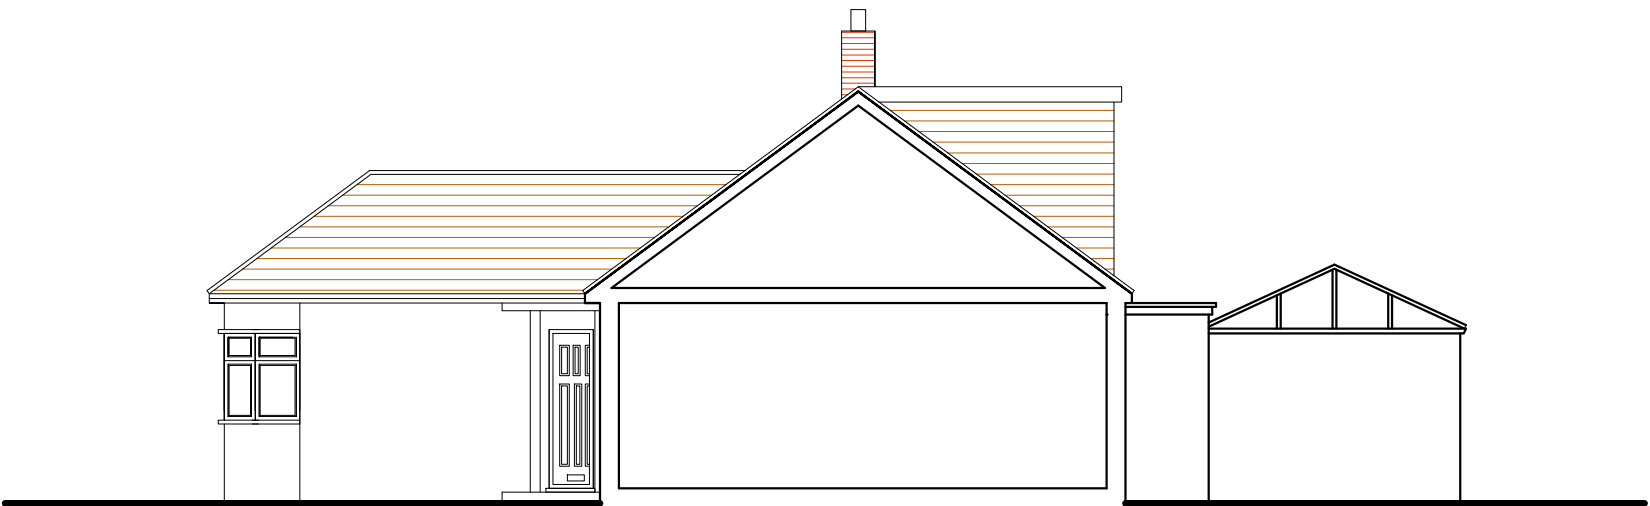

North Elevation

PROPOSED ELEVATIONS

54 Greencroft Avenue, Ruislip HA4 9JJ

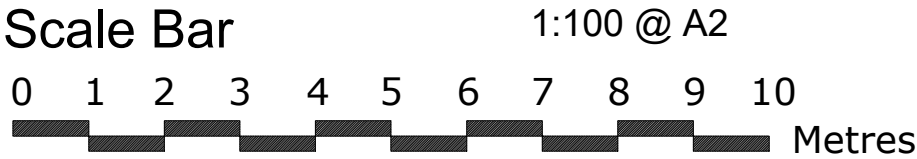

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Drg. No. 25/3660/05  
Scale 1:100  
Date 04/02/25  
Drawn by KH

REVISION

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