



Existing Side Elevation

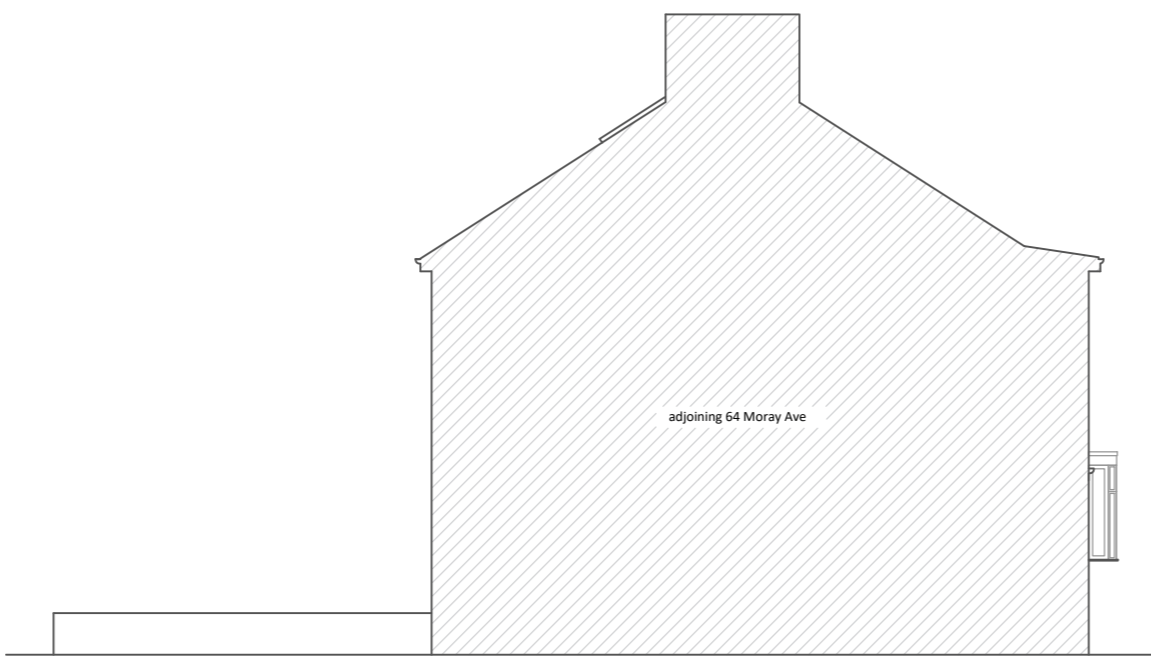



Existing Side Elevation




Existing Front Elevation  
Scale : 1:100

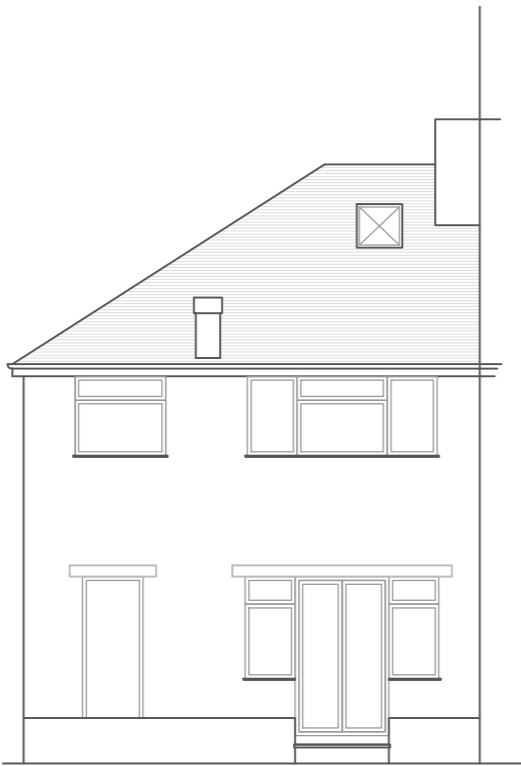


Existing Rear Elevation

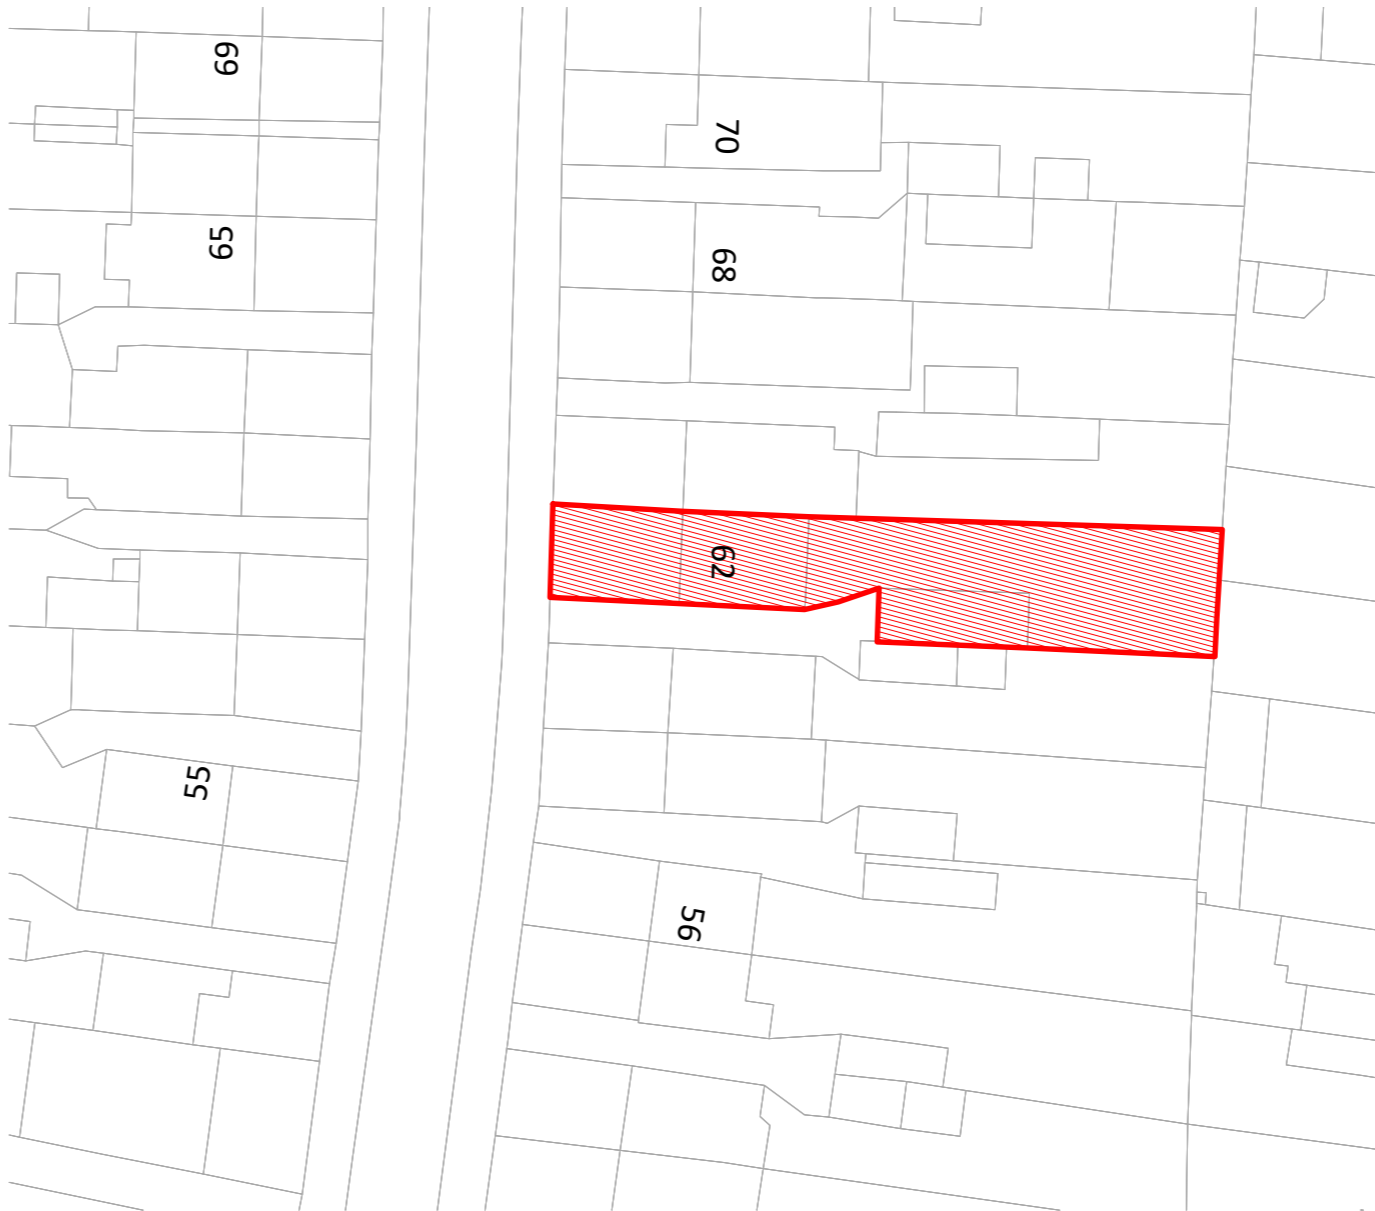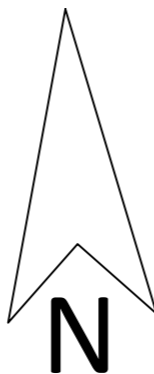


Block Plan  
Scale: 1:500

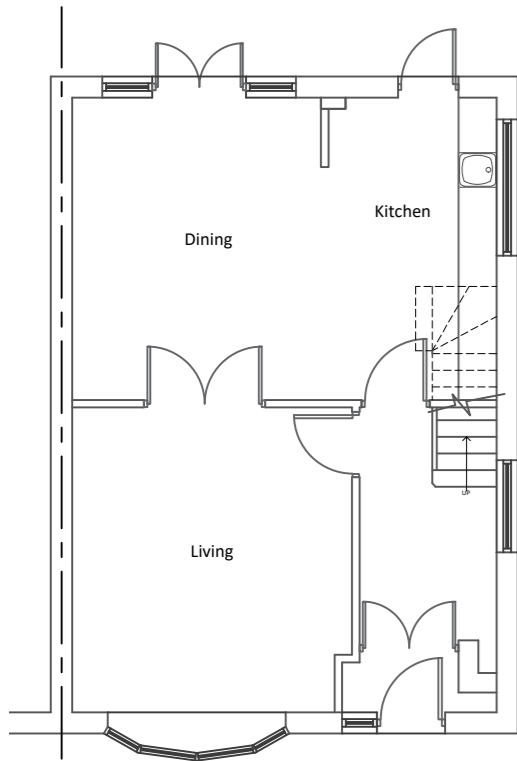


Existing Ground Floor Plan  
Scale : 1:100

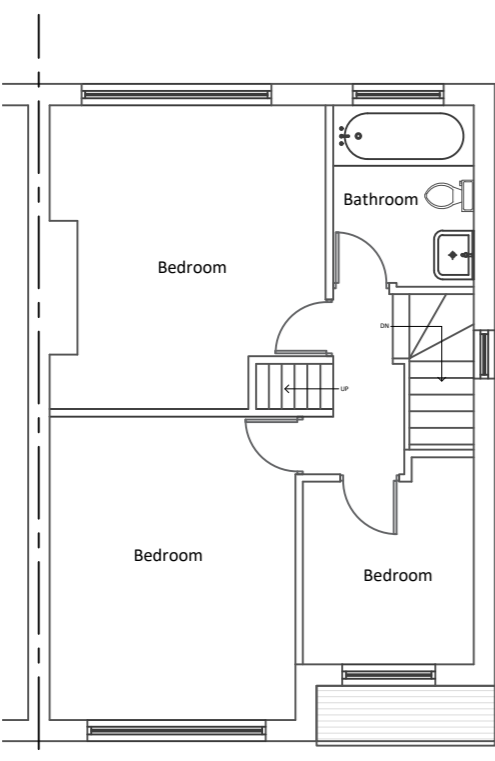


Existing First Floor Plan

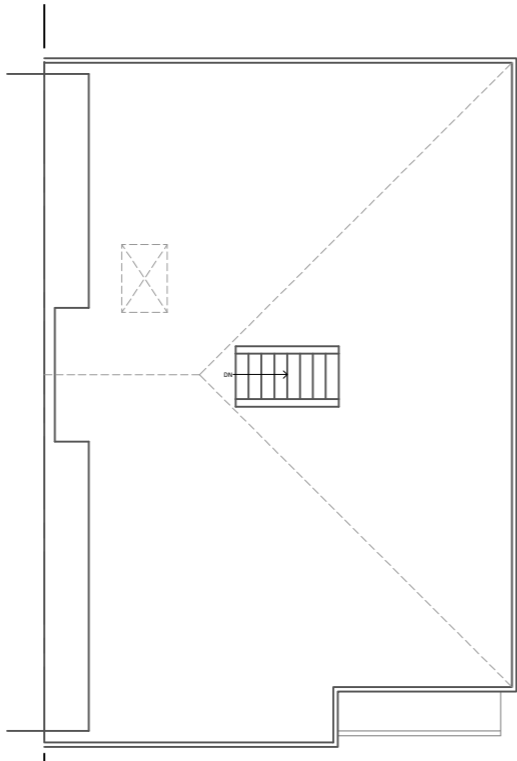

Existing Loft Floor Plan

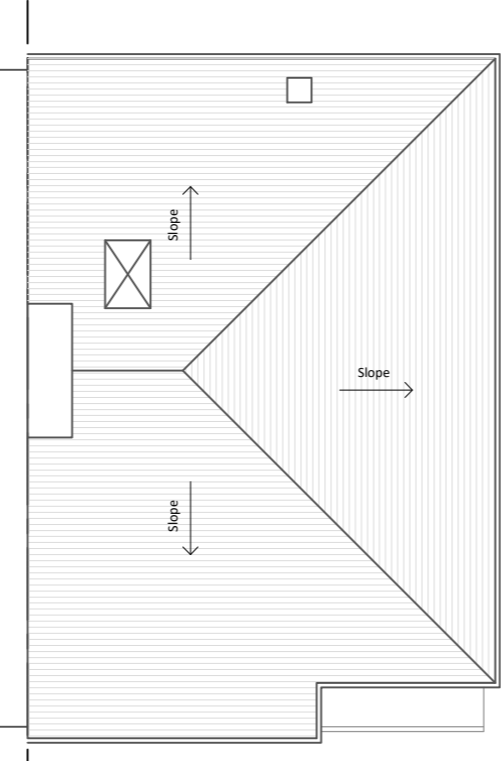

Existing Roof Plan

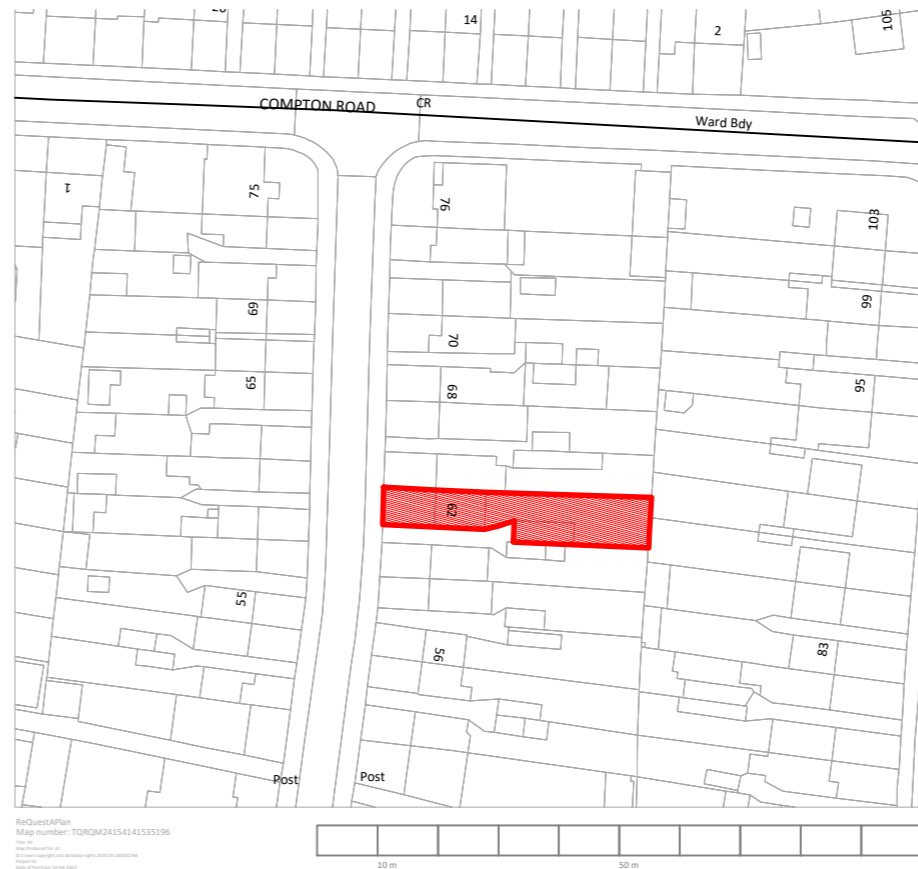

Site Location Plan  
Scale: 1:1250

**Note:**

1. This drawing and design are the copyright of Sustainable Renew Homes Ltd and must not be reproduced in part or in whole without prior written consent.
2. All dimensions are in millimeters and are approximate.
3. The new extension is to be in matching bricks.
4. Roof tiles for the new roof are to match the existing.
5. New windows are to match the existing.
6. New RWP (Rainwater Pipes)/drainage/drains are to be connected to the existing system.
7. Proposed studio size/dimensions should be adjusted on-site by the contractor during construction.

1:5 = 25cm	1:200 = 10m
1:10 = 50cm	1:250 = 12.5m
1:20 = 100cm	1:500 = 25m
1:50 = 2.5m	1:1250 = 62.5m
1:100 = 5m	1:2500 = 125m

Project Title: 62 Moray Avenue,  
Hayes UB3 2AX

Details: Dormer Loft Conversion &  
single-storey rear side extension  
House Holder Planning application

Drawing: Existing Plans & Elevations

Scale:  
1:100 @ A2

Date:  
June 2024

Drg No:  
MA - 001- R0



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