


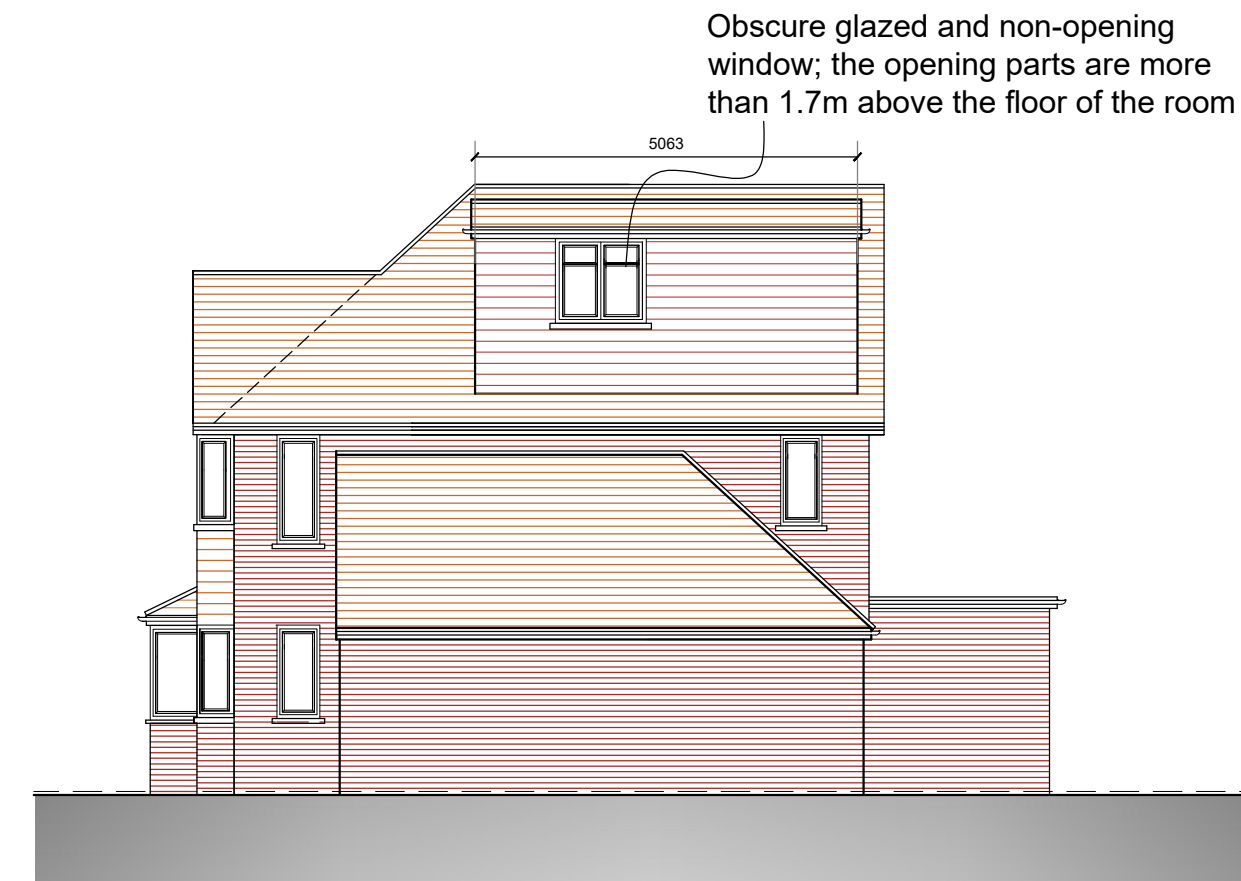


South West Elevation




South East Elevation

ALL MATERIALS TO MATCH EXISTING

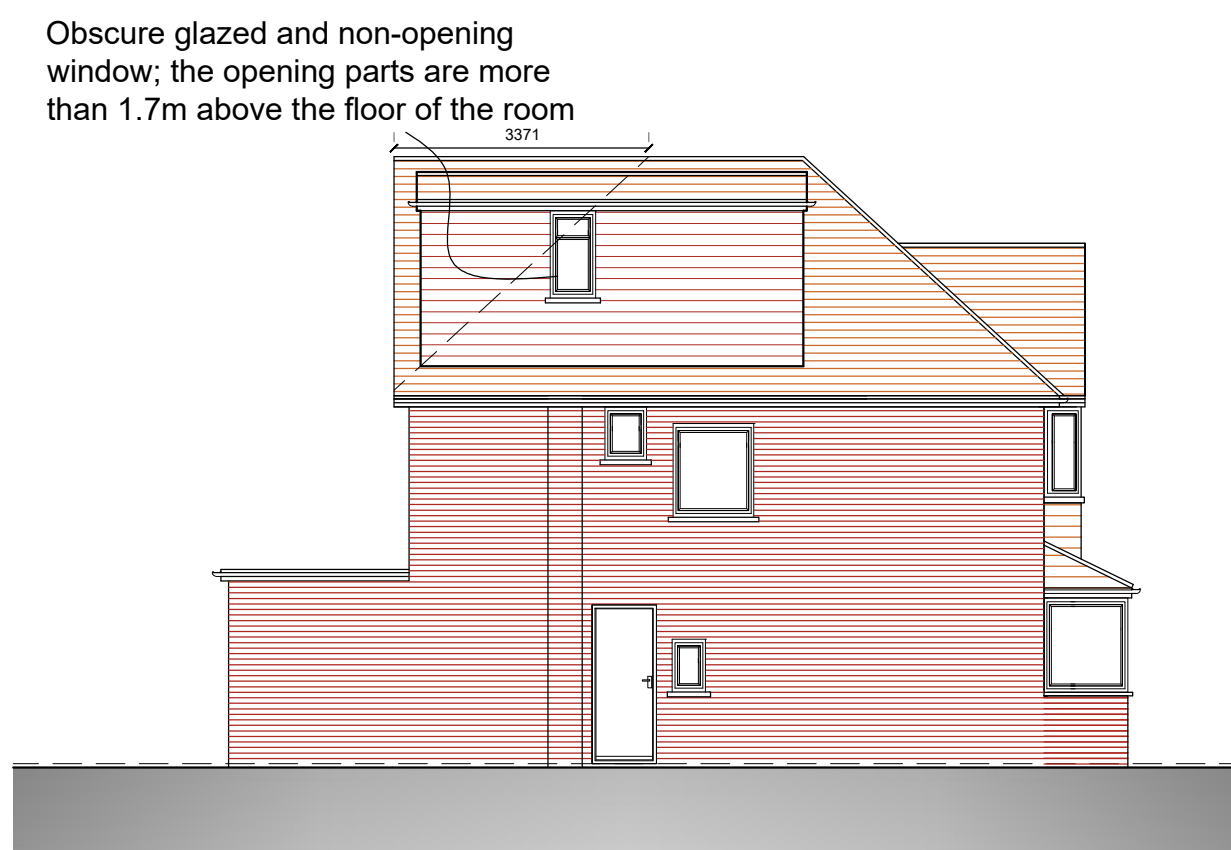

North West Elevation

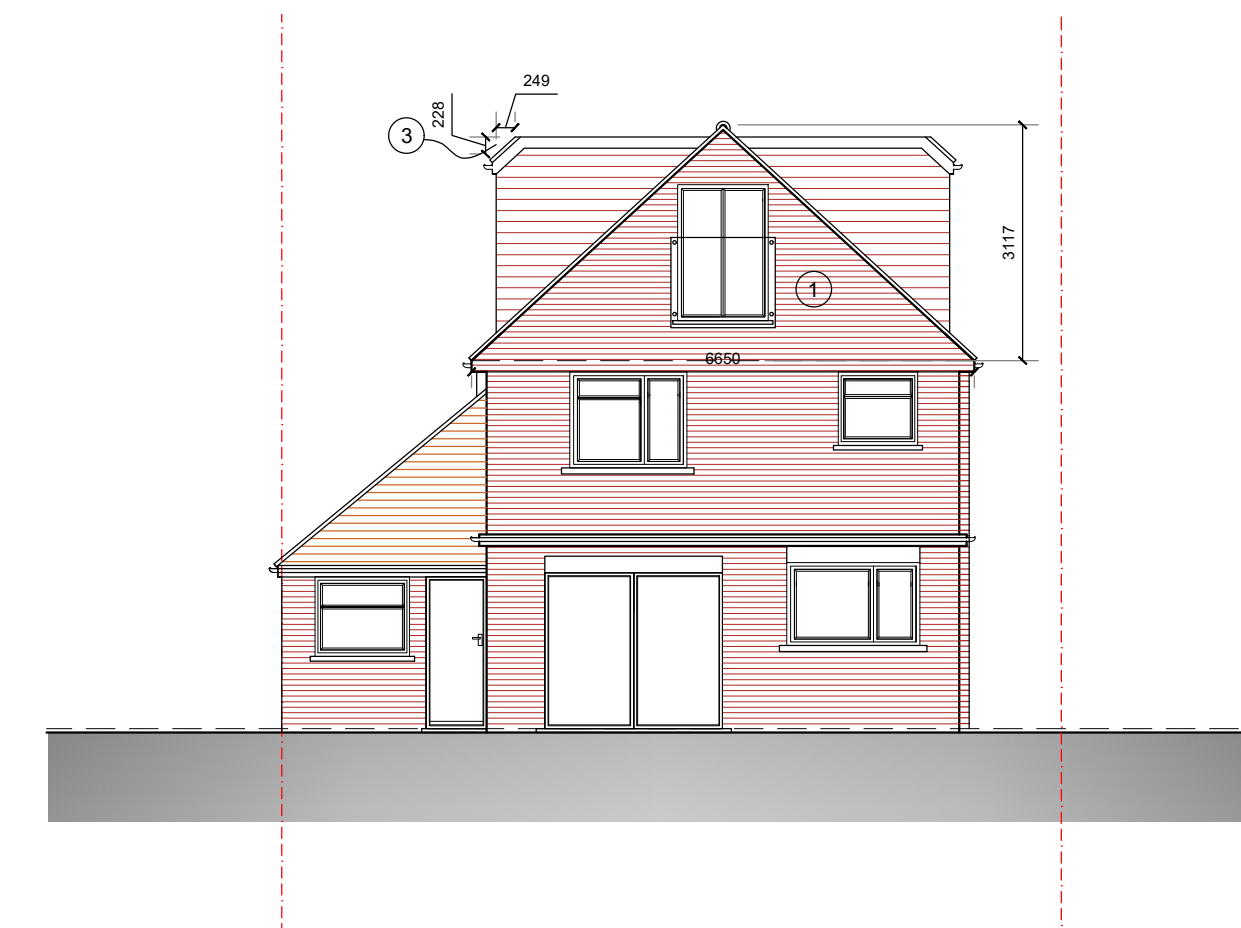

North East Elevation

#### VOLUME CALCULATION

##### PROPOSED GABLE

$$Vol_1 = \left( \frac{0.5 \times 6.65 \times 3.12 \times 3.37}{3} \right) = 11.65m^3$$

##### PROPOSED DORMER

$$Vol_2 = \left( \frac{2.83 \times 2.59 \times 5.06}{2} \right) \times 2 = 37.09m^3$$

$$Vol_3 = \left( \frac{0.25 \times 0.23 \times 5.06}{2} \right) \times 2 = 0.29m^3$$

##### TOTAL VOLUME PROPOSED:

$$Vol_1 + Vol_2 - Vol_3 = 11.65 + 37.09 - 0.29 = 48.5m^3$$


TOTAL VOLUME PROPOSED = 48.5m³  
LESS THAN THE 50m³ ALLOWED UNDER PERMITTED  
DEVELOPMENT FOR LOFT EXTENSIONS

#### PROPOSED ELEVATIONS

42 Greenacres Avenue, Ickenham,  
Middlesex, UB10 8HH

Scale Bar

1:100 @ A2

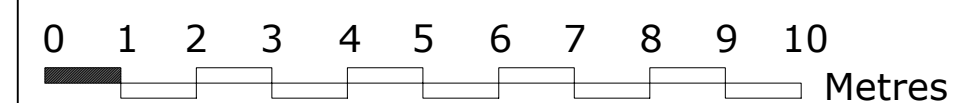

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Drg. No. 21/3478/37  
Scale 1:100  
Date 21/11/23  
Drawn by KH

REVISION

(C) drawer