

GENERAL NOTES:
 1. ALL DIMENSIONS ARE IN MILLIMETER.
 2. VERIFY ALL DIMENSIONS AND CONDITIONS BEFORE BUILDING OR
 STARTING CONSTRUCTION. NOTIFY THE DESIGNER IMMEDIATELY OF ANY
 DISCREPANCY OR VARIATION.
 3. ALL WORK TO COMPLY WITH CURRENT BUILDING REGULATIONS
 AND CODES OF PRACTICE



Title:

Existing Floor Plans & Elevations

Site Address	Scale: 1:100 @A3	Revision Date:
50 Weymouth Road Hayes Middlesex UB4 8NF	Date: 03/10/2022	
	Drawing No.: 2022/134 -01	
	Drawn By:	
	FP	
	e:mail - faluckpatel@yahoo.com (M) +44 (0) 7871 466 254	

10 Meter
5
2
1
0
1:100

Faluck Patel

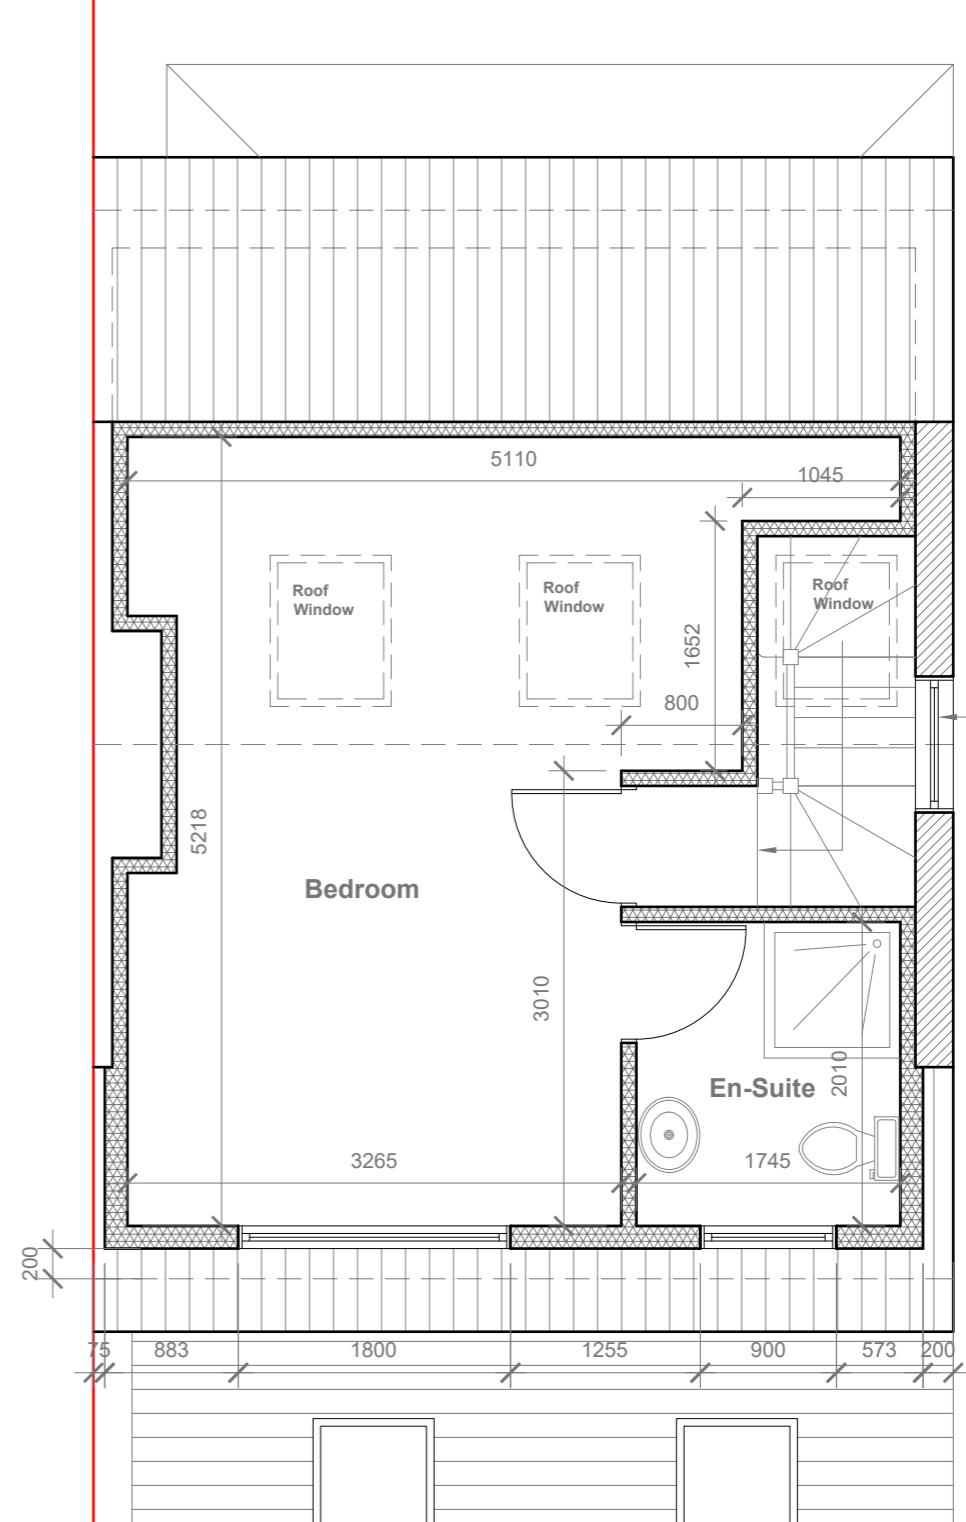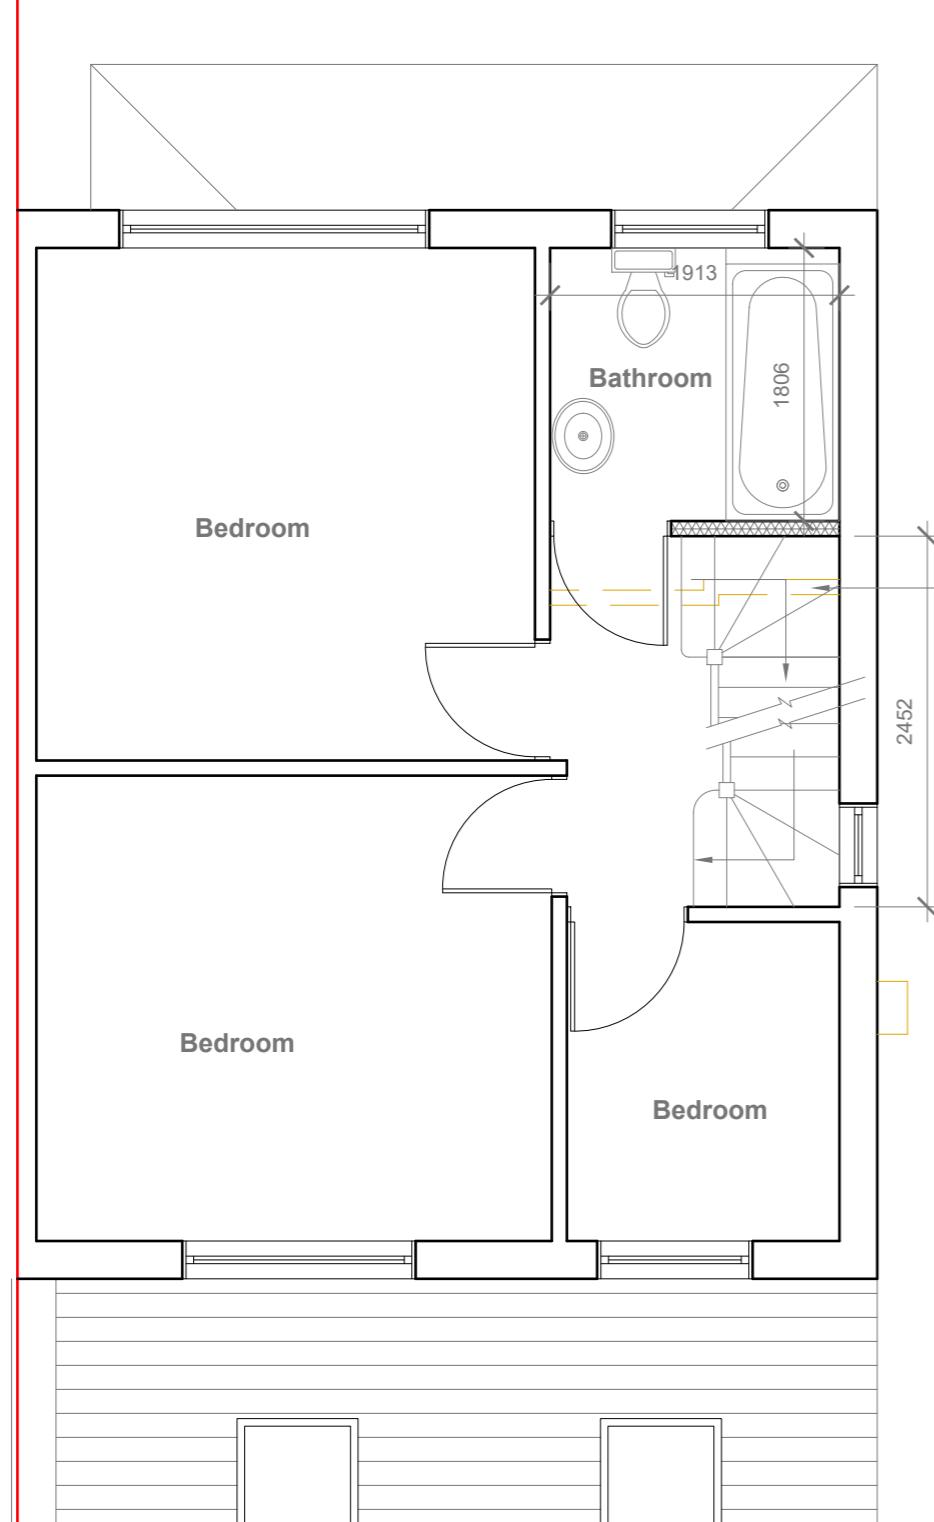

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Title:

Proposed First Floor & Loft Plan


Site Address
50 Weymouth Road
Hayes
Middlesex
UB4 8NF

Scale: 1:50 @A3
Date: 03/10/2022
Drawing No.: 2022/134 -02PD
Drawn By: FP


Revision Date:
e:mail - faluckpatel@yahoo.com
(M) +44 (0) 7871 466 254

1:50
0 1 2 5 Meter

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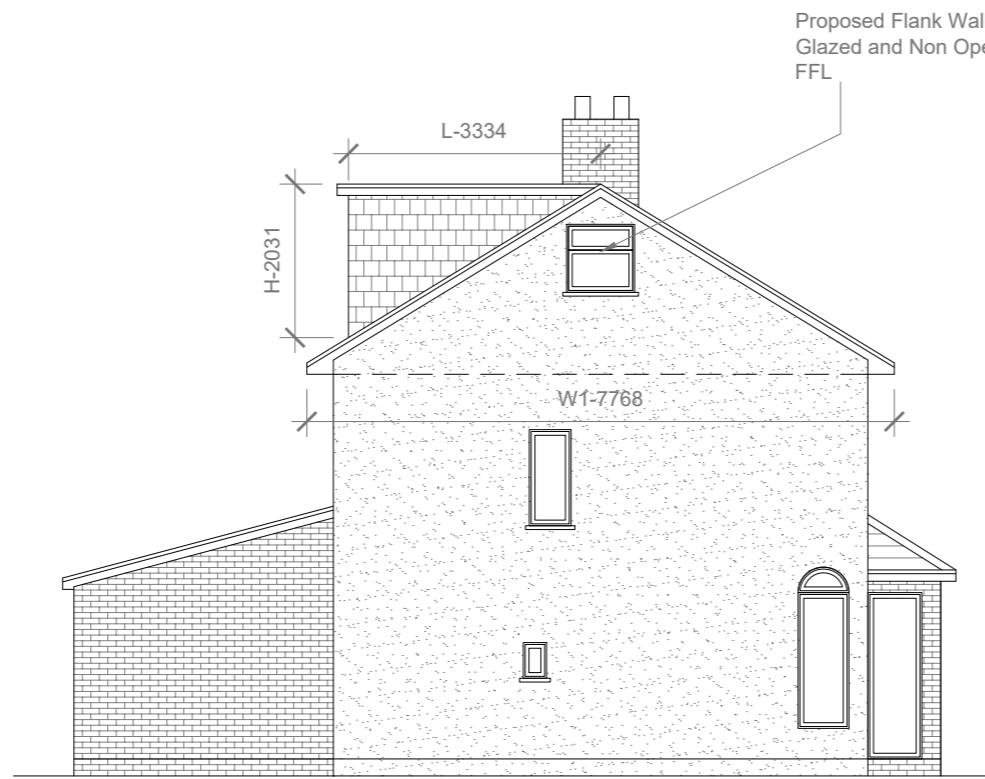
Proposed Front Elevation
Scale 1:100

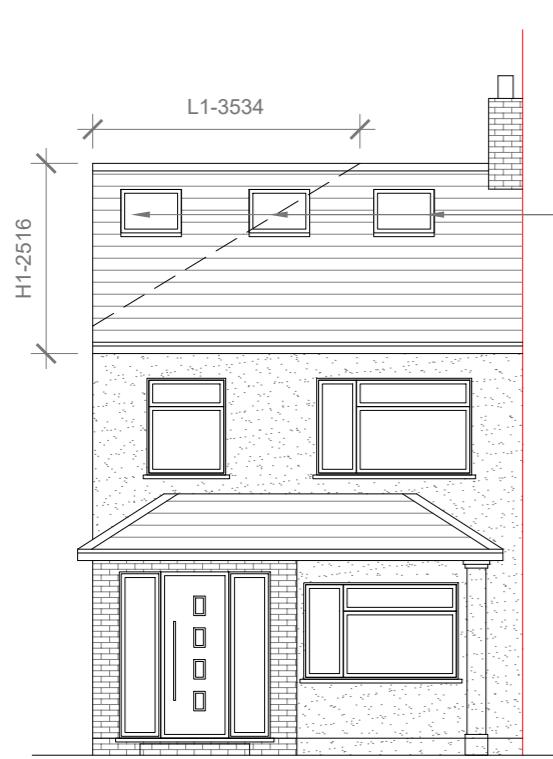

Proposed Side Elevation
Scale 1:100

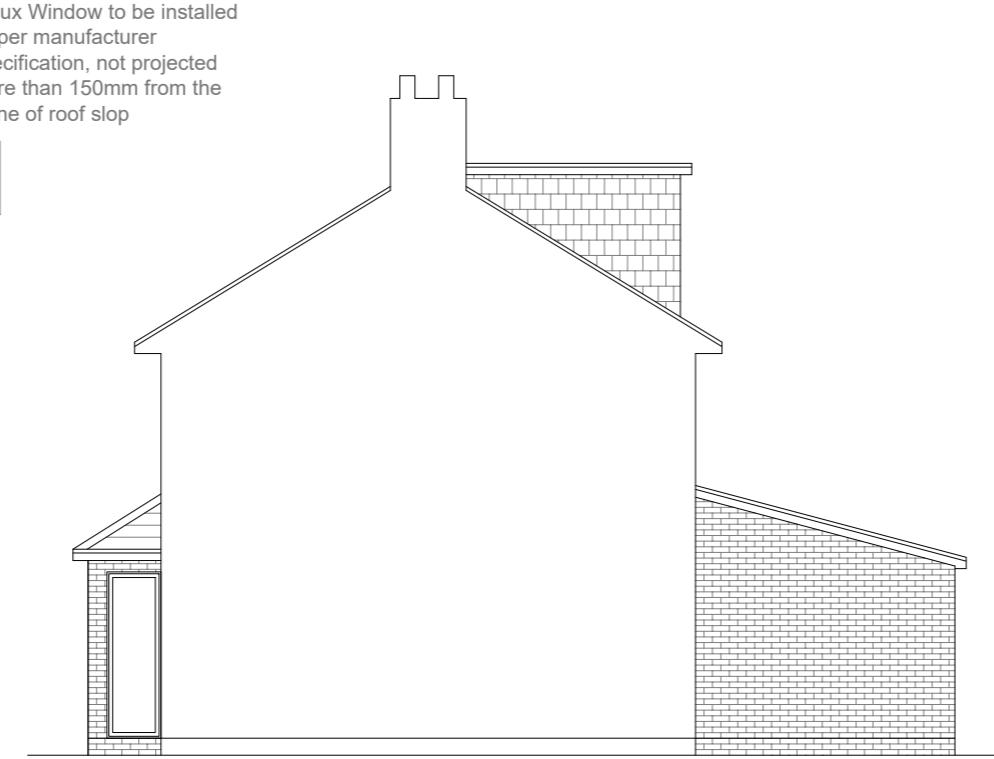

Proposed Rear Elevation
Scale 1:100



Proposed Side Elevation
Scale 1:100

Proposed External Finish Materials to Match Existing External Finish Materials

Proposed Flank Wall Window to be Obscure Glazed and Non Opening below 1.7m from FFL

REAR DORMER VOLUME = $W \times H \times L / 2$
 $5.410 \times 2.031 \times 3.334 / 2$
 $36.63 / 2$
 18.31 CU.MT.

HIP TO GABLE ROOF VOLUME = $W1 \times H1 \times L1 / 6$
 $7.768 \times 2.516 \times 3.534 / 6$
 $69.06 / 6$
 11.51 CU.MT.

TOTAL ROOF VOLUME = $V1 + V2$
 $18.31 + 11.51$
 $29.82 \text{ CU.MT.} < 50.00 \text{ CU.MT.}$

10 Meter
5
2
1
0

1:100

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Title:

Proposed Elevations

Site Address
50 Weymouth Road
Hayes
Middlesex
UB4 8NF

Scale: 1:100 @A3
Date: 03/10/2022
Drawing No.: 2022/134 -03PD
Drawn By: FP

Revision Date:
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