

GENERAL NOTES:
 1. ALL DIMENSIONS ARE IN MILLIMETER.
 2. VERIFY ALL DIMENSIONS AND CONDITIONS BEFORE BUILDING OR
 STARTING CONSTRUCTION. NOTIFY THE DESIGNER IMMEDIATELY OF ANY
 DISCREPANCY OR VARIATION.
 3. ALL WORK TO COMPLY WITH CURRENT BUILDING REGULATIONS
 AND CODES OF PRACTICE


Title:

Existing Floor Plans & Elevations


Site Address	Scale: 1:100 @A3	Revision Date:
50 Weymouth Road Hayes Middlesex UB4 8NF	Date: 03/10/2022	
	Drawing No.: 2022/134 -01	
	Drawn By:	
	FP	
	e:mail - faluckpatel@yahoo.com (M) +44 (0) 7871 466 254	

10 Meter
5
2
1
0
1:100

Faluck Patel

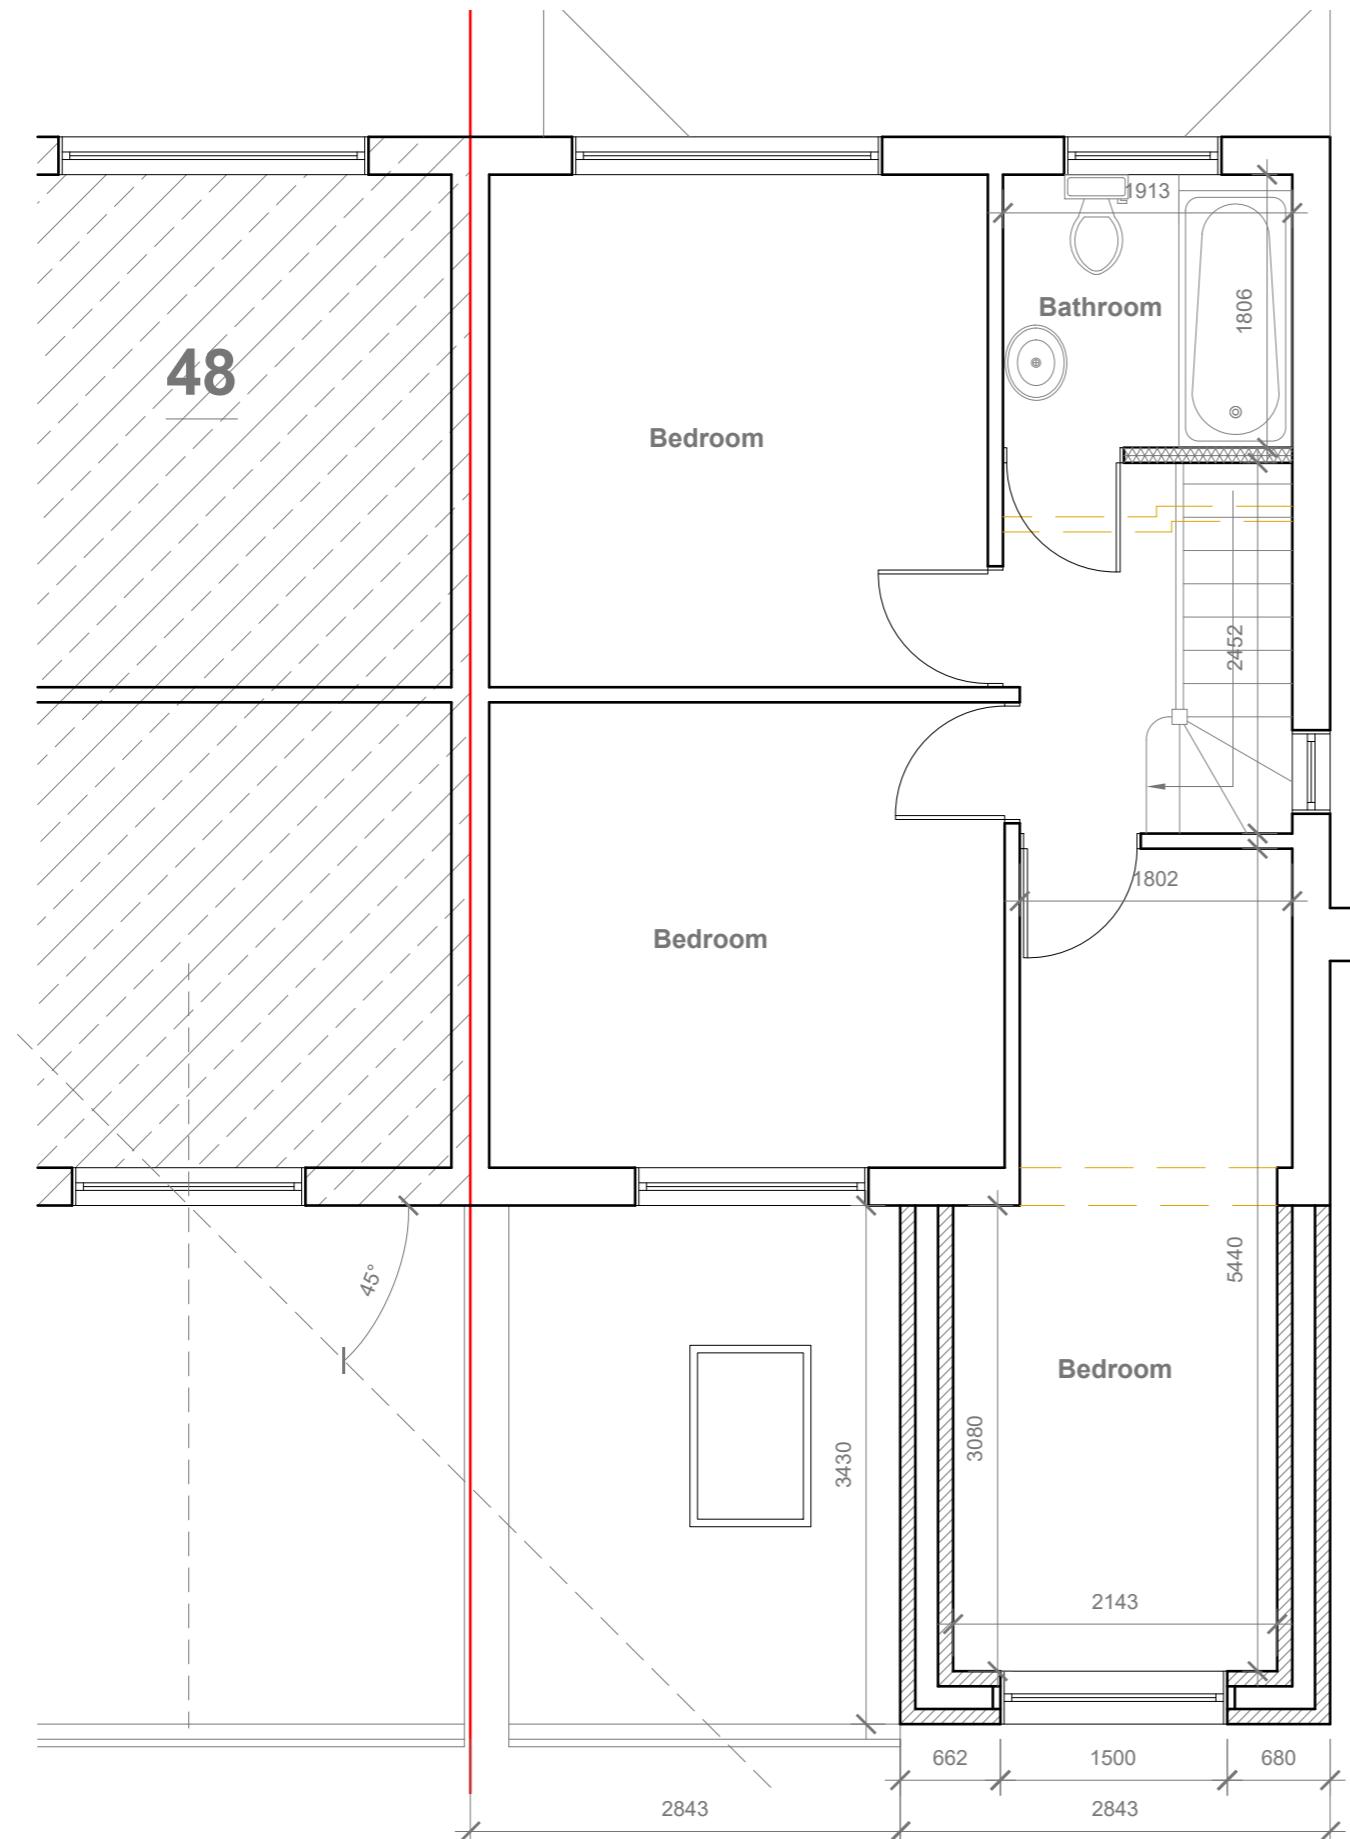

Proposed First Floor Plan
Scale 1:50

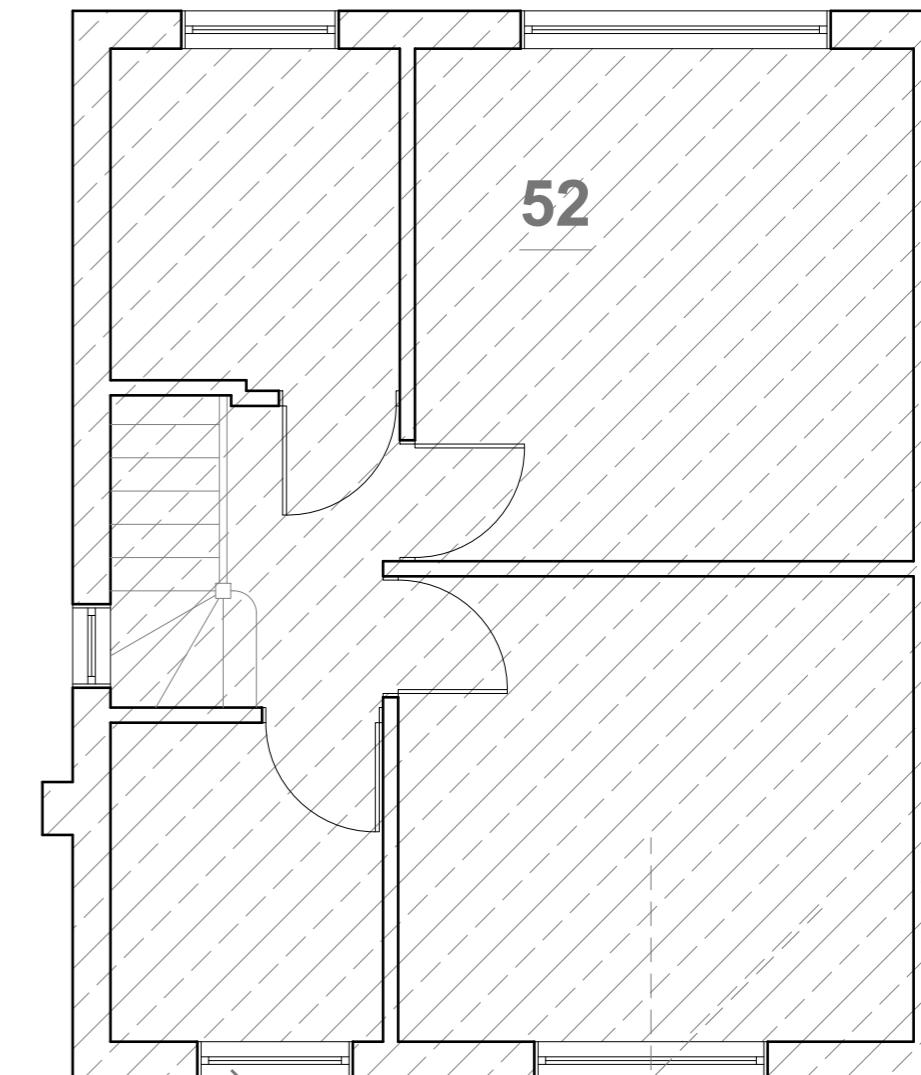

5 Meter

2

1:50
0

GENERAL NOTES:

1. ALL DIMENSIONS ARE IN MILLIMETER.
2. VERIFY ALL DIMENSIONS AND CONDITIONS BEFORE BUILDING OR STARTING CONSTRUCTION. NOTIFY THE DESIGNER IMMEDIATELY OF ANY DISCREPANCY OR VARIATION.
3. ALL WORK TO COMPLY WITH CURRENT BUILDING REGULATIONS AND CODES OF PRACTICE

Title:


Proposed First Floor Plan

Site Address
50 Weymouth Road
Hayes
Middlesex
UB4 8NF

Scale: 1:50 @A3
Date: 03/10/2022
Drawing No.: 2022/134 -02HH
Drawn By: FP


Revision Date:
e:mail - faluckpatel@yahoo.com
(M) +44 (0) 7871 466 254

Faluck Patel

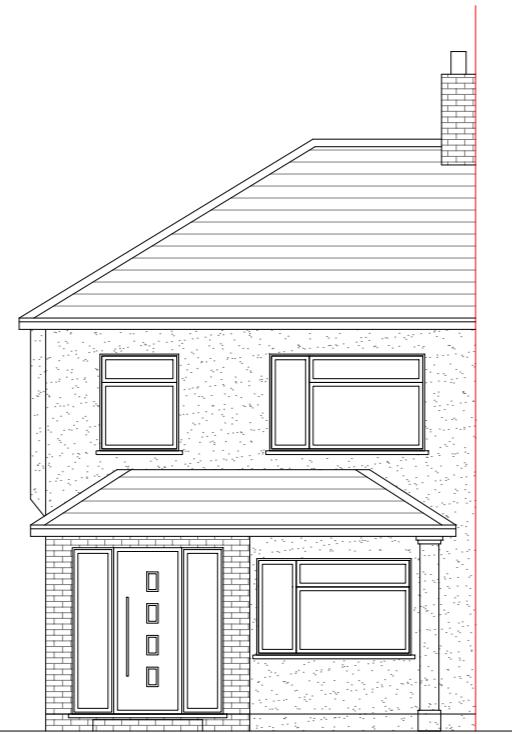

Proposed Front Elevation

Scale 1:100

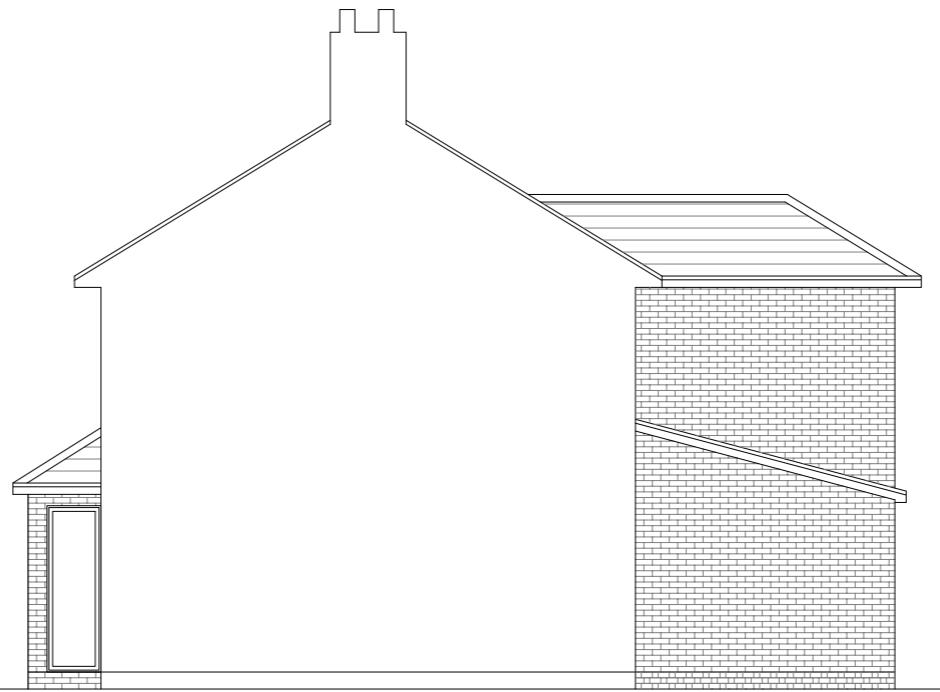

Proposed Side Elevation

Scale 1:100



Proposed Rear Elevation

Scale 1:100



Proposed Side Elevation

Scale 1:100

GENERAL NOTES:

1. ALL DIMENSIONS ARE IN MILLIMETER.
2. VERIFY ALL DIMENSIONS AND CONDITIONS BEFORE BUILDING OR STARTING CONSTRUCTION. NOTIFY THE DESIGNER IMMEDIATELY OF ANY DISCREPANCY OR VARIATION.
3. ALL WORK TO COMPLY WITH CURRENT BUILDING REGULATIONS AND CODES OF PRACTICE

Title:

Proposed Elevations

Site Address

Scale: 1:100 @A3

Revision Date:

50 Weymouth Road
Hayes
Middlesex
UB4 8NF

Date: 03/10/2022
Drawing No.:
2022/134 -03HH

A vertical scale bar for a 1:100 map. It features a top section labeled '10 Meter' and a bottom section labeled '1:100'. The scale is marked with horizontal lines at 0, 1, 2, and 5 meters. The segments between the marks are shaded differently: the 0-1m segment is light grey, the 1-2m segment is dark grey, the 2-5m segment is light grey, and the 5-10m segment is dark grey.

Faluck Patel