

VISUAL SCALE 1:50 @ A3

# Existing Ground Floor

#### GENERAL NOTES:

1. DO NOT SCALE FROM THE DRAWINGS
2. ALL DIMENTIONS ARE IN MILLIMETER.
3. VERIFY ALL DIMENSIONS AND CONDITIONS BEFORE BUILDING OR STARTING CONSTRUCTION
4. NOTIFY THE DESIGNER IMMEDIATELY OF ANY DISCREPANCY OR VARIATION.
5. ALL WORK TO COMPLY WITH CURRENT BUILDING REGULATIONS AND CODES OF PRACTICE.



NISABC@HOTMAIL.COM

+44 - 7951491310

PROJECT  
21 White Heart Avenue Uxbridge UB8 3EP  
SHEET  
Existing Ground Floor Plan


CLIENT		Mr Vinit Choudhary	
Date	Project number	Scale (@ A3)	
Issue Date	Project Number		
Drawn by	DRAWING NUMBER		REV
Author			
Checked by			
Checker	A101		



1

**Existing Front\_Elevation**

1 : 100

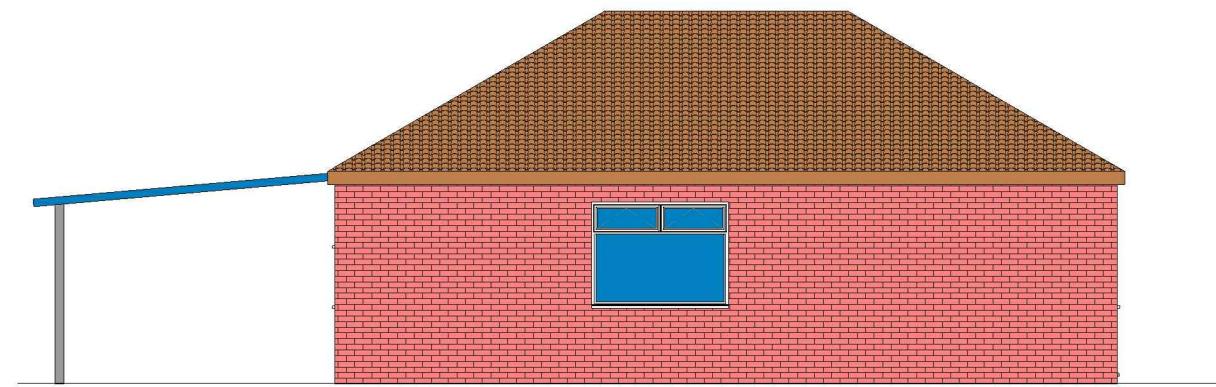


2

**Existing Side 01\_Elevation**

1 : 100



VISUAL SCALE 1:100 @ A3

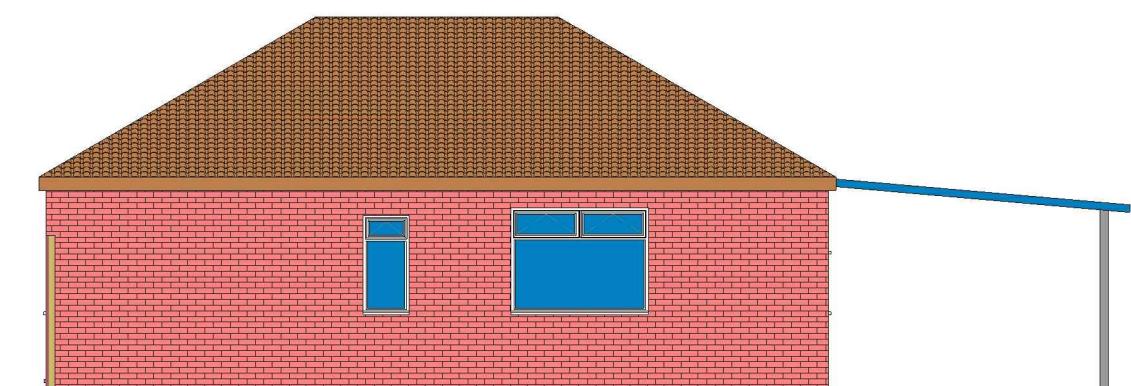

4

**Existing Side 02\_Elevation**

1 : 100



3

**Existing Rear\_Elevation**

1 : 100

GENERAL NOTES:

1. DO NOT SCALE FROM THE DRAWINGS
2. ALL DIMENTIONS ARE IN MILLIMETER.
3. VERIFY ALL DIMENSIONS AND CONDITIONS BEFORE BUILDING OR STARTING CONSTRUCTION.
4. NOTIFY THE DESIGNER IMMEDIATELY OF ANY DISCREPANCY OR VARIATION.
5. ALL WORK TO COMPLY WITH CURRENT BUILDING REGULATIONS AND CODES OF PRACTICE.

The existing partitions forming the protected staircase must provide half-hour fire resistance. They must be lined with 12.5mm plasterboard and skim

The doors to Bedrooms and any habitable rooms and the final exit door must not be fitted with a key on the inside. Thumb turns are acceptable

CM Carbon Monoxide Detector

Extract Vent

FD 30 Fire check doors 30 min fire resistance with smoke seal and self closing

HD Heat Detector comply with BS 5466 2:2016

Smoke alarm/detector to comply with BS EN14604

EL Emergency lights To be Installed in Accordance with BS5266: 2016

Assembly Point

Foam 6 litre foam spray

Call Point

Fire Alarm System comply with BS 5839:Part 1:2017


**FIRE EXIT** Fire Exit Sign Comply with BS 5499

no. 19

rear extension

shed

Boundary

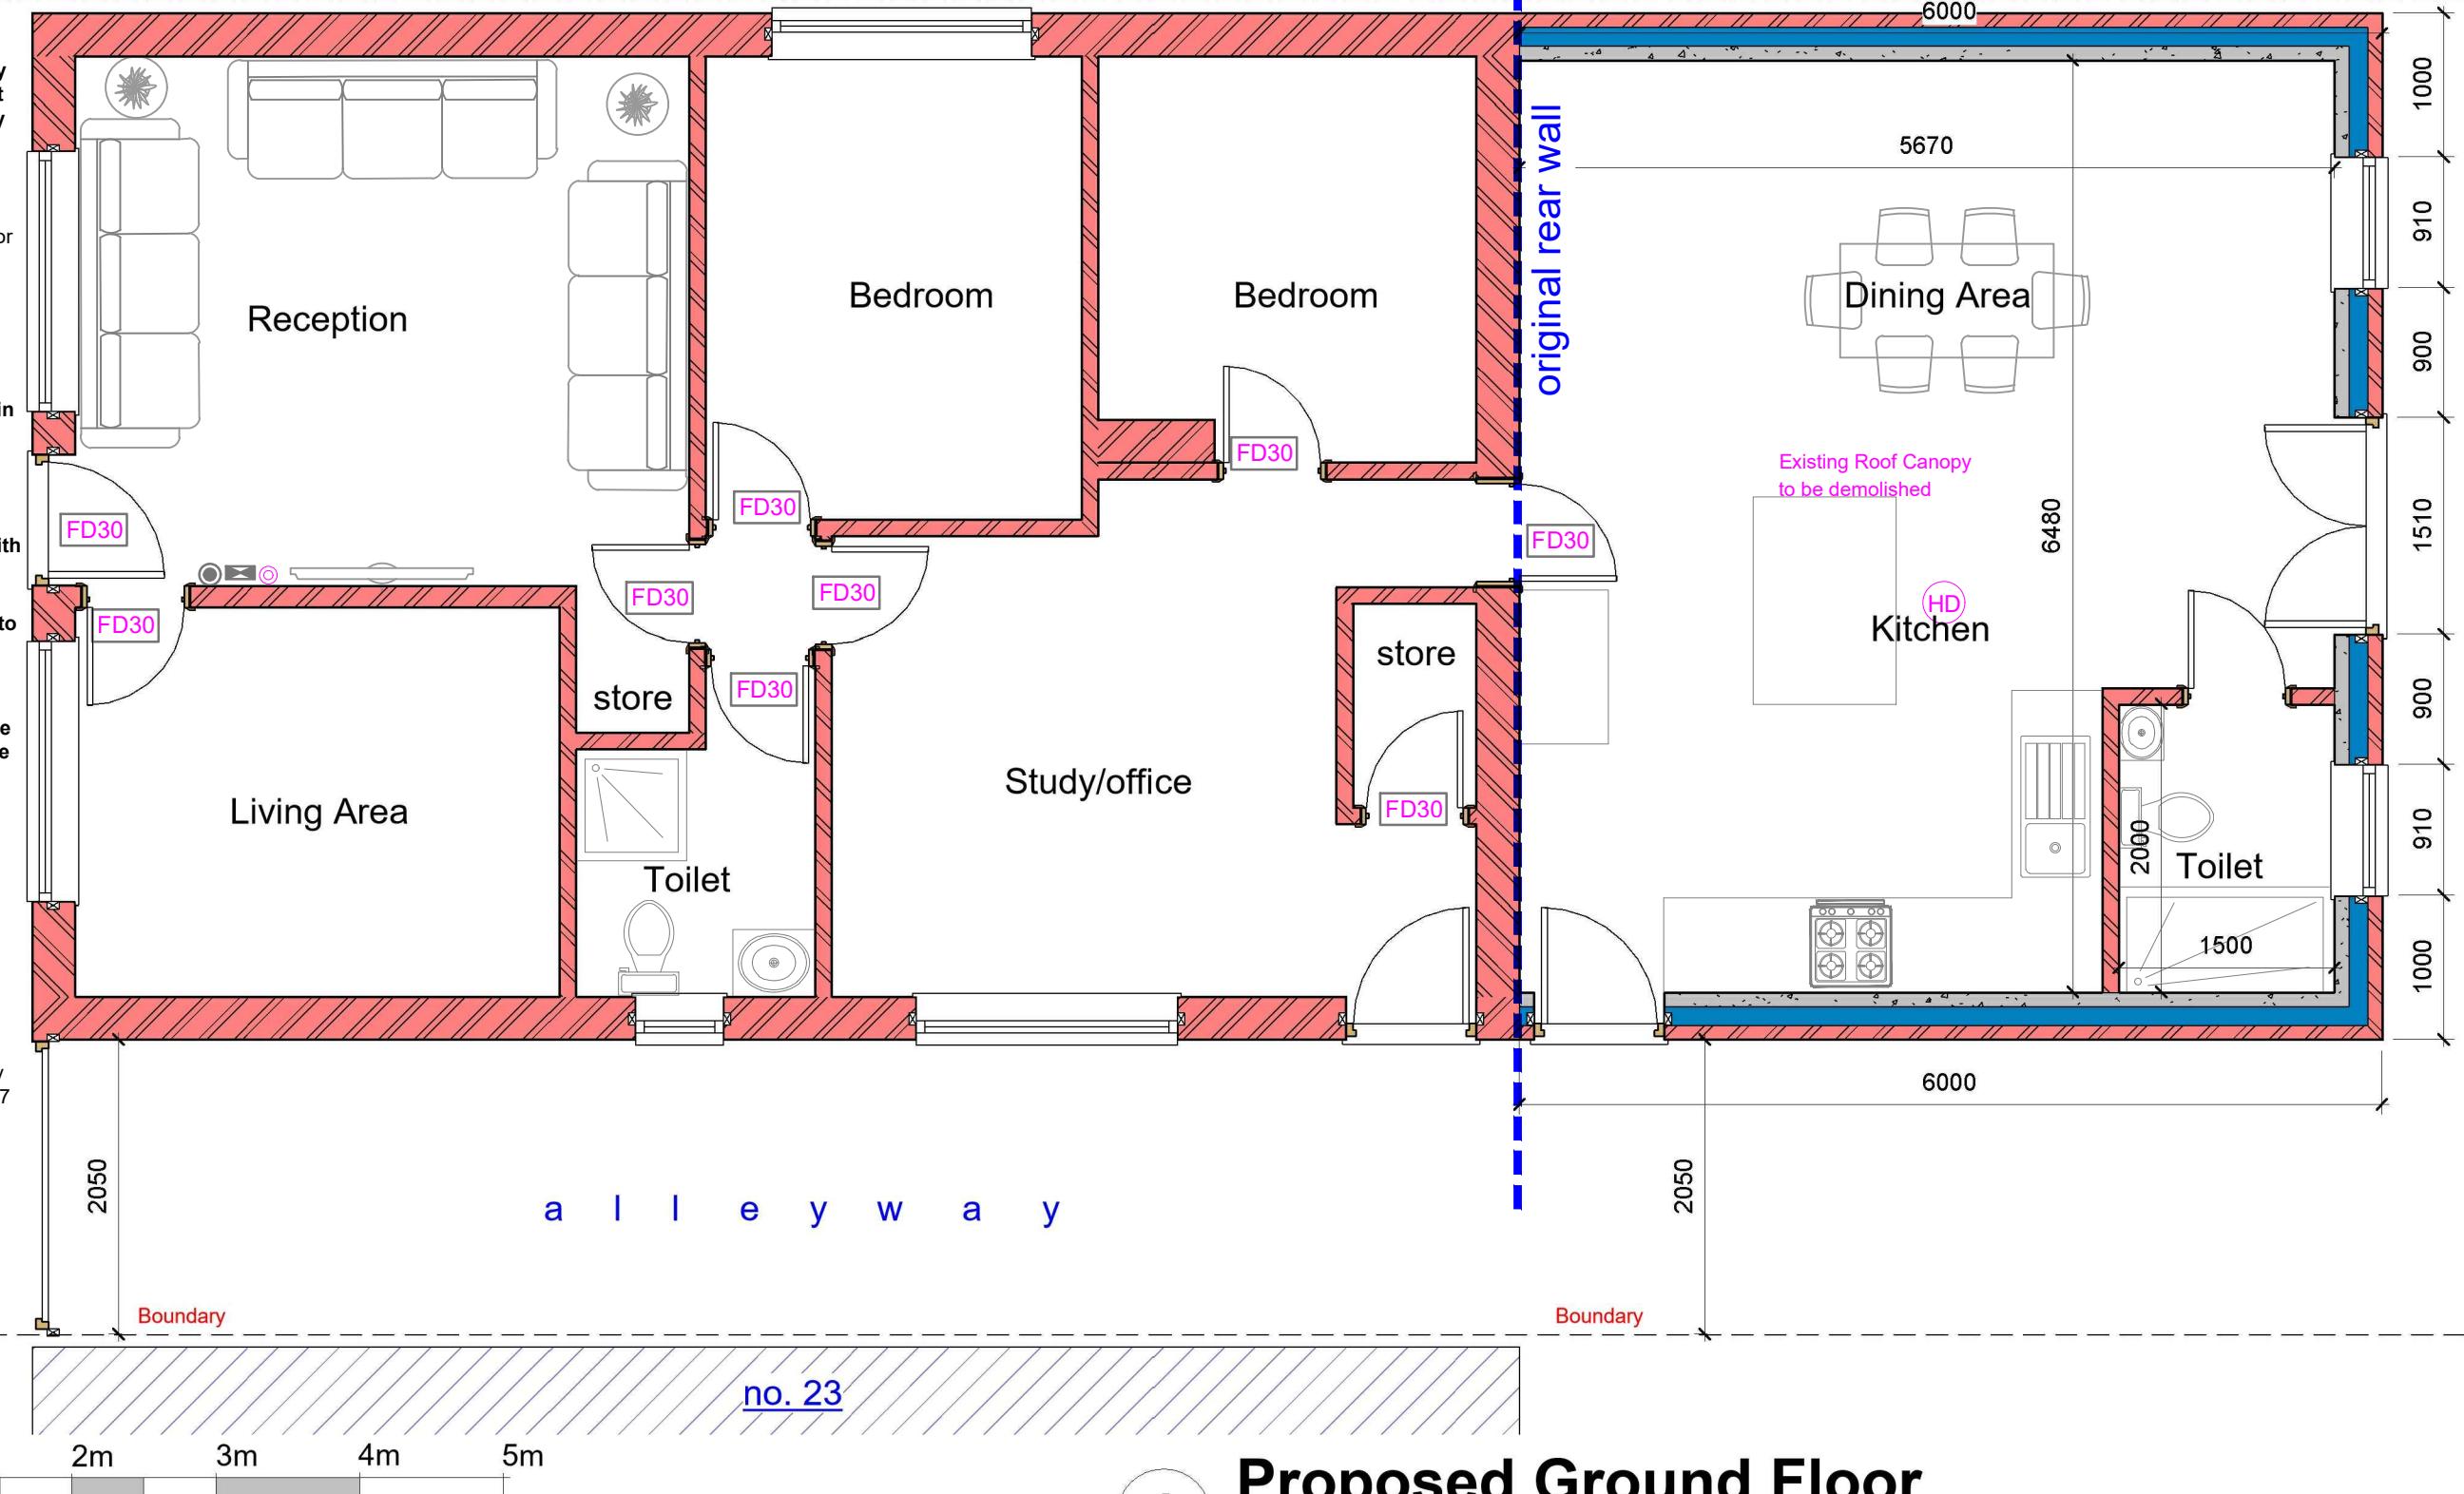


1

# Proposed Ground Floor


1 : 50

#### GENERAL NOTES:

1. DO NOT SCALE FROM THE DRAWINGS
2. ALL DIMENSIONS ARE IN MILLIMETER.
3. VERIFY ALL DIMENSIONS AND CONDITIONS BEFORE BUILDING OR STARTING CONSTRUCTION.
4. NOTIFY THE DESIGNER IMMEDIATELY OF ANY DISCREPANCY OR VARIATION.
5. ALL WORK TO COMPLY WITH CURRENT BUILDING REGULATIONS AND CODES OF PRACTICE.

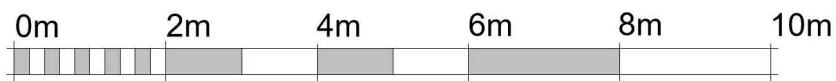

VISUAL SCALE 1:100 @ A3

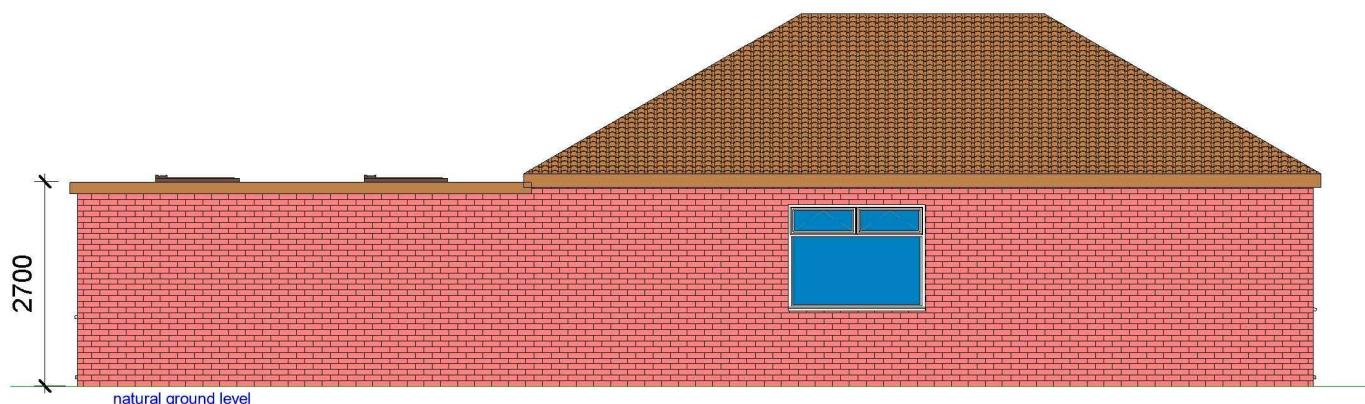

**1 Proposed Side 01\_Elevation**  
1 : 100



**2 Proposed Front\_Elevation**  
1 : 100

ALL PROPOSED MATERIALS/FINISHED TO MATCH WITH EXISTING.




**3 Proposed Rear\_Elevation**  
1 : 100



**4 Proposed Side 02\_Elevation**  
1 : 100

GENERAL NOTES:

1. DO NOT SCALE FROM THE DRAWINGS
2. ALL DIMENSIONS ARE IN MILLIMETER.
3. VERIFY ALL DIMENSIONS AND CONDITIONS BEFORE BUILDING OR STARTING CONSTRUCTION.
4. NOTIFY THE DESIGNER IMMEDIATELY OF ANY DISCREPANCY OR VARIATION.
5. ALL WORK TO COMPLY WITH CURRENT BUILDING REGULATIONS AND CODES OF PRACTICE.

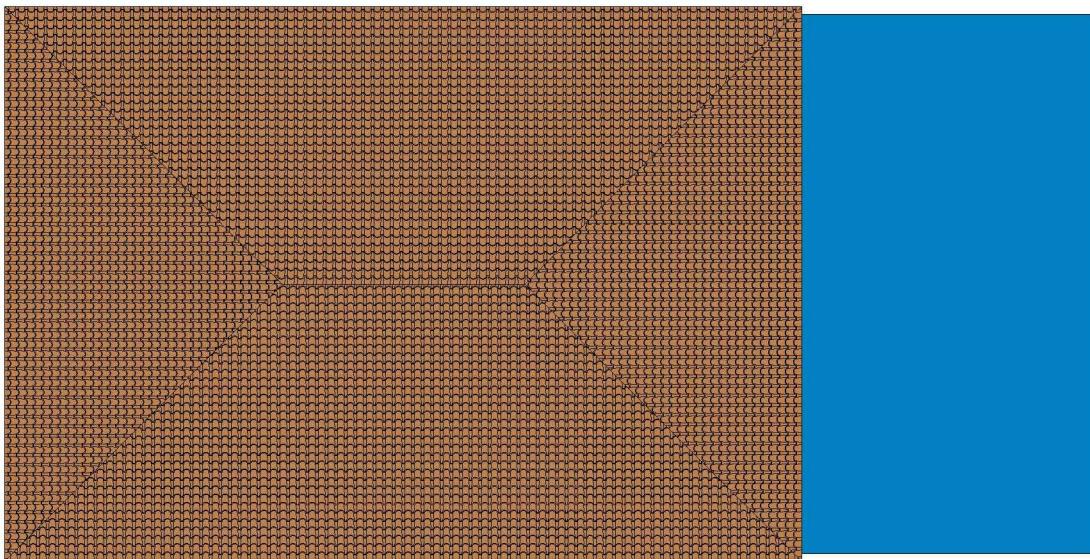


VISUAL SCALE 1:100 @ A3




VISUAL SCALE 1:75 @ A3


**1 Existing Roof**  
1 : 100

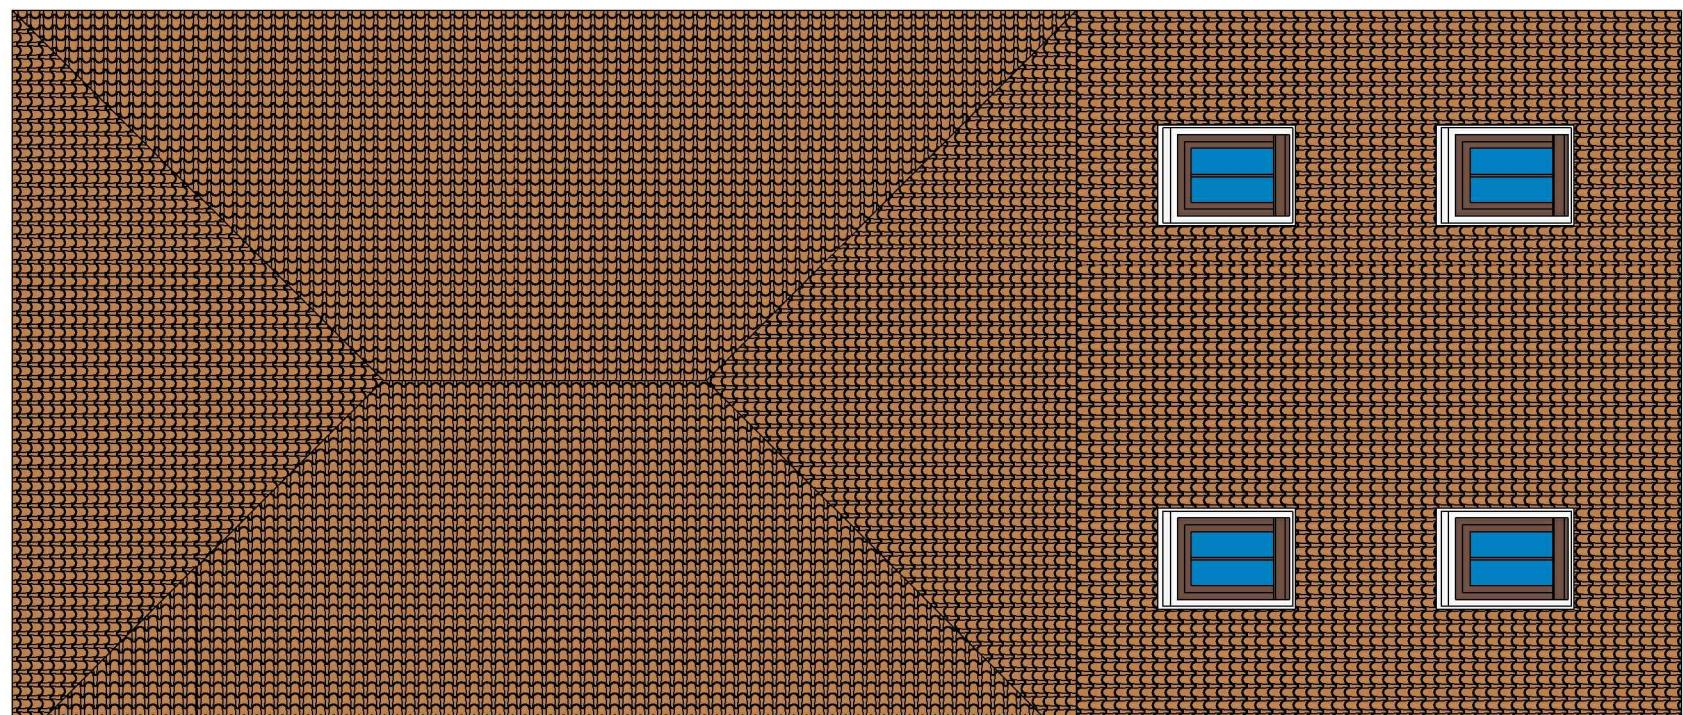

**2 Proposed Roof**  
1 : 75

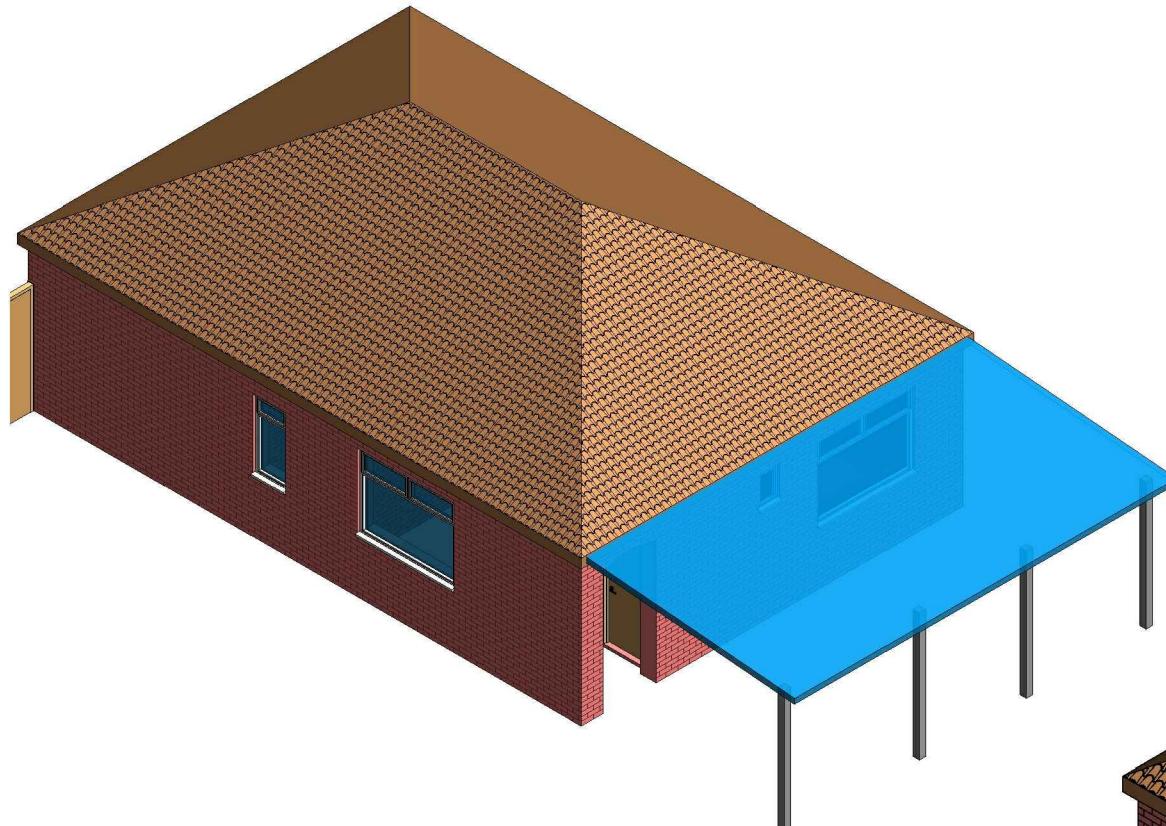

1 3D View 01 Existing

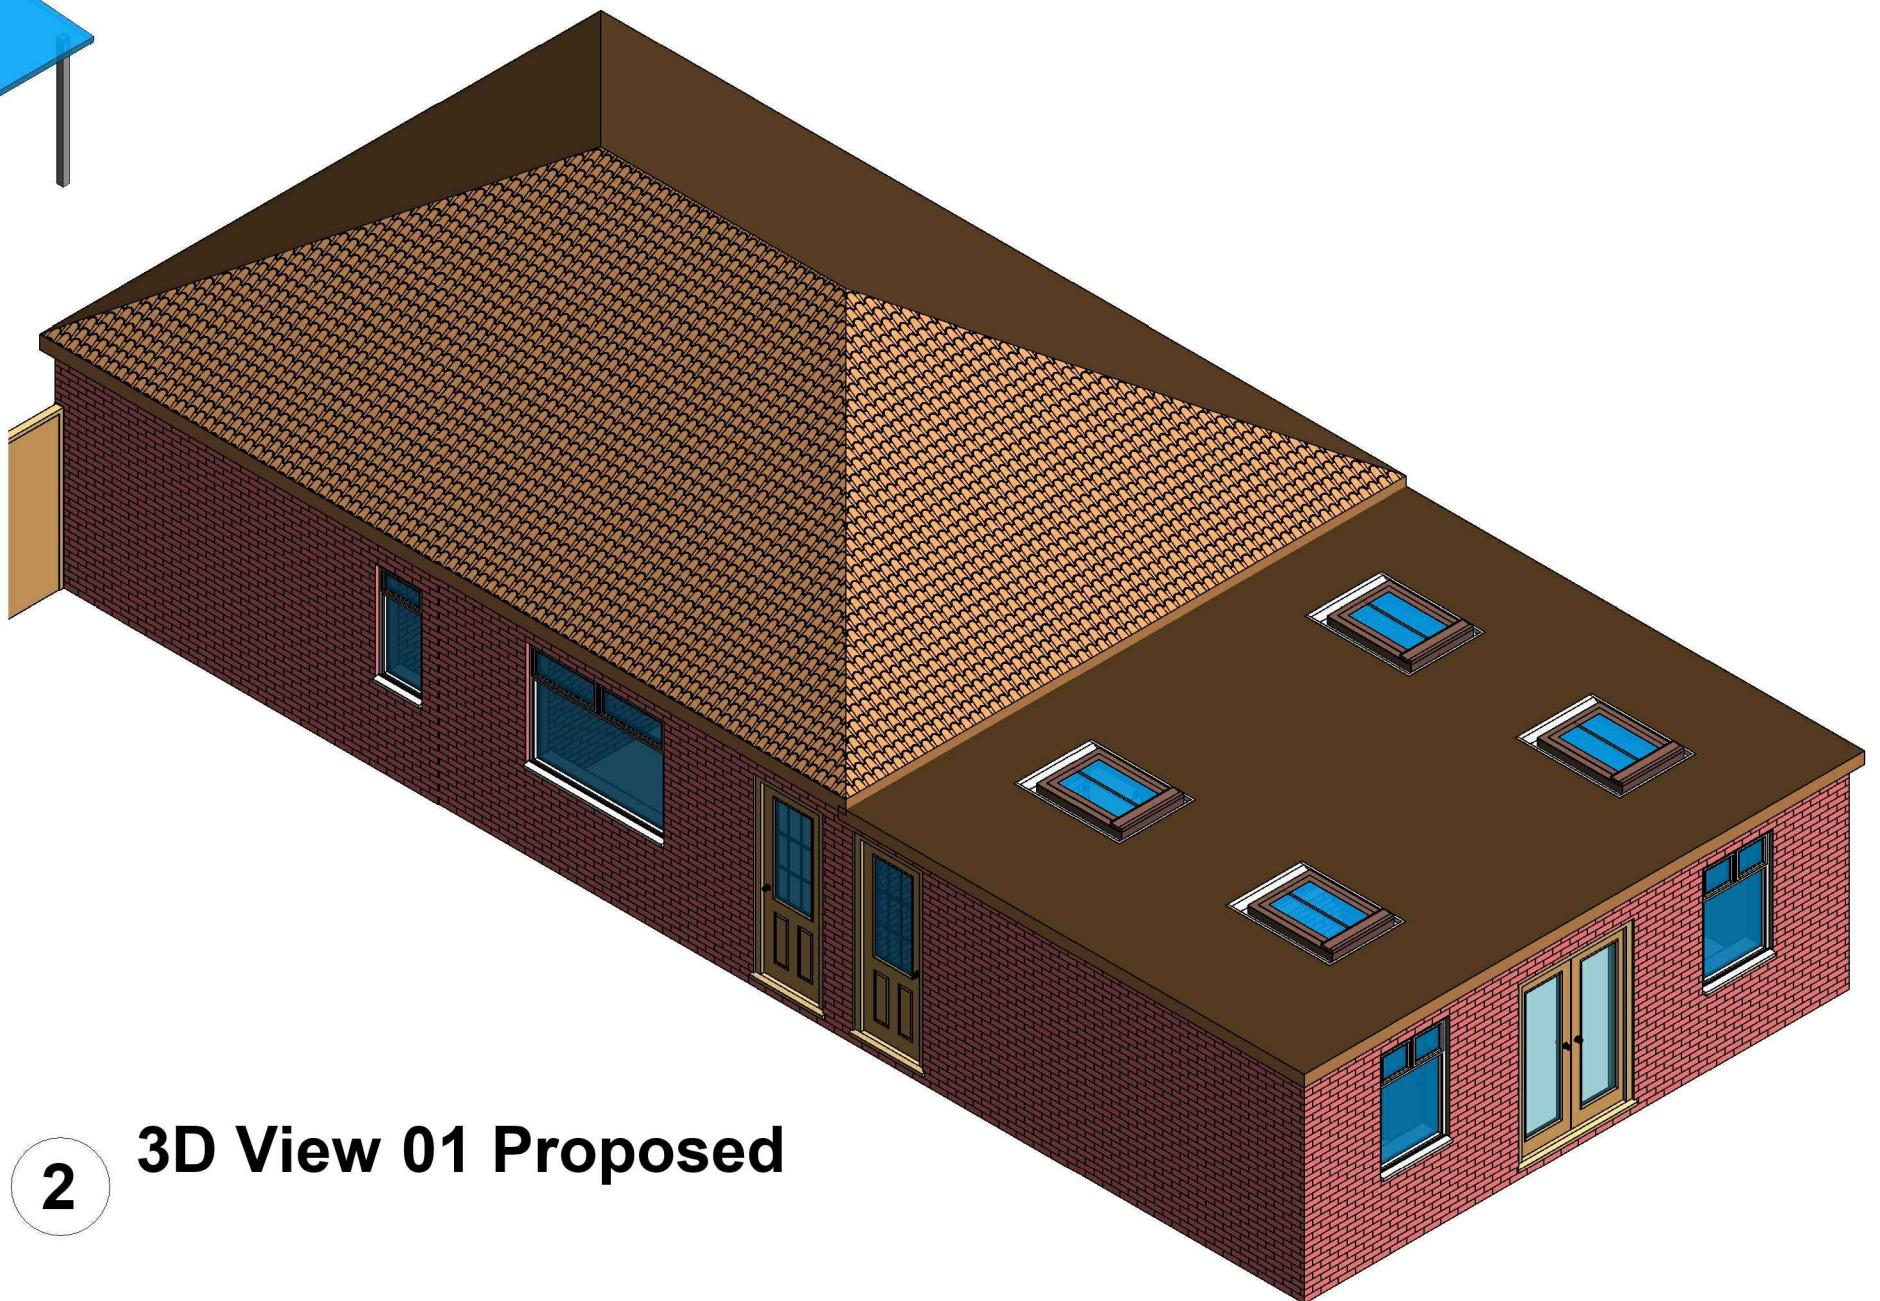

2 3D View 01 Proposed

GENERAL NOTES:

1. DO NOT SCALE FROM THE DRAWINGS
2. ALL DIMENSIONS ARE IN MILLIMETER.
3. VERIFY ALL DIMENSIONS AND CONDITIONS BEFORE BUILDING OR STARTING CONSTRUCTION.
4. NOTIFY THE DESIGNER IMMEDIATELY OF ANY DISCREPANCY OR VARIATION.
5. ALL WORK TO COMPLY WITH CURRENT BUILDING REGULATIONS AND CODES OF PRACTICE.