




PROPOSED FRONT ELEVATION  
SCALE 1:100

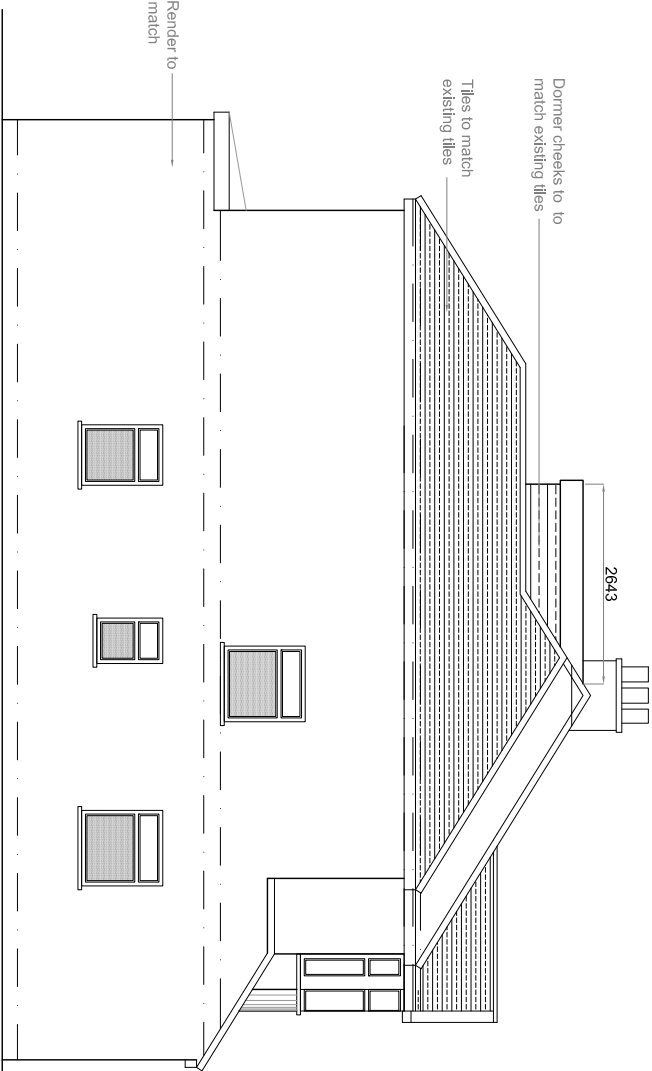

PROPOSED SIDE ELEVATION  
SCALE 1:100

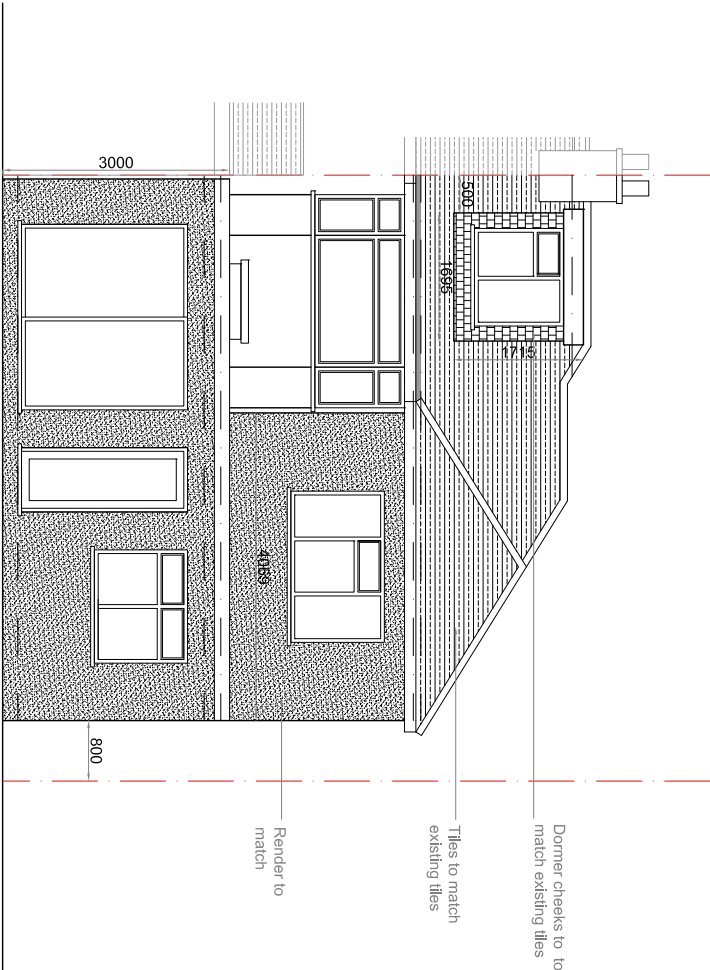

PROPOSED REAR ELEVATION  
SCALE 1:100

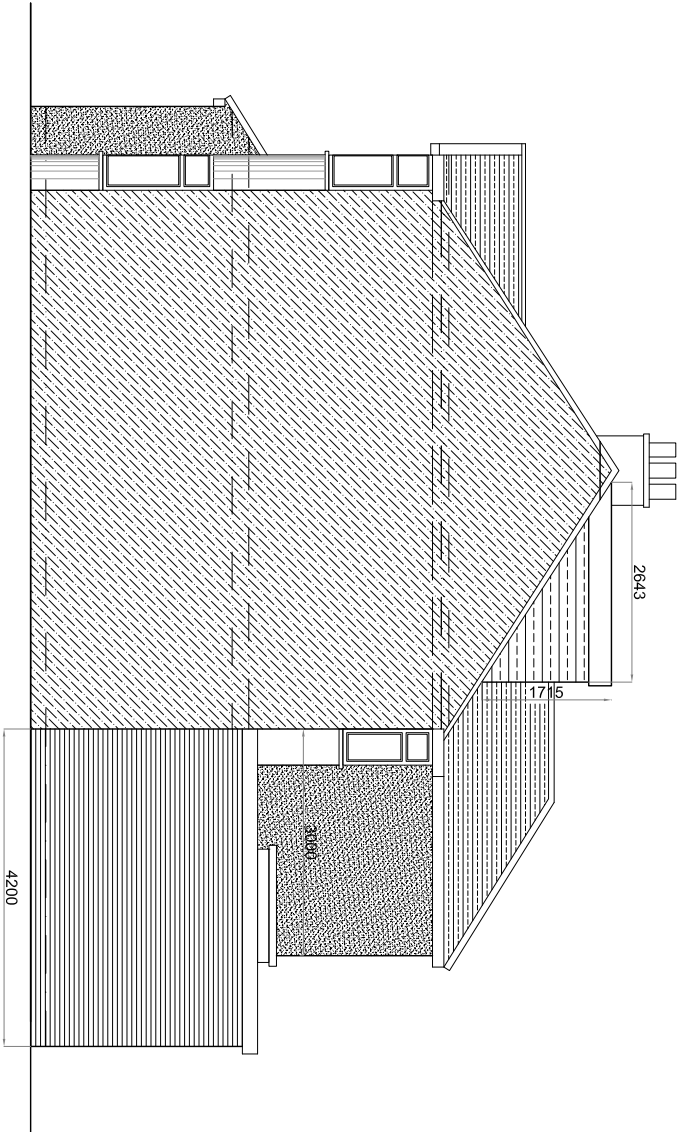

PROPOSED SIDE ELEVATION (VIEW FROM NO. 54)  
SCALE 1:100

GENERAL NOTES		PROJECT		DRAWING TITLE	
All dimensions, levels, sizes, positions and locations of particulars as indicated on drawings are to be verified by the appointed Contractor on site prior to engaging in works.		56 GLAMS CRESCENT UBRIDGE UB3 1QB		PROPOSED ELEVATIONS	
Any discrepancies must be reported to the Architect/Surveyor/Engineer or responsible persons immediately.		15 Derwent Avenue, Pinner, HAs 4QH dshah@shahdesignltd.co.uk www.shahdesignltd.co.uk		DATE 16-09-2025	
No dimension to be scaled from the drawings for construction purposes unless otherwise indicated. All work is to comply with current Building Regulations.		The Gas and Boiler installations will be carried out by a suitably qualified CORGI registered gas engineer or equal approved. The Contractor is responsible for ensuring compliance with the CDM Regulations, and appropriate Health & Safety on site precautions.		SCALE 1:100@A3	
Part 1: Wall etc. Act 1996 would apply and contractor is to assure that no work is commenced until this formality is completed. The sole purpose of this drawing is the procurement of Planning Permission and Building Regulation approval and work is NOT to commence before such approvals. Where this drawing is used for the works, contractor should request at the time of tender, from the lender, full specification and schedule of work. To avoid any disputes, this schedule of works in conjunction with the drawings would be used to resolve matters. Contractor to assure and satisfy himself that necessary Planning permission and Building Regulations are approved before tendering or commencement of works.		The competent person is to send to the local authority, via the scheme provider, a self-certification certificate within 30 days of the electrical works completion. The client must receive both a copy of the self-certification and a BS7671 Electrical Installation Test Certificate. (Reg. P1)		DRAWN BY DS	
				CHECKED BY DS	
				REVISION	
				SD2540(P)04-A	