






E1 PROPOSED FRONT ELEVATION
Scale 1:100 @ A3

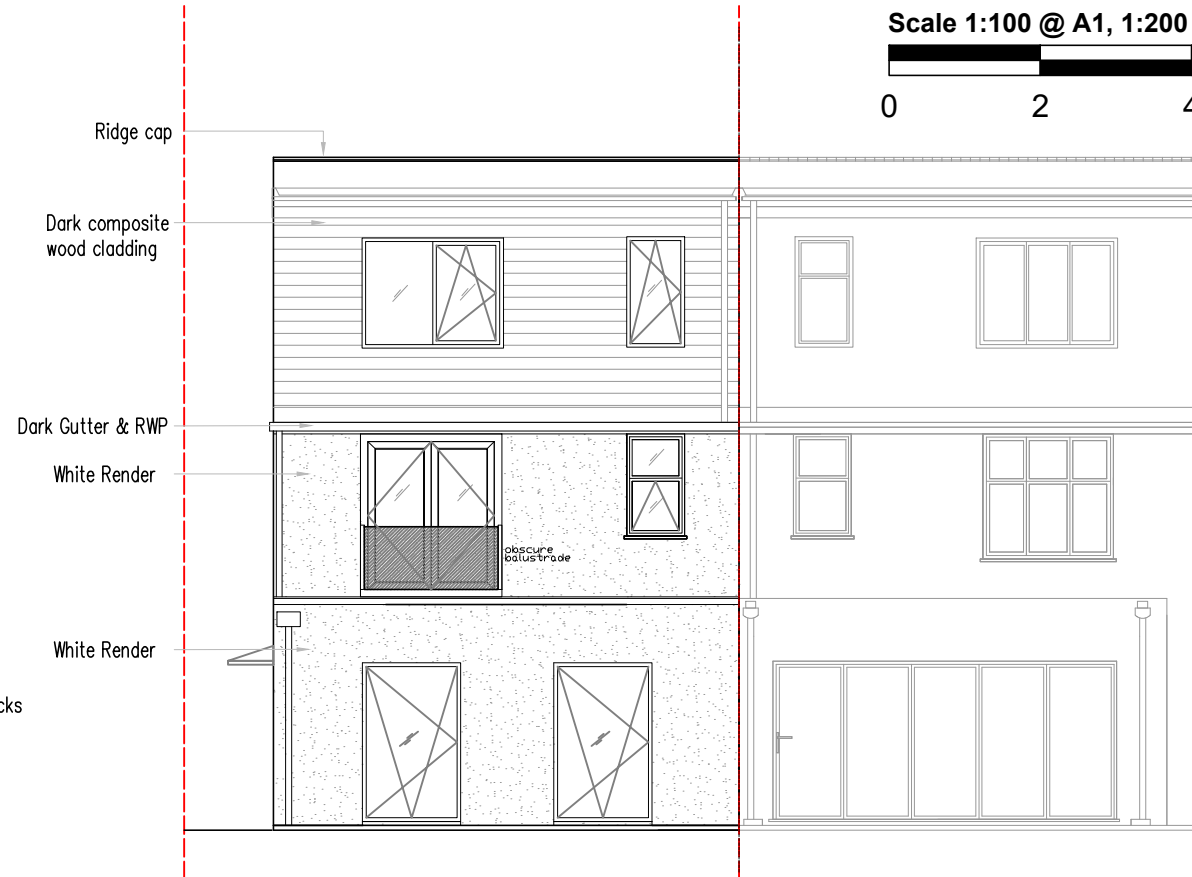


E2 PROPOSED REAR ELEVATION
Scale 1:100 @ A3

Scale 1:100 @ A1, 1:200 @ A3
0 2 4 6 8 10

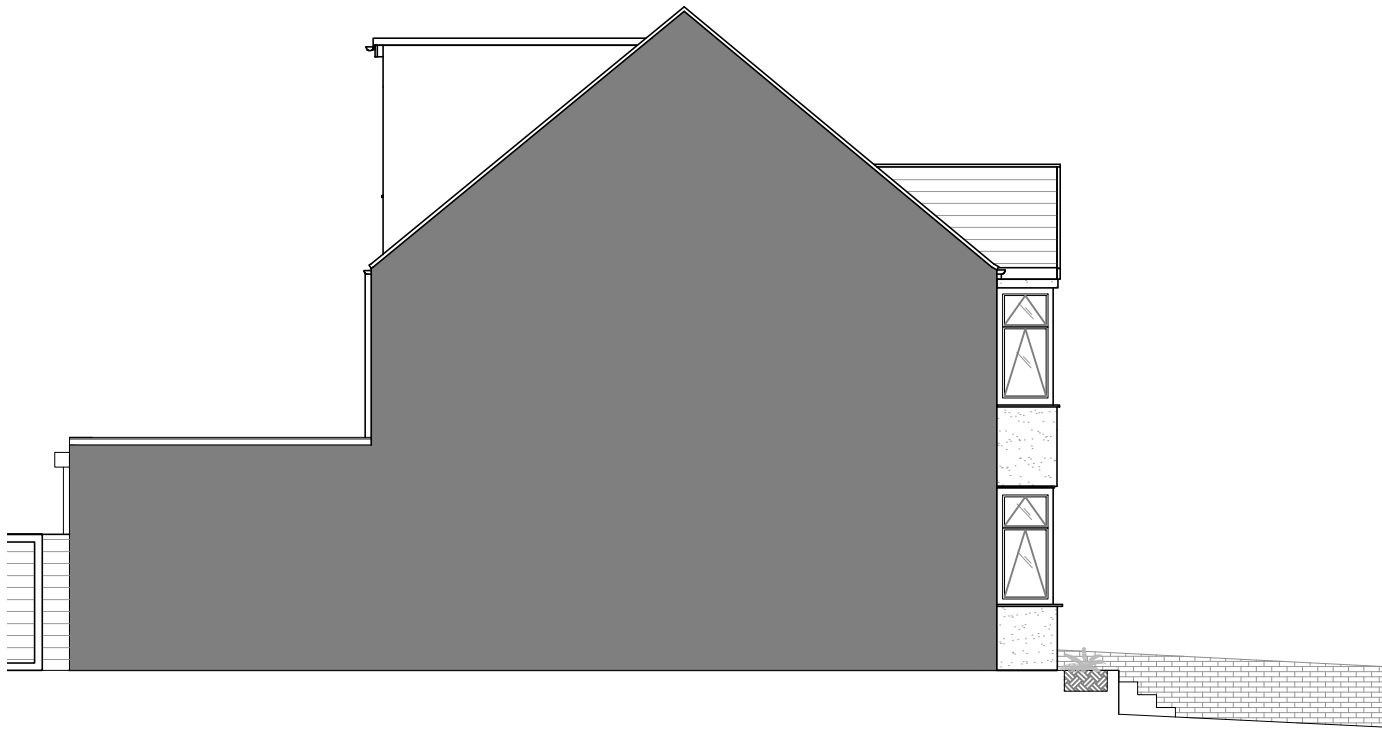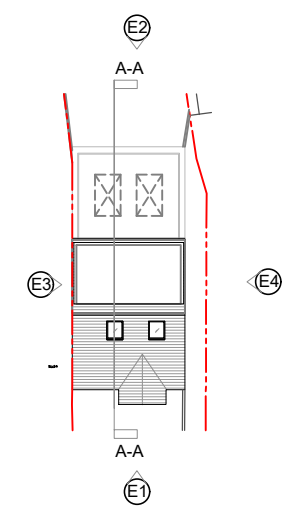

E3 PROPOSED SIDE ELEVATION
Scale 1:100 @ A3

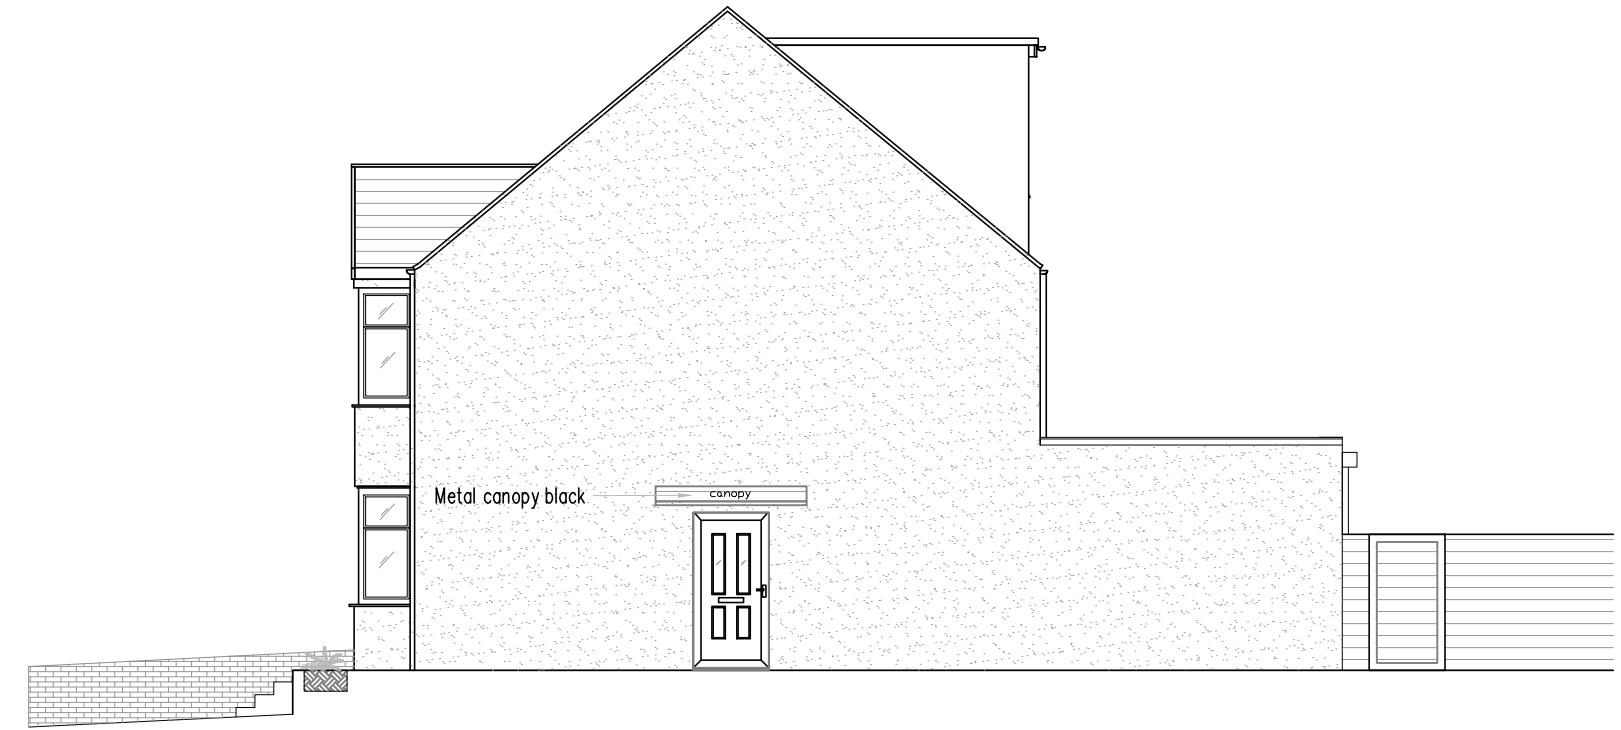

E4 PROPOSED SIDE ELEVATION
Scale 1:100 @ A3

The contractor is responsible for checking dimensions, tolerances and references. Any discrepancy to be verified with the Architect before proceeding with the works. Where an item is covered by drawings to different scales the larger scale drawing is to be worked to.

CDM REGULATIONS 2015. All current drawings and specifications for the project must be read in conjunction with the Designer's Hazard and Environment Assessment Record

Rev	Date	Description
-	29.06.25	Issue for planning application

Dwn	Ckd	Drawn	Checked	Date	Scale @ A3
JL	JL	JL	JL	JULY 2025	As indicated

**22 Hillingdon Hill, Uxbridge,
UB10 0JB**
Proposed Elevation

**AA1130-2003
REV -**

s2bstudio
20-22 Wenlock road
London N1 9GU

Do not scale drawing. Figured dimensions to be worked to in all cases. All intellectual property rights reserved. Drawings are based on surveyed drawings/OS maps and are to be further reviewed when on site or in stage of construction