

PROPOSED FRONT ELEVATION

PROPOSED REAR ELEVATION

TOTAL VOLUME CALCULATIONS (V1 +V2 +V3 + V4)


Dormer Volume V1  
Max height of Dormer = 2.5 m  
Projection of Dormer = 3.55 m  
Width of Dormer = 3.5 m  
External Volume of Dormer = (2.5 x 3.55 x 3.5)/2 = 15.53 m3

Dormer Volume V2  
Max height of Dormer = 2.5 m  
Projection of Dormer = 3.55 m  
Width of Dormer = 3.5 m  
External Volume of Dormer = (2.5 x 3.55 x 3.5)/2 = 15.53 m3


Hip to Gable end Volume V3  
(8.15 x 3.0 x 4.1)/6 x = 16.70 m3

Existing Front Dormer Volume DV1 = 1.52 m3

TOTAL VOLUME = 15.53+15.53+16.70+1.52= 49.28 m3

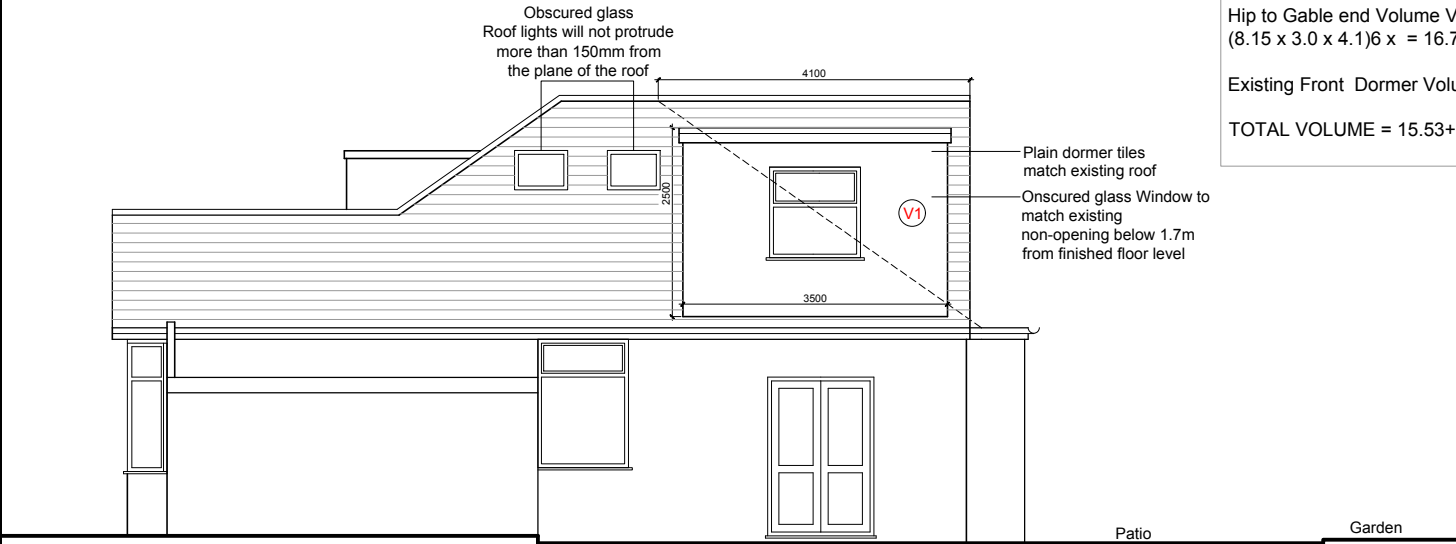

PROPOSED SIDE (RHS) ELEVATION

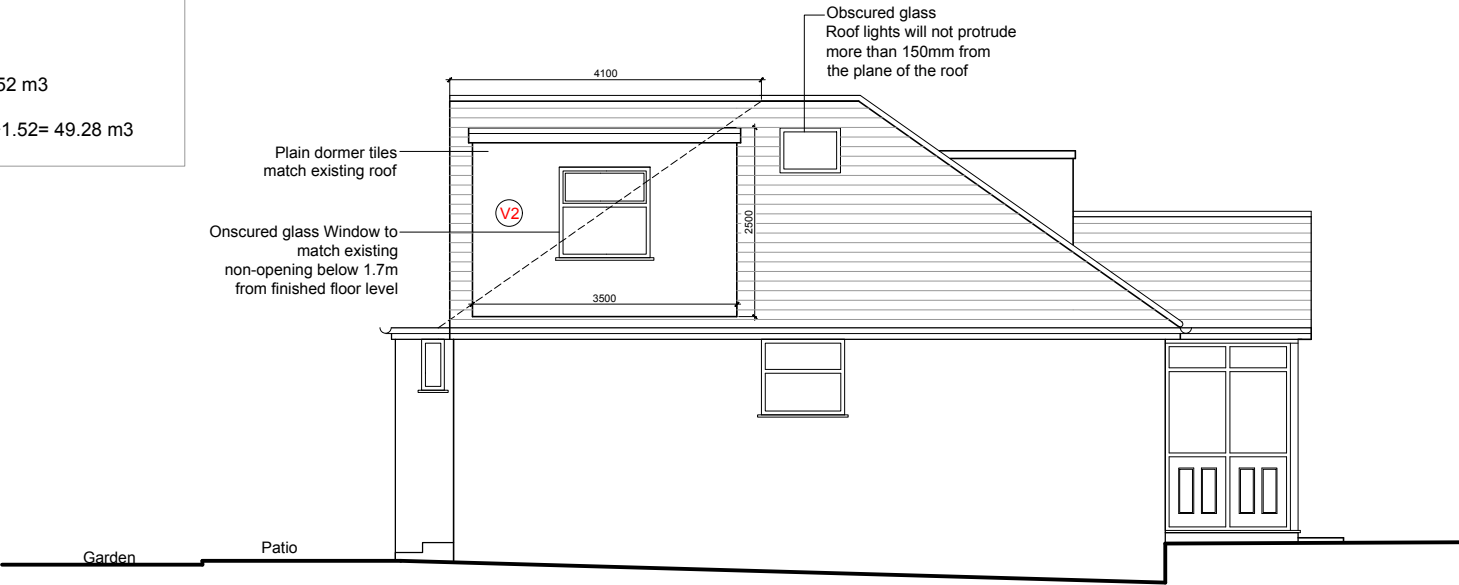

PROPOSED SIDE (LHS) ELEVATION

SCALE (m)

0 1 2 3 4 5

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IF THIS DRAWING EXCEEDS THE QUANTITIES TAKEN IN ANY WAY THE ARCHITECTURAL DESIGNER IS TO BE INFORMED BEFORE THE WORK IS INITIATED.

NOTES -

Job: 40 HILLSIDE ROAD NORTHWOOD HA6 1QA		
Dwg: PROPOSED ELEVATIONS		Scale: 1:100 on A3
Dwg No: LaVaastu/2025/539/06/Rev A	Date: 16/07/25	Drawn: S

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