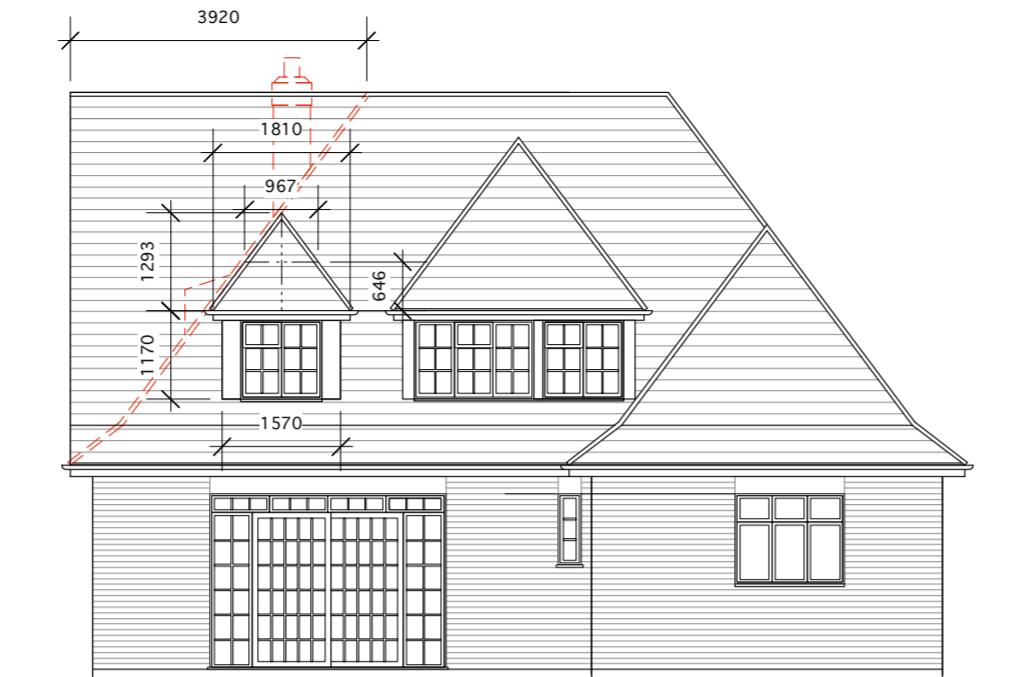
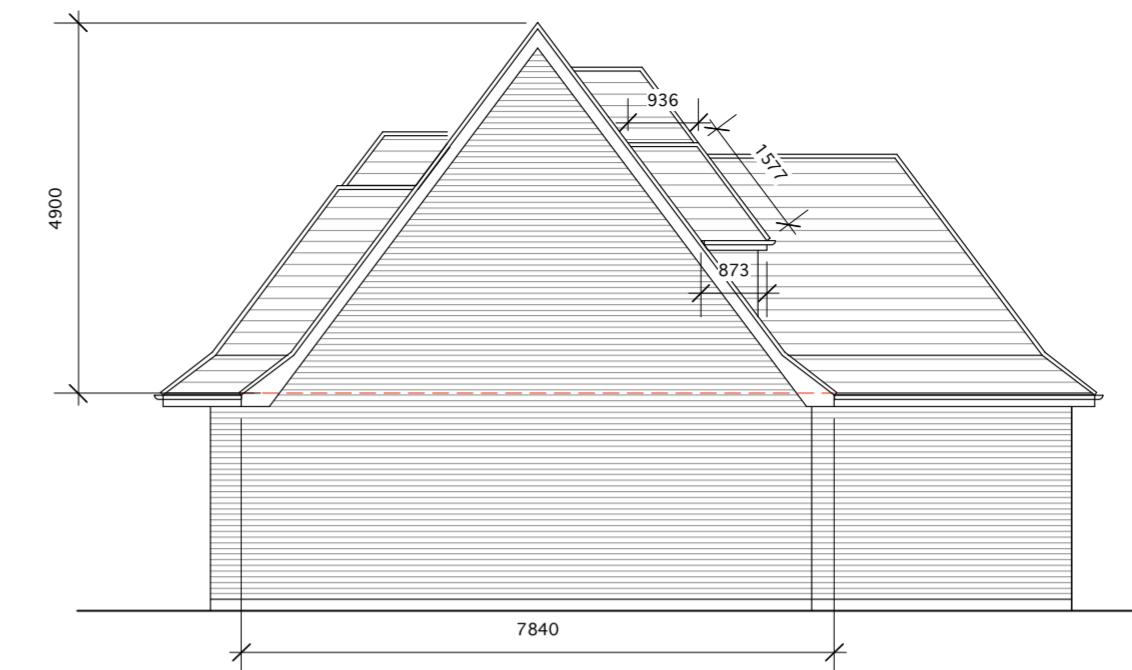




FRONT ELEVATION



REAR ELEVATION



SIDE ELEVATION 1



TYPICAL SECTION ACROSS HOUSE



SIDE ELEVATION 2

VOLUME CALCULATION
VOLUME OF PROPOSED GABLE.

$$\frac{4.9M \times 7.84M}{2} \times 3.92M = 25.10M^3$$

VOLUME OF PROPOSED DORMER
DORMER WALLS: $\frac{1.17 \times 1.57 \times 0.873}{2} = 0.8M^3$
DORMER ROOF: $\frac{0.936 \times 1.577 \times 0.967}{2} = 0.71M^3$
TOTAL VOLUME = 26.13M³
(TOTAL VOLUME ALLOWED: 50M³)

THESE DRAWINGS ARE FOR PLANNING APPLICATIONS AND NOT FOR CONSTRUCTION

0 1m 2m 3m 4m 5m
SCALE 1:100


Client
MR NORMAN McKINSTRY
45 THORNHILL ROAD
ICKENHAM UB10 8SQ

Job Title
LOFT
NEW HIP TO GABLE & REAR DORMER
(CERTIFICATE OF LAWFUL PROPOSED USE)


Drawing
PROPOSED PLANS, ELEVATIONS,
AND TYPICAL SECTION

Date 23.01.25 Scale 1:100 @A2
Job No 45TR Drawing No A-02 Revision No


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GROUND FLOOR PLAN

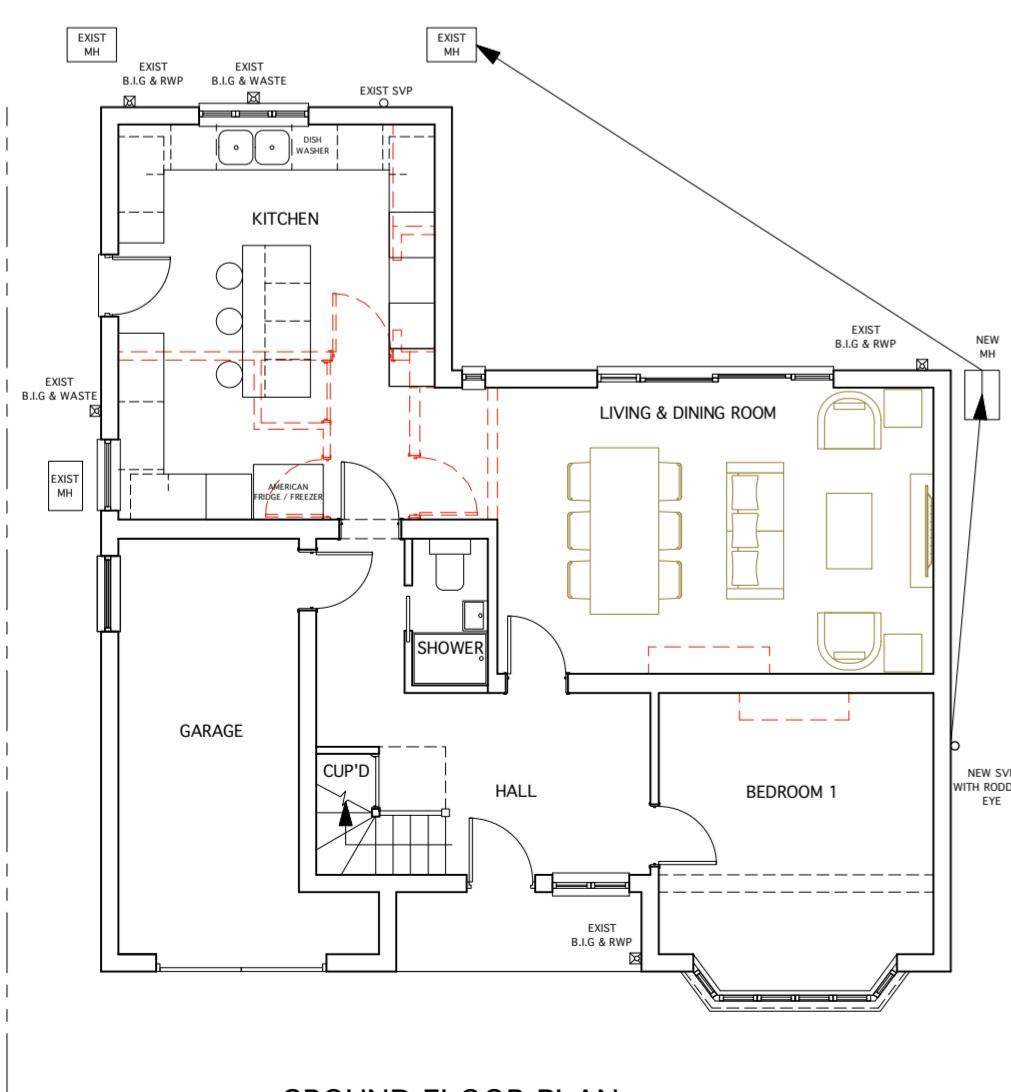

FIRST FLOOR PLAN

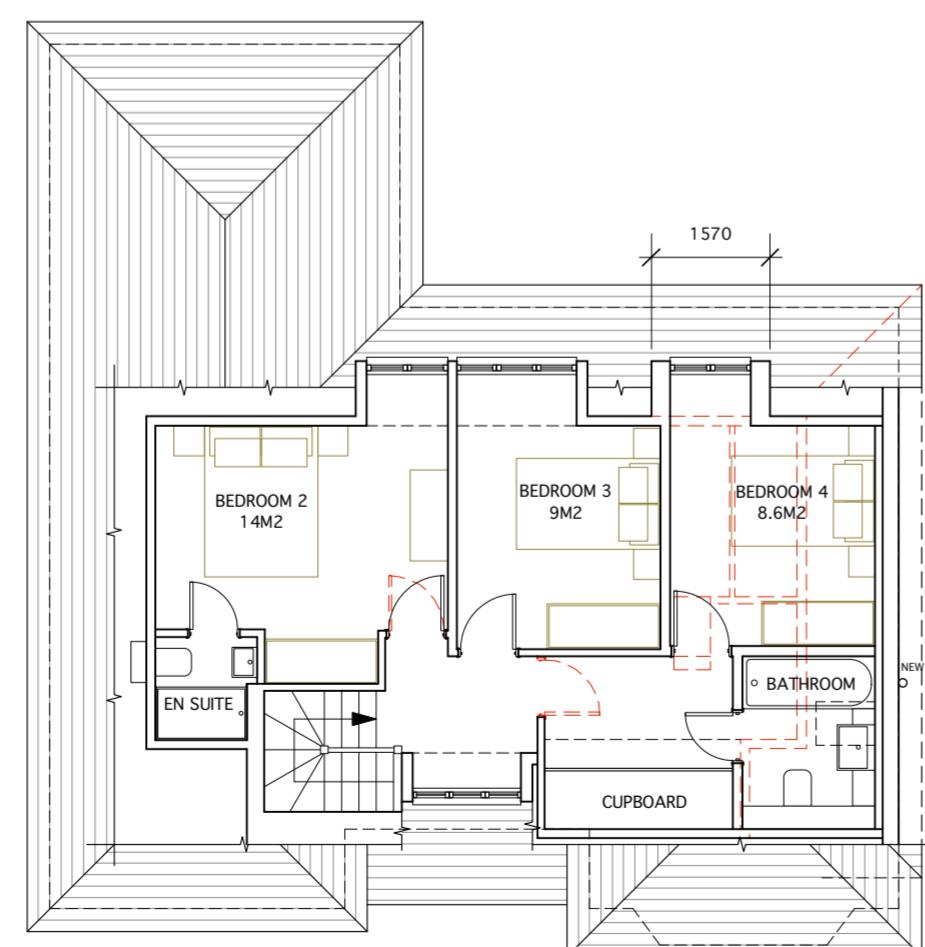

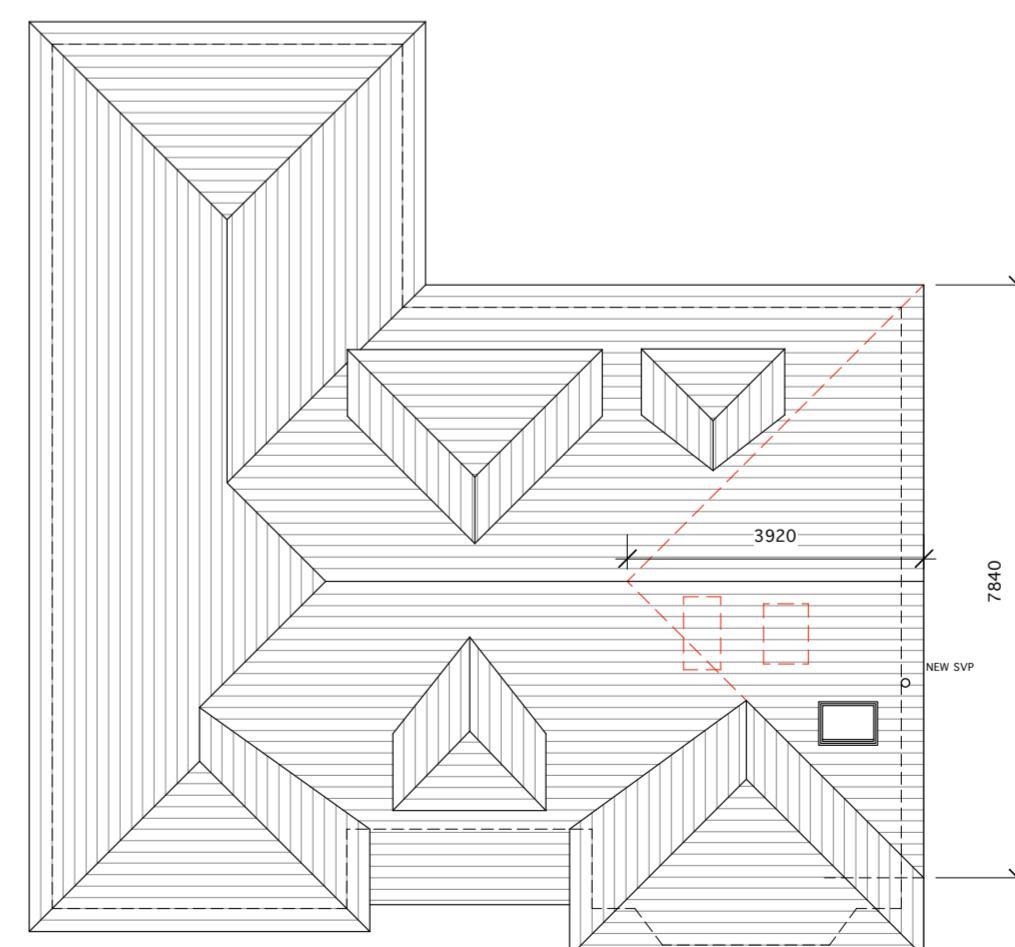ROOF PLAN