


**Existing Ground Floor Plan**

Scale 1:100

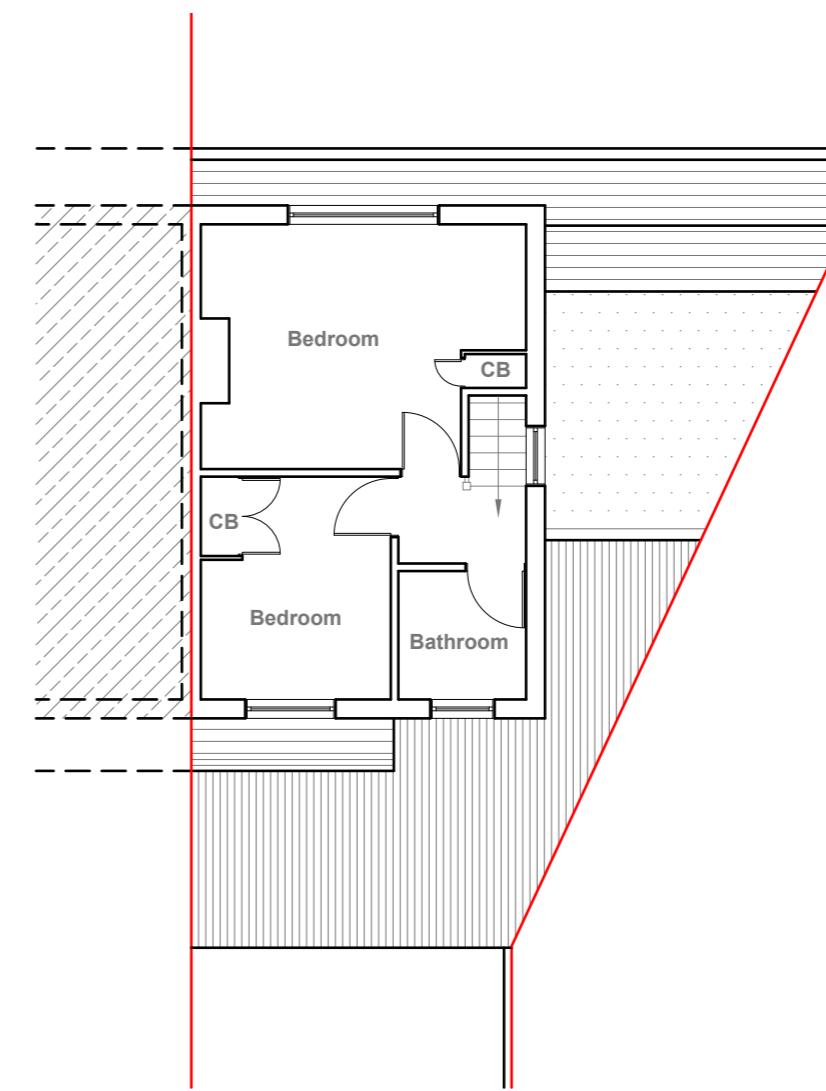

**Existing First Floor Plan**

Scale 1:100

10 Meter  
5  
2  
1  
0  
1:100

GENERAL NOTES:  
 1. ALL DIMENSIONS ARE IN MILLIMETER.  
 2. VERIFY ALL DIMENSIONS AND CONDITIONS BEFORE BUILDING OR  
 STARTING CONSTRUCTION. NOTIFY THE DESIGNER IMMEDIATELY OF ANY  
 DISCREPANCY OR VARIATION.  
 3. ALL WORK TO COMPLY WITH CURRENT BUILDING REGULATIONS  
 AND CODES OF PRACTICE

Title:

## Existing Floor Plans

Site Address  
263 Balmoral Drive,  
Hayes.  
UB4 8DQ

Scale: 1:100 @A3  
Date: 13/12/2024  
Drawing No.:  
2024/198 -01  
Drawn By:  
RO


Revision Date:  
\_\_\_\_\_  
\_\_\_\_\_  
\_\_\_\_\_  
\_\_\_\_\_  
e:mail -  
faluckpatel@yahoo.com  
(M) +44 (0) 7871 466 254

**Faluck  
Patel**



**Existing Front Elevation**

Scale 1:100

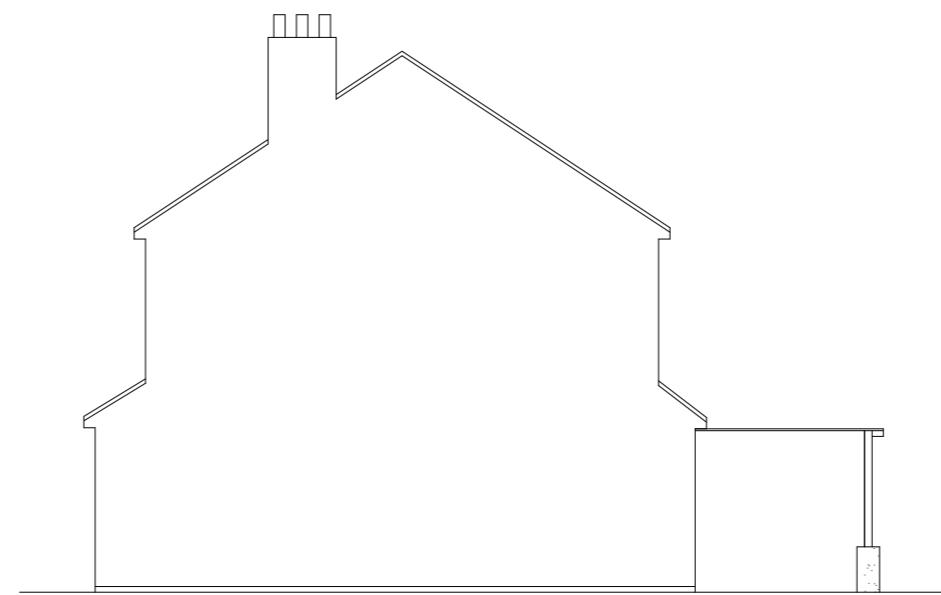

**Existing Side Elevation**

Scale 1:100



**Existing Rear Elevation**

Scale 1:100



**Existing Side Elevation**

Scale 1:100

10 Meter  
5  
2  
1  
0  
1:100

GENERAL NOTES:  
1. ALL DIMENSIONS ARE IN MILLIMETER.  
2. VERIFY ALL DIMENSIONS AND CONDITIONS BEFORE BUILDING OR  
STARTING CONSTRUCTION. NOTIFY THE DESIGNER IMMEDIATELY OF ANY  
DISCREPANCY OR VARIATION.  
3. ALL WORK TO COMPLY WITH CURRENT BUILDING REGULATIONS  
AND CODES OF PRACTICE


Title:

## Existing Elevations

Site Address  
263 Balmoral Drive,  
Hayes,  
UB4 8DQ

Scale: 1:100 @A3  
Date: 13/12/2024  
Drawing No.:  
2024/198 -02

Revision Date:  
Drawn By:  
RO  
e:mail -  
faluckpatel@yahoo.com  
(M) +44 (0) 7871 466 254

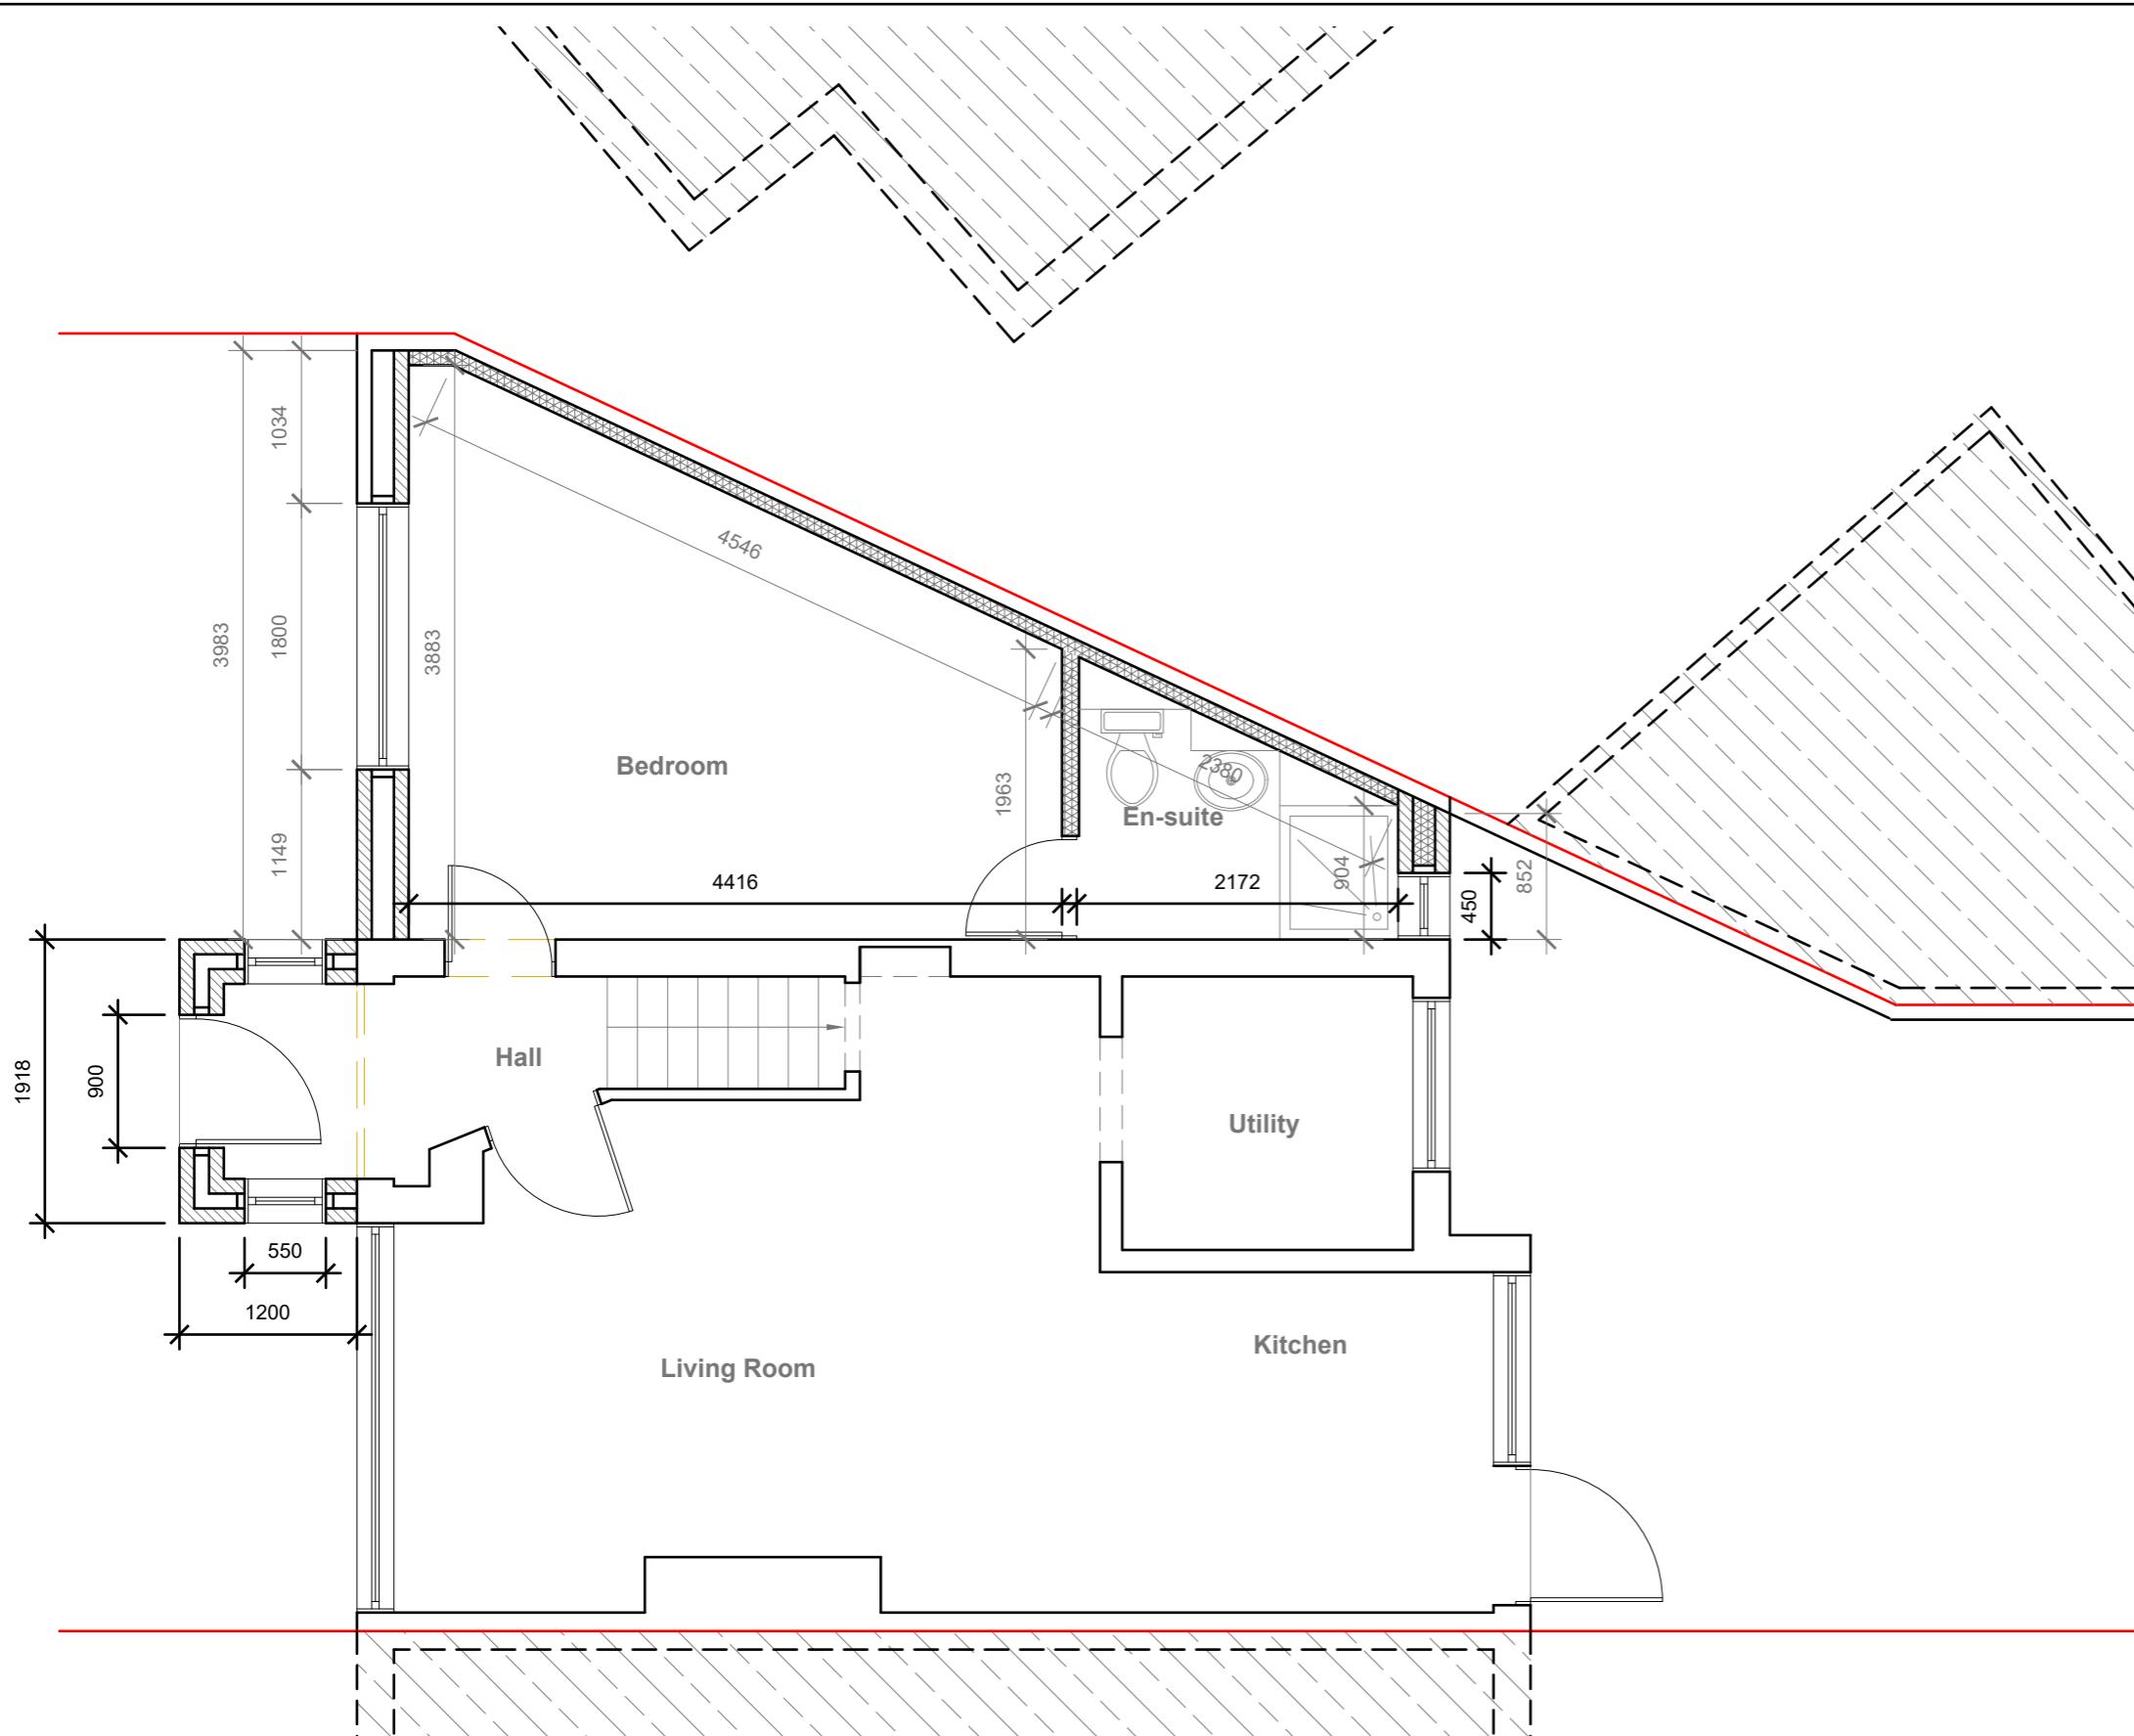

GENERAL NOTES:

1. ALL DIMENSIONS ARE IN MILLIMETER.
2. VERIFY ALL DIMENSIONS AND CONDITIONS BEFORE BUILDING OR STARTING CONSTRUCTION. NOTIFY THE DESIGNER IMMEDIATELY OF ANY DISCREPANCY OR VARIATION.
3. ALL WORK TO COMPLY WITH CURRENT BUILDING REGULATIONS AND CODES OF PRACTICE


Title:

## Proposed Ground Floor Plan

Site Address  
263 Balmoral Drive,  
Hayes.  
UB4 8DQ

Scale: 1:50 @A3  
Date: 13/12/2024  
Drawing No.:  
2024/198 -03HH  
Drawn By:  
RO

Revision Date:  
\_\_\_\_\_  
\_\_\_\_\_  
\_\_\_\_\_  
\_\_\_\_\_  
e:mail -  
faluckpatel@yahoo.com  
(M) +44 (0) 7871 466 254

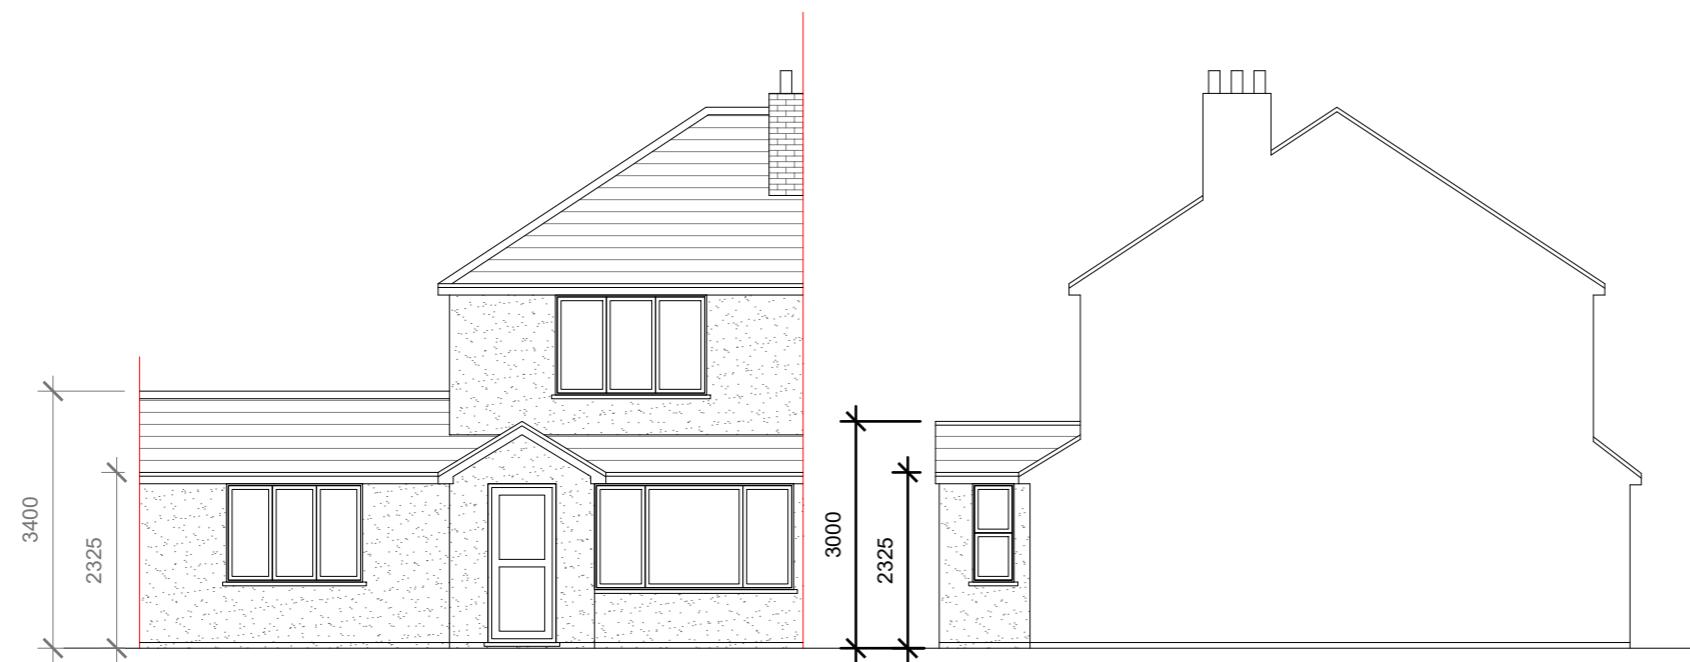


**Proposed Front Elevation**

Scale 1:100

**Proposed Side Elevation**

Scale 1:100

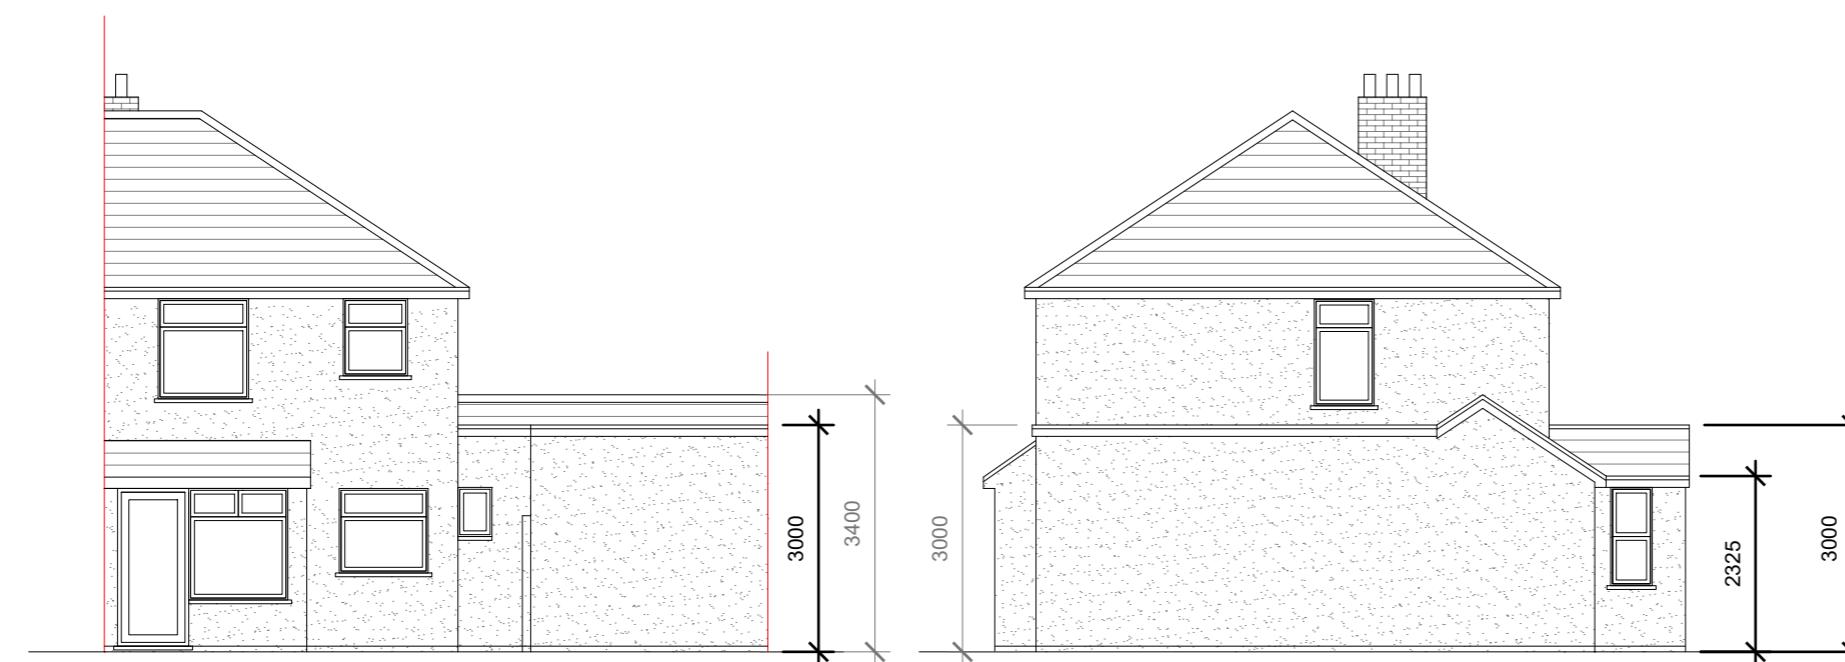

**Proposed Rear Elevation**

Scale 1:100

**Proposed Side Elevation**

Scale 1:100

1:100 0 1 2 5 10 Meter

GENERAL NOTES:  
 1. ALL DIMENSIONS ARE IN MILLIMETER.  
 2. VERIFY ALL DIMENSIONS AND CONDITIONS BEFORE BUILDING OR  
 STARTING CONSTRUCTION. NOTIFY THE DESIGNER IMMEDIATELY OF ANY  
 DISCREPANCY OR VARIATION.  
 3. ALL WORK TO COMPLY WITH CURRENT BUILDING REGULATIONS  
 AND CODES OF PRACTICE

Title:

## Proposed Elevations

Site Address  
263 Balmoral Drive,  
Hayes.  
UB4 8DQ

Scale: 1:100 @A3  
Date: 13/12/2024  
Drawing No.: 2024/198 -04HH  
Drawn By:  
RO

Revision Date:  
e:mail -  
faluckpatel@yahoo.com  
(M) +44 (0) 7871 466 254

**Faluck Patel**