

GENERAL NOTES:
 1. ALL DIMENSIONS ARE IN MILLIMETER.
 2. VERIFY ALL DIMENSIONS AND CONDITIONS BEFORE BUILDING OR
 STARTING CONSTRUCTION. NOTIFY THE DESIGNER IMMEDIATELY OF ANY
 DISCREPANCY OR VARIATION.
 3. ALL WORK TO COMPLY WITH CURRENT BUILDING REGULATIONS
 AND CODES OF PRACTICE

Title:

Existing Floor Plans

Site Address
60 Windsor Avenue
Uxbridge
Middlesex
UB10 9AX

Scale: 1:100 @A3
Date: 20/08/2024
Drawing No.: 2024/133 -01
Drawn By:
FP

Revision Date:

e:mail -
faluckpatel@yahoo.com
(M) +44 (0) 7871 466 254



Existing Front Elevation

Scale 1:100




Existing Side Elevation

Scale 1:100



Existing Rear Elevation

Scale 1:100

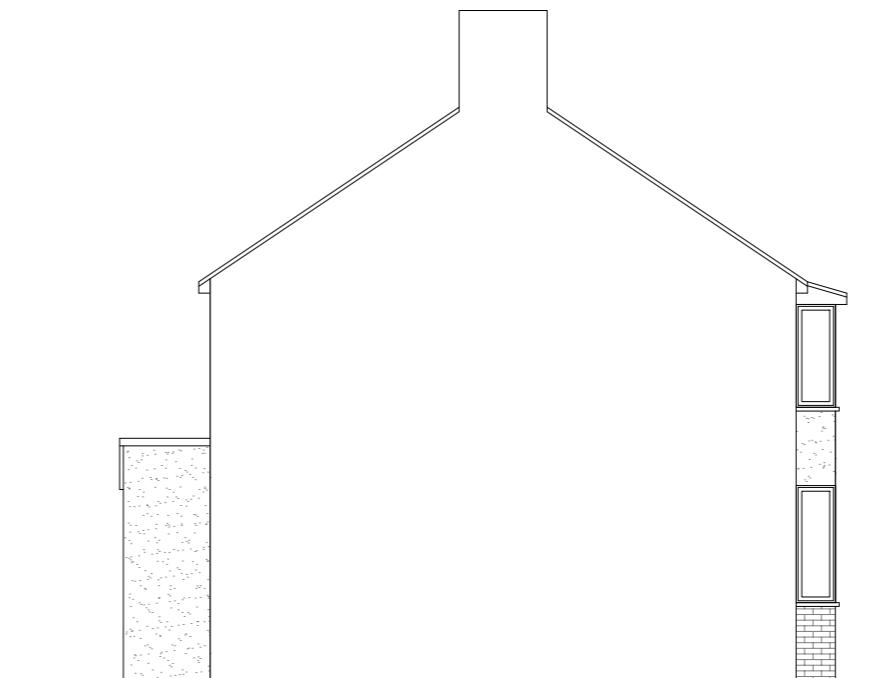

Existing Side Elevation

Scale 1:100

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Title: _____

Existing Elevations

Site Address
60 Windsor Avenue
Uxbridge
Middlesex
UB10 9AX


Scale: 1:100 @A3
Date: 20/08/2024
Drawing No.: 2024/133 -02
Drawn By: FP

Revision Date:


e:mail - faluckpatel@yahoo.com
(M) +44 (0) 7871 466 254

10 Meter
5
2
1
0
1:100

Faluck Patel

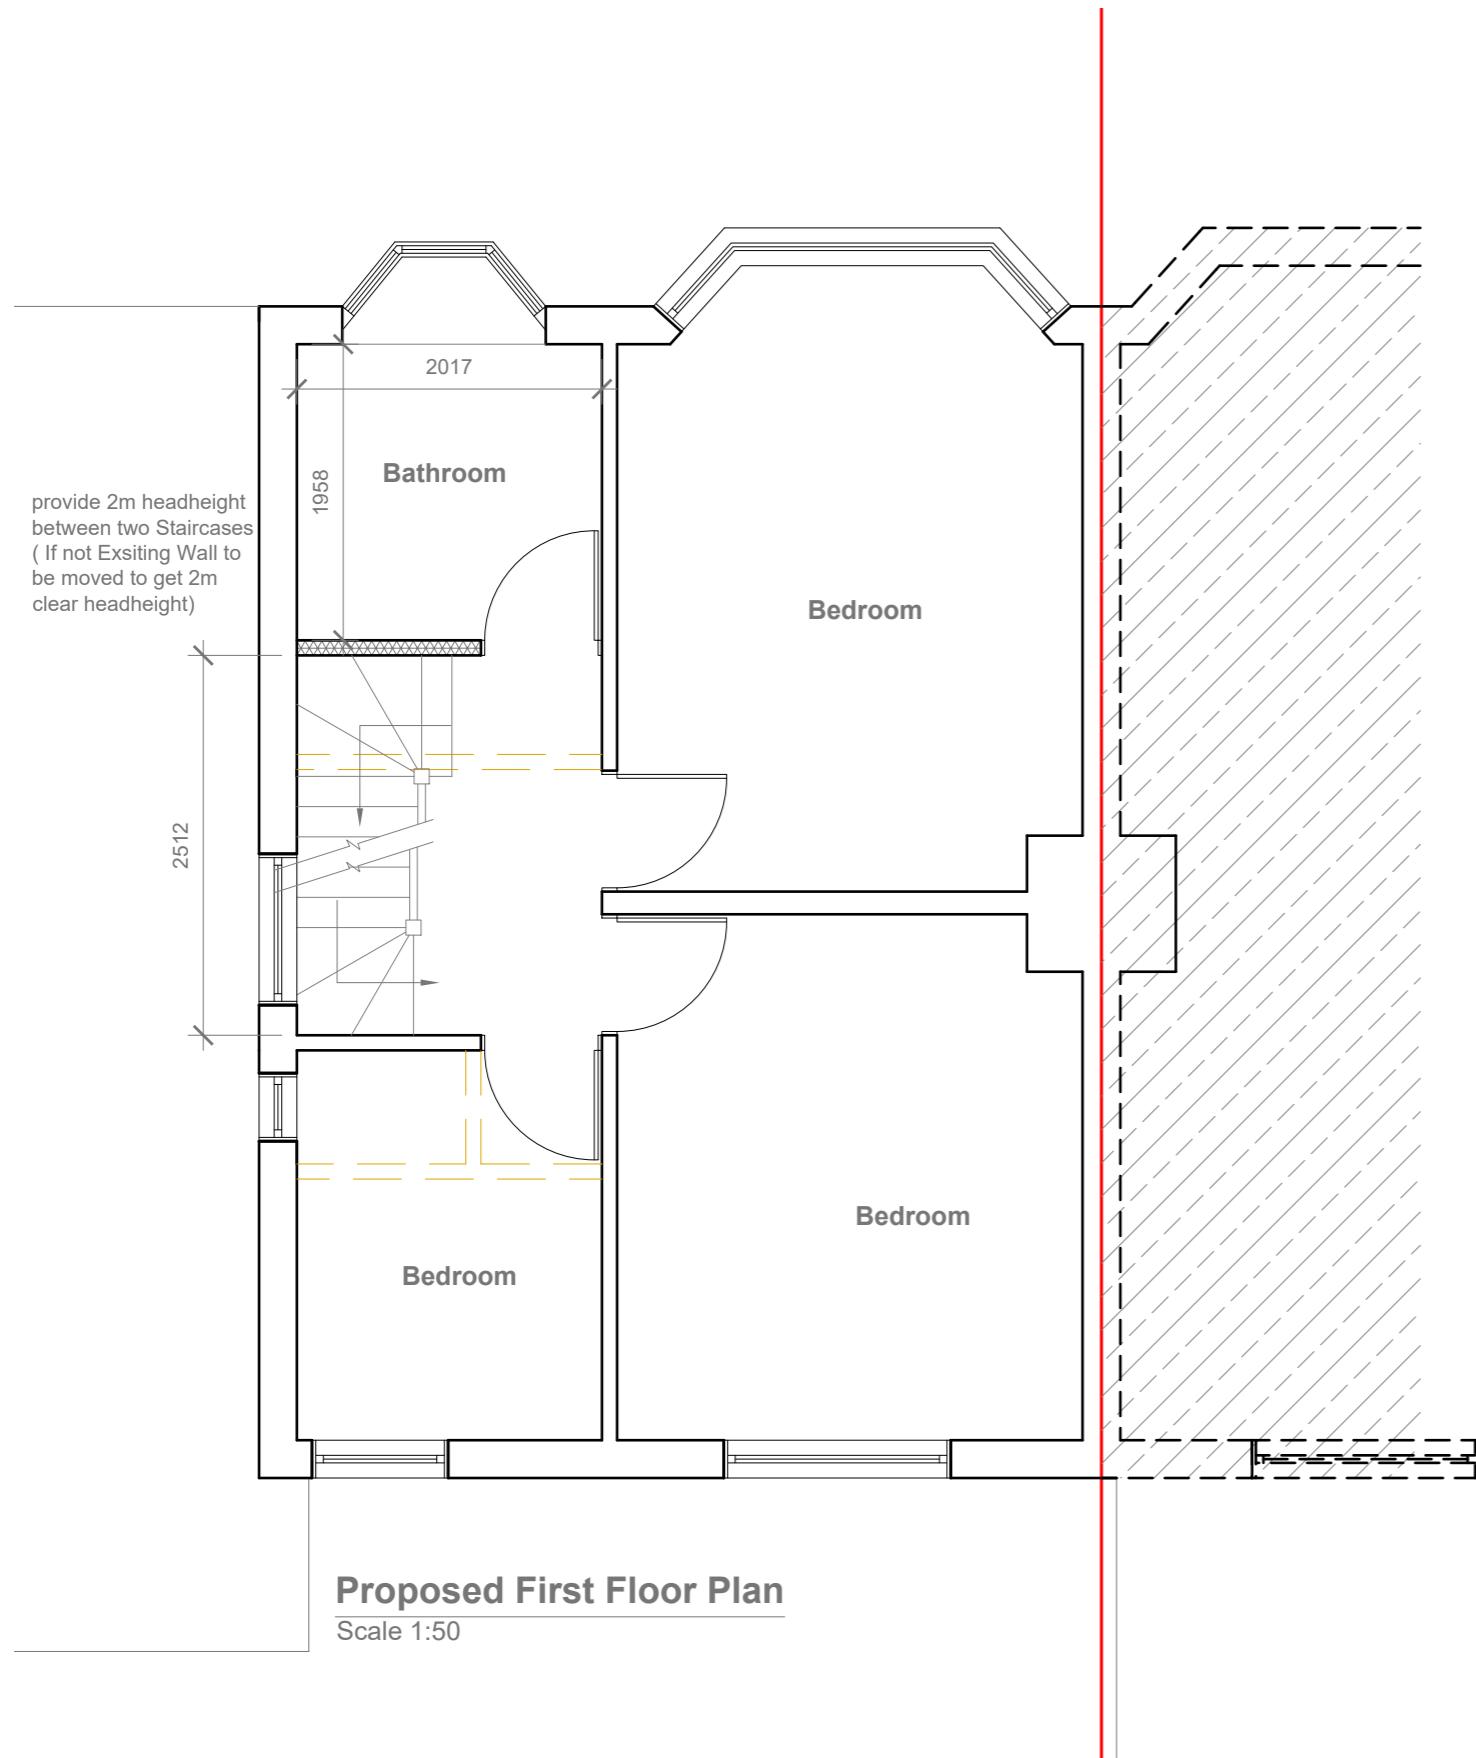

Velux Window to be installed as per manufacturer specification, not projected more than 150mm from the plane of roof slope

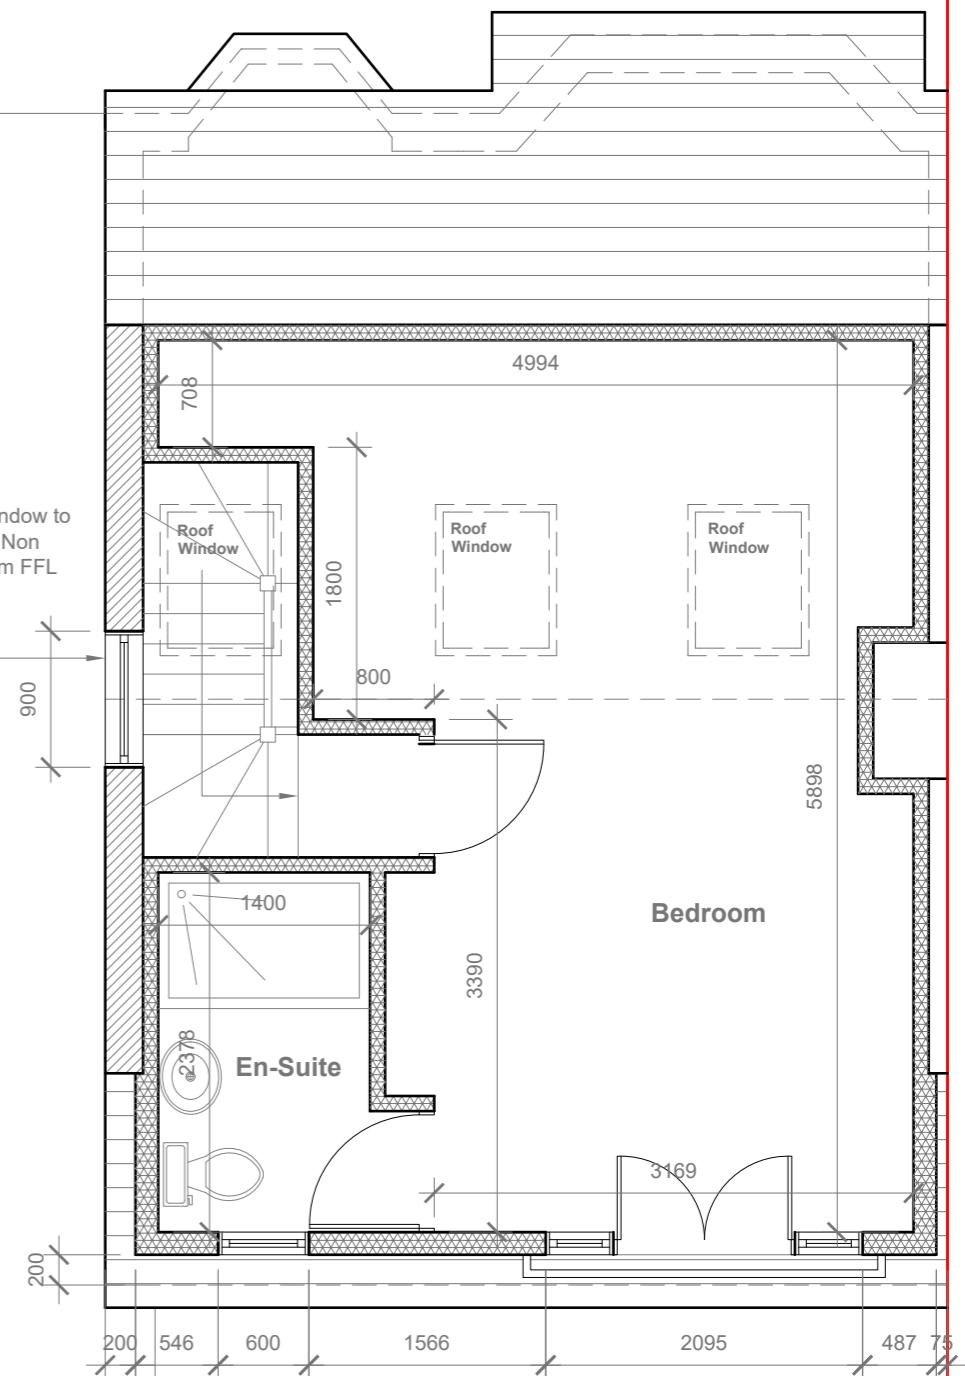

5 Meter

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Title:

Proposed First Floor & Loft Plans

Site Address
60 Windsor Avenue
Uxbridge
Middlesex
UB10 9AX

Scale: 1:50 @A3
Date: 20/08/2024
Drawing No.:
2024/133 -03
Drawn By:
FP


vision Date:

Faluck Patel




Proposed Front Elevation

Scale 1:100

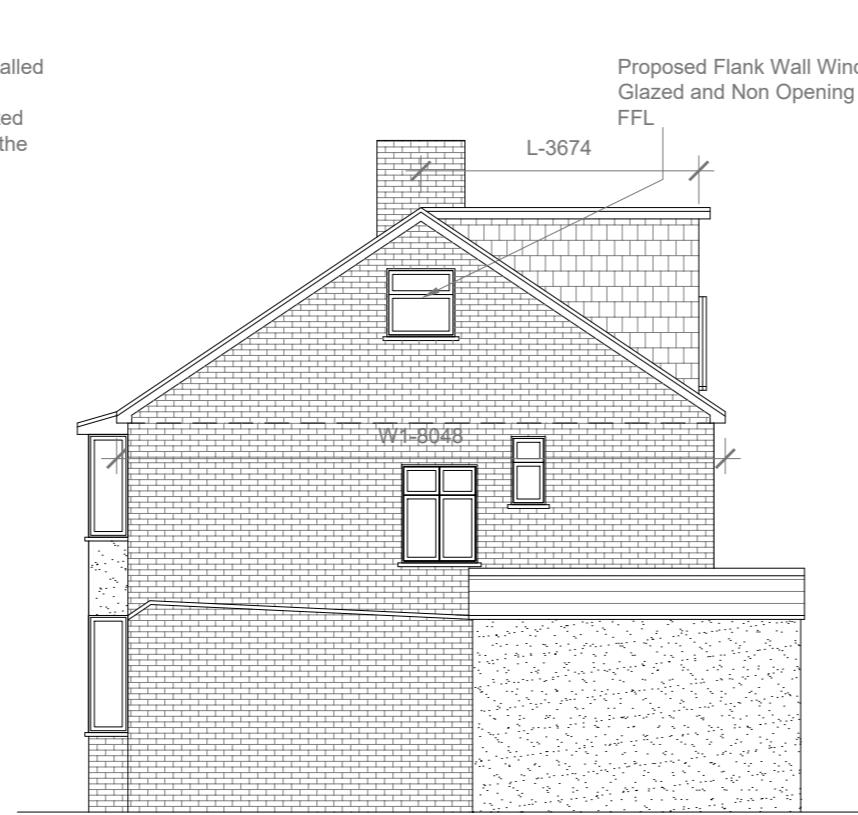


Proposed Side Elevation

Scale 1:100

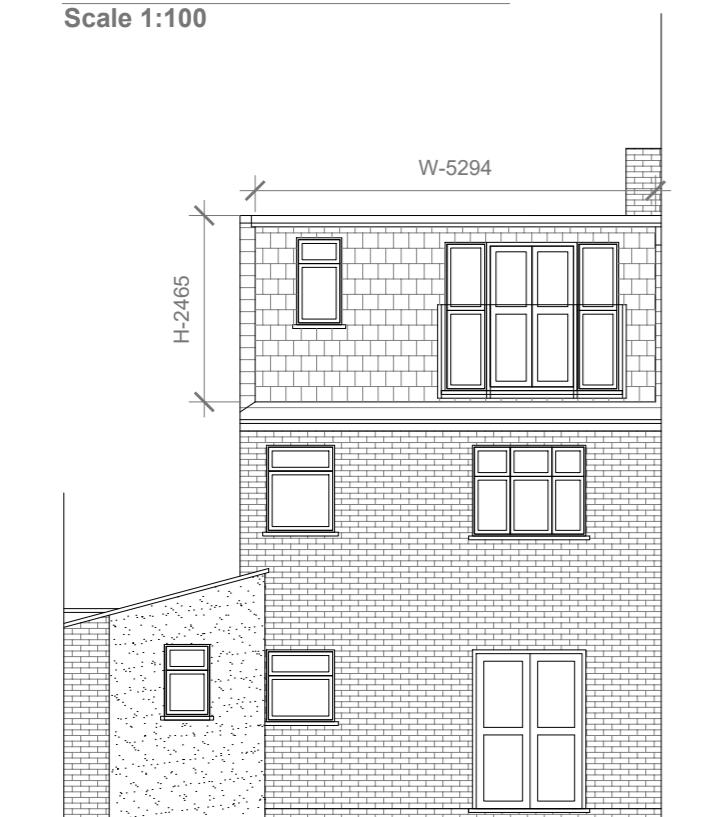

Proposed Rear Elevation

Scale 1:100

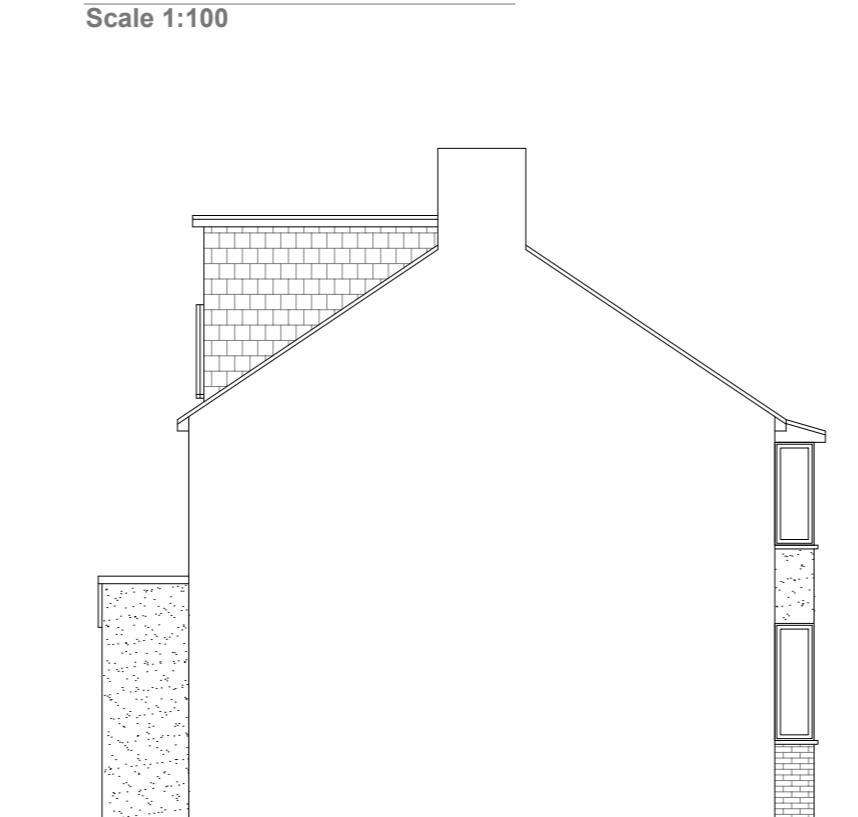

Proposed Side Elevation

Scale 1:100

Proposed External Finish Materials to Match Existing External Finish Materials

REAR DORMER VOLUME =

$$W \times H \times L / 2 \\ 5.294 \times 2.465 \times 3.674 / 2 \\ 47.94 / 2 \\ 23.97 \text{ CU.MT.}$$

HIP TO GABLE ROOF VOLUME =

$$W1 \times H1 \times L1 / 6 \\ 8.048 \times 2.850 \times 3.874 / 6 \\ 88.85 / 6 \\ 14.80 \text{ CU.MT.}$$

TOTAL ROOF VOLUME =

$$V1 + V2 \\ 23.97 + 14.80 \\ 38.77 \text{ CU.MT.} < 50.00 \text{ CU.MT}$$

10 Meter
5
2
1
0
1:100

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Proposed Elevations

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60 Windsor Avenue
Uxbridge
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UB10 9AX

Scale: 1:100 @A3
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FP

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