

V - Design

Website: V-Design CAD Services Ltd
Email Address: info@vdesigncad.co.uk

IMPORTANT NOTES:

Dimensions to be verified on site
DO NOT SCALE FROM THIS DRAWING.
Any areas indicated on this drawing are for guidance only.
No responsibility is taken for their accuracy.

This drawing is the property of **V-DESIGN CAD Services Ltd**
Copyright is reserved by them and the drawing is issued on the condition that it is not copied, reproduced, retained or disclosed to any unauthorized person, either wholly or in part without the consent in writing of **V-DESIGN CAD Services Ltd**

Email: vishal.p@vdesigncad.co.uk Mobile: 07971083395

PROJECT:

88 St Clements Close,
Uxbridge,
UB8 3ST

LEGENDS:

EXISTING:	PROPOSED:
Existing Wall	Proposed Wall
Internal Wall	Internal Wall
Site Boundary	Site Boundary
Windows	Windows
Doors	Doors

Drawing Title:

Block and Location Plans

Scale: 1:500, 1:1250 Paper Size: A3

REVISION/ COMMENTS :


No:	Comments:	Date:

Drawn By: VG

Job Ref: 24068

Date: July-2024

Drawing No. PL - 01

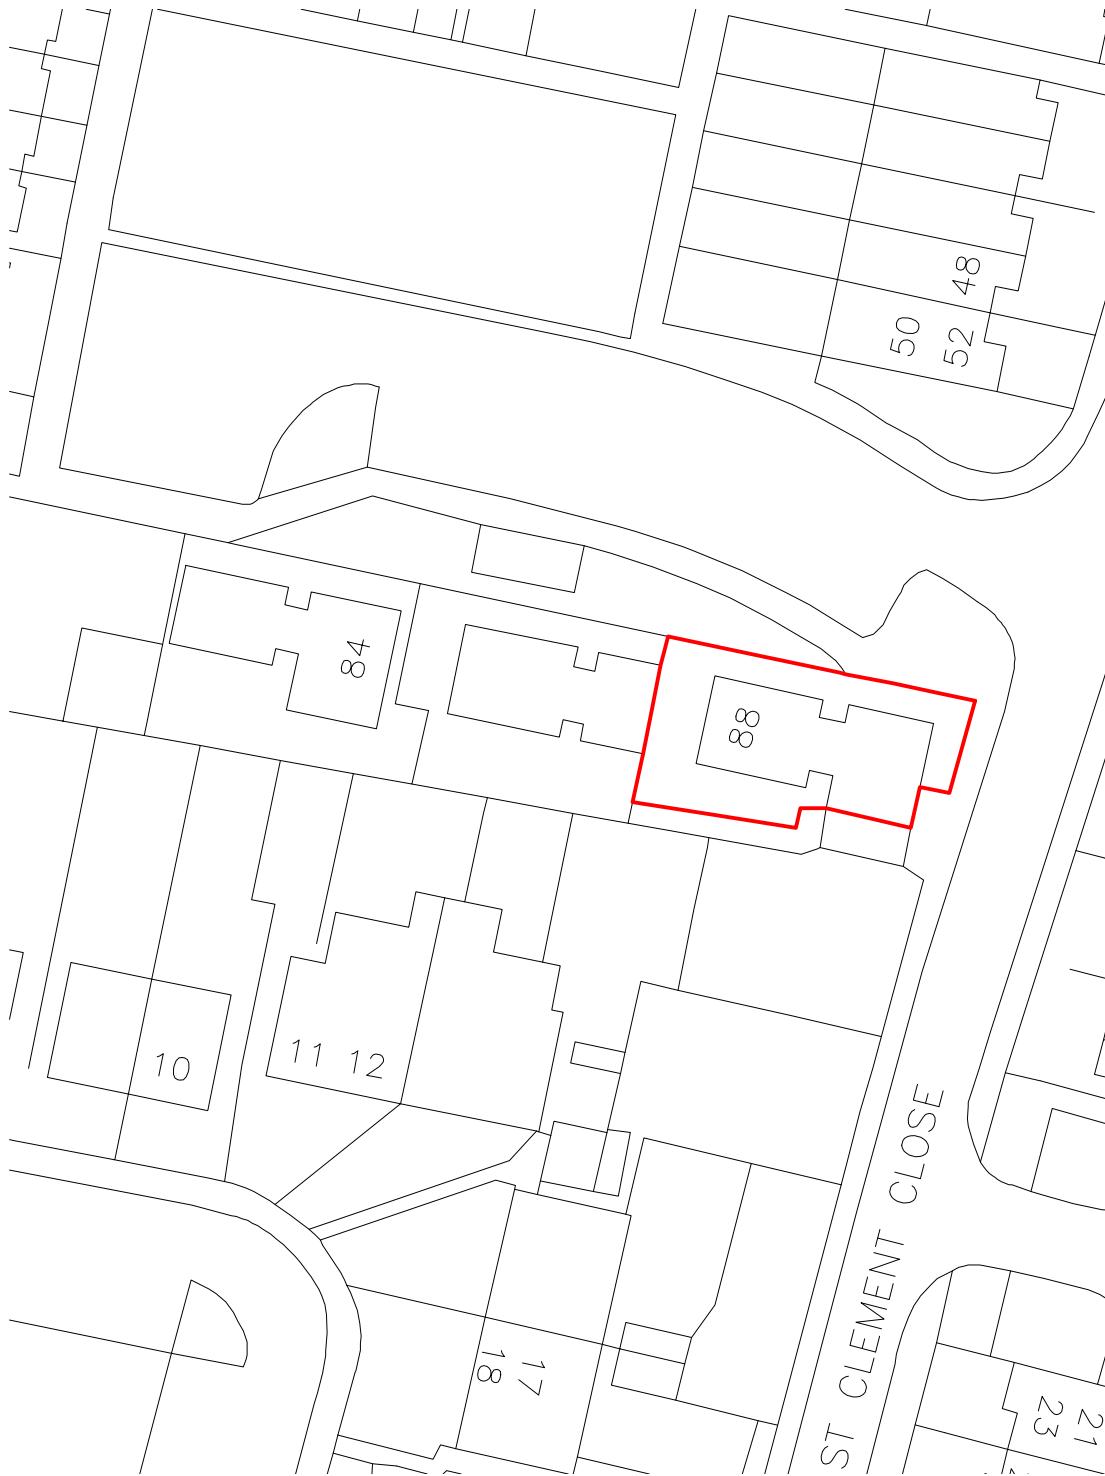




Block Plan

0 5 10 15 20 25
metres 1:500 scale



Site Location

0 10 20 30 40 50
metres 1:1250 scale

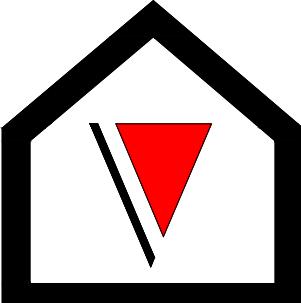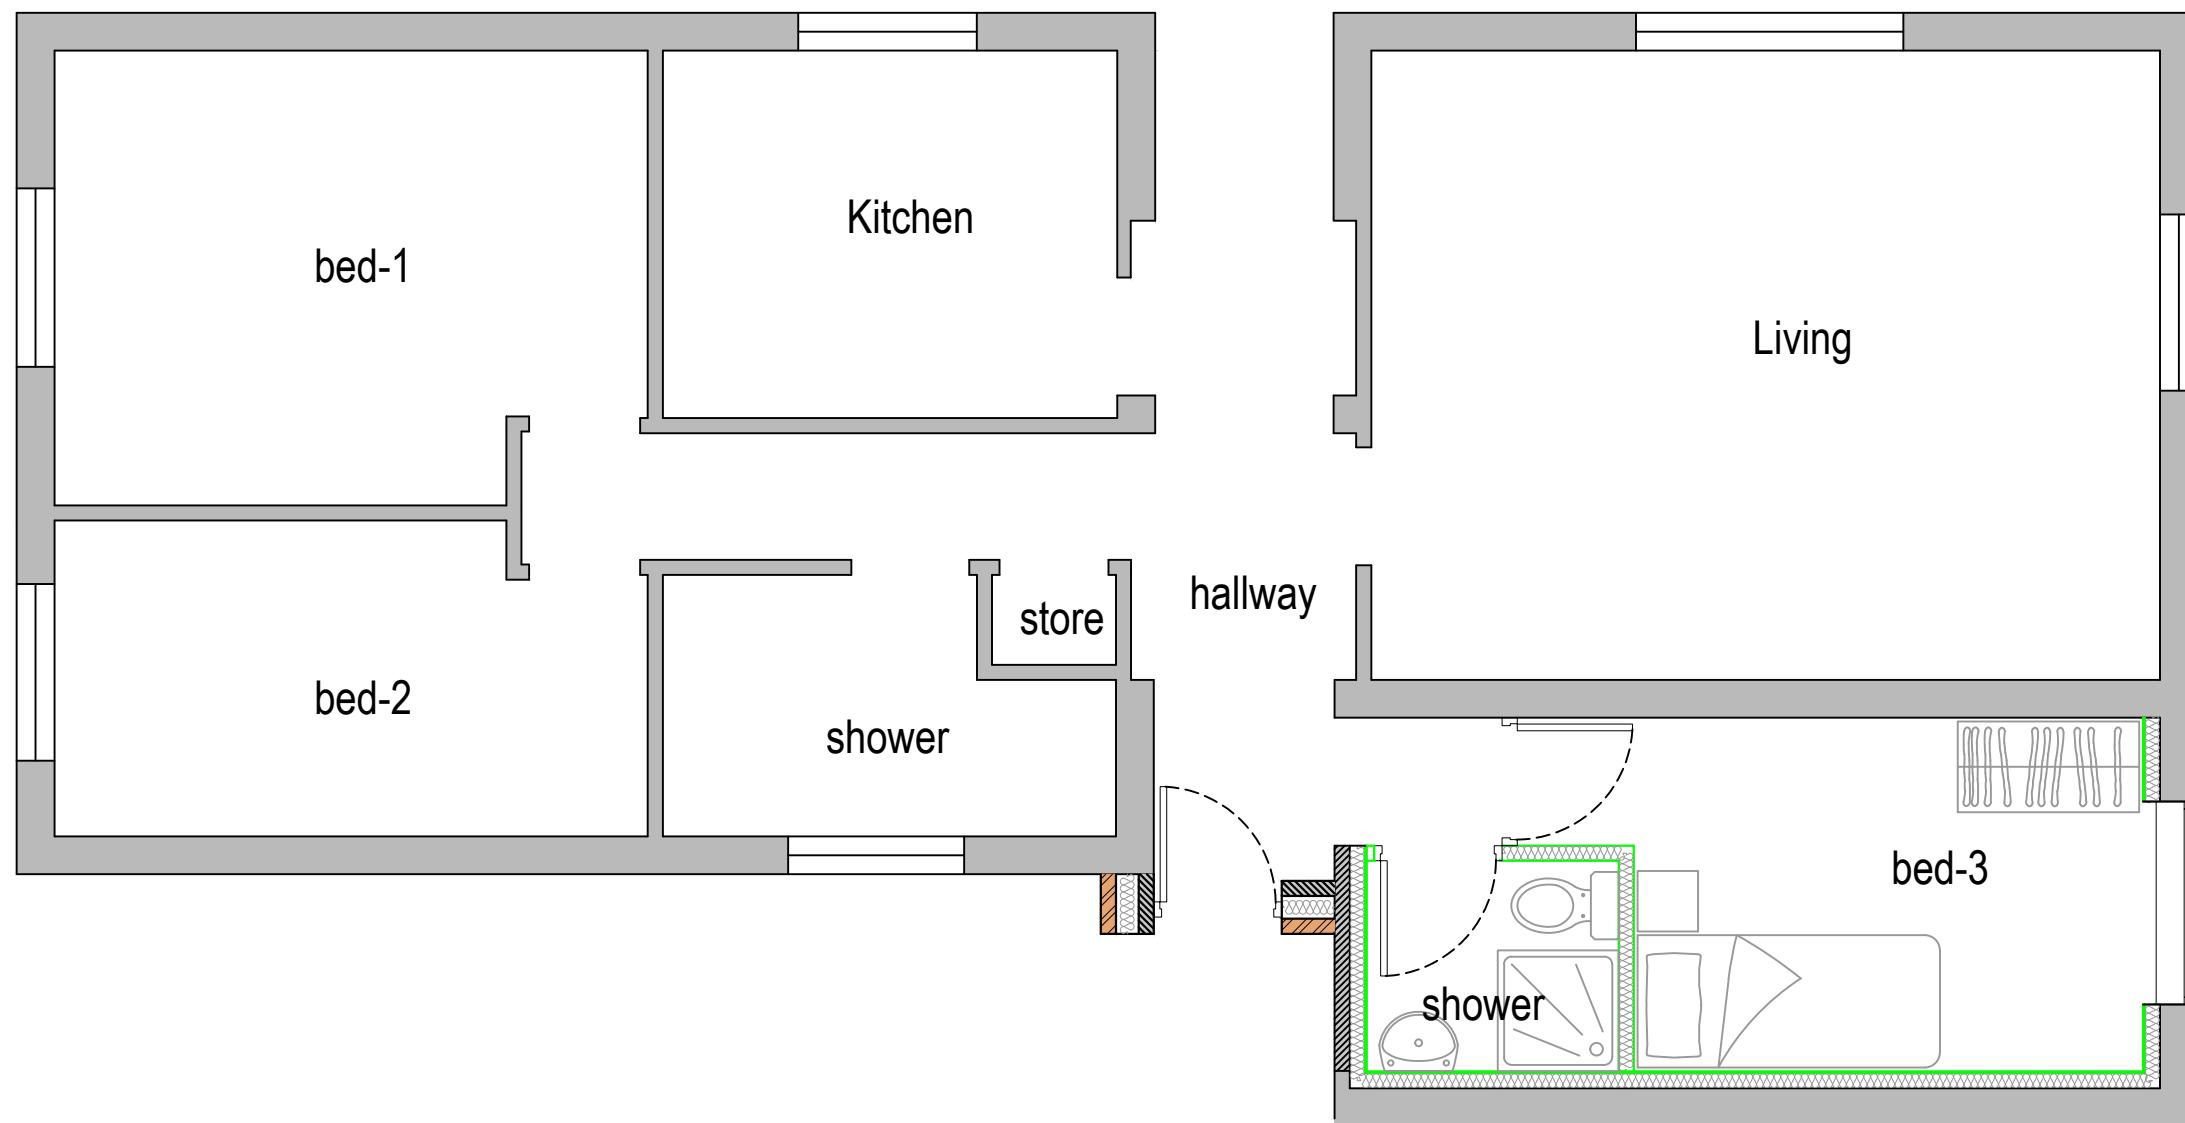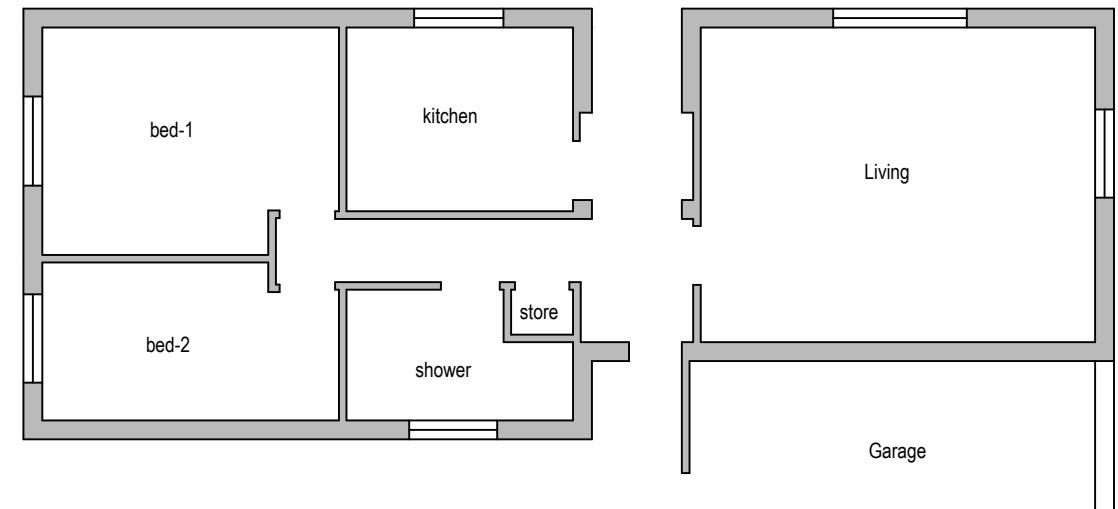

V - Design

Company: V-Design CAD Services Ltd
 Website: www.vdesigncad.co.uk
 Email Address: info@vdesigncad.co.uk
 Tel : +44 20 3488 4890
 Mobile: +44 7312015617

IMPORTANT NOTES:
 Dimensions to be verified on site
 DO NOT SCALE FROM THIS DRAWING.
 Any areas indicated on this drawing are for guidance only.
 No responsibility is taken for their accuracy.

This drawing is the property of **V-DESIGN CAD Services Ltd**. Copyright is reserved by them and the drawing is issued on the condition that it is not copied, reproduced, retained or disclosed to any unauthorized person, either wholly or in part without the consent in writing of **V-DESIGN CAD Services Ltd**.

88 St Clements Close,
 Uxbridge,
 UB8 3ST

LEGENDS:

EXISTING:	PROPOSED:
Existing Wall	Cavity Wall
Internal Wall	Internal Wall
Site Boundary	Site Boundary
Windows	Windows
Doors	Doors


Drawing Title:
 Existing and Proposed Floor Plan
 Scale: 1:100,1:50 Paper Size: A3

REVISION/ COMMENTS :		
No:	Comments:	Date:

Proposed Floor Plan

0 0.5 1.0 1.5 2.0 2.5 metres 1:50 scale

Drawn By: VG
 Job Ref: 24068
 Date: July-2024
 Drawing No. PL - 02

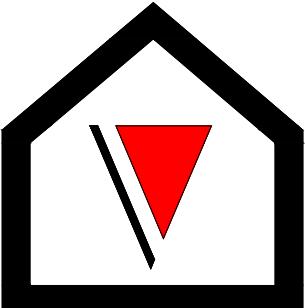

V - Design

Company: V-Design CAD Services Ltd
Website: www.vdesigncad.co.uk
Email Address: info@vdesigncad.co.uk
Tel : +44 20 3488 4890
Mobile: +44 7312015617

IMPORTANT NOTES:

Dimensions to be verified on site
DO NOT SCALE FROM THIS DRAWING.
Any areas indicated on this drawing are for guidance only.
No responsibility is taken for their accuracy.

This drawing is the property of **V-DESIGN CAD Services Ltd**. Copyright is reserved by them and the drawing is issued on the condition that it is not copied, reproduced, retained or disclosed to any unauthorized person, either wholly or in part without the consent in writing of **V-DESIGN CAD Services Ltd**.

88 St Clements Close,
Uxbridge,
UB8 3ST


LEGENDS:

EXISTING:	PROPOSED:
Existing Wall	Cavity Wall
Internal Wall	Internal Wall
Site Boundary	Site Boundary
Windows	Windows
Doors	Doors

Drawing Title:
Existing Elevations
Scale: 1:100


REVISION/ COMMENTS :		
No:	Comments:	Date:
A	Amendments to the roof	10-09-2024

Drawn By: VG
Job Ref: 24068
Date: July-2024
Drawing No. PL - 03 REV-A

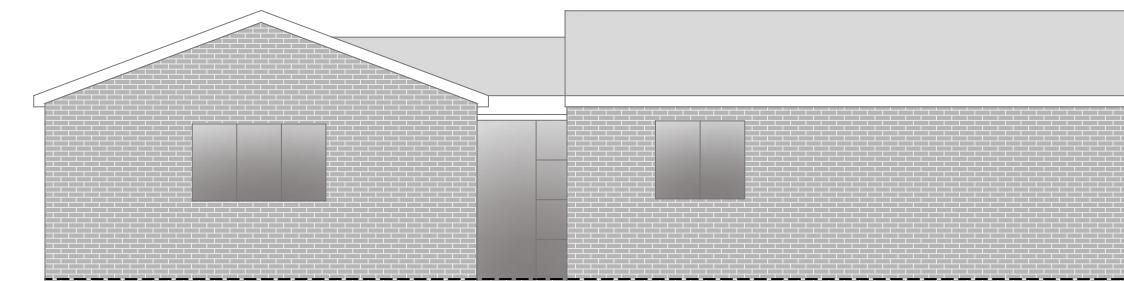


Front Elevation

0 1 2 3 4 5
metres 1:100 scale

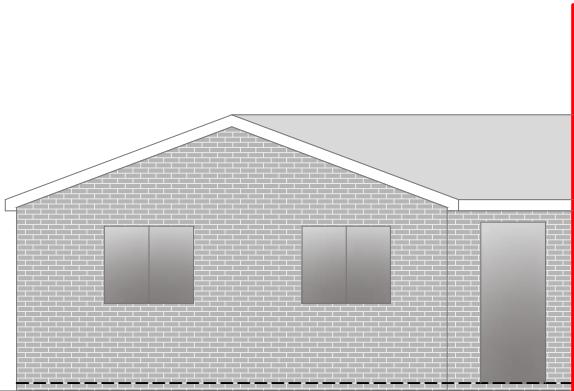

Side Elevation

0 1 2 3 4 5
metres 1:100 scale

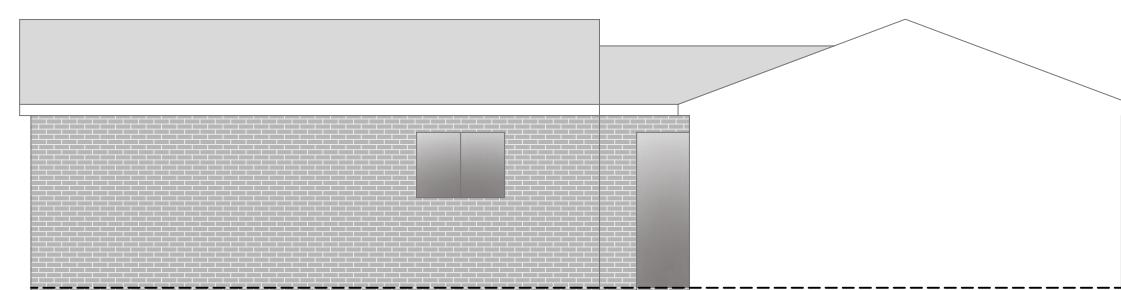


Rear Elevation

0 1 2 3 4 5
metres 1:100 scale



Side Elevation

0 1 2 3 4 5
metres 1:100 scale

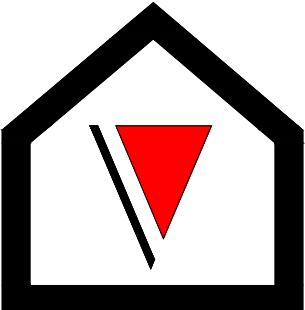

V - Design

Company: V-Design CAD Services Ltd
Website: www.vdesigncad.co.uk
Email Address: info@vdesigncad.co.uk
Tel : +44 20 3488 4890
Mobile: +44 7312015617

IMPORTANT NOTES:

Dimensions to be verified on site
DO NOT SCALE FROM THIS DRAWING.
Any areas indicated on this drawing are for guidance only.
No responsibility is taken for their accuracy.

This drawing is the property of **V-DESIGN CAD Services Ltd**. Copyright is reserved by them and the drawing is issued on the condition that it is not copied, reproduced, retained or disclosed to any unauthorized person, either wholly or in part without the consent in writing of **V-DESIGN CAD Services Ltd**.

88 St Clements Close,
Uxbridge,
UB8 3ST


LEGENDS:

EXISTING:	PROPOSED:
Existing Wall	Cavity Wall
Internal Wall	Internal Wall
Site Boundary	Site Boundary
Windows	Windows
Doors	Doors

Drawing Title:
Proposed Elevations
Scale: 1:100


REVISION/ COMMENTS :		
No:	Comments:	Date:
A	Amendments to the roof	10-09-2024

Drawn By: VG
Job Ref: 24068
Date: July-2024
Drawing No. PL - 04 REV- A

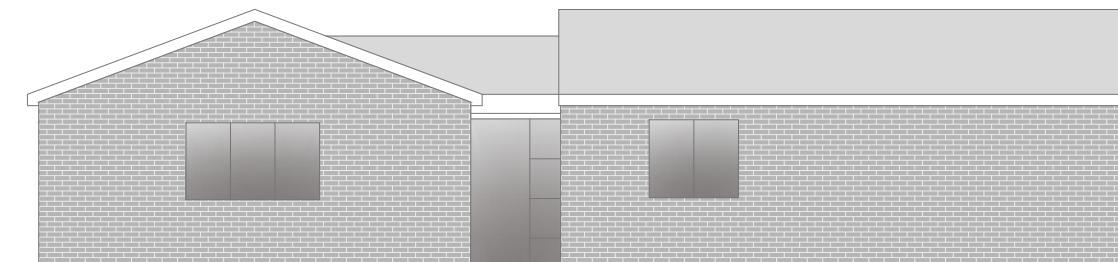

Front Elevation


0 1 2 3 4 5
metres 1:100 scale

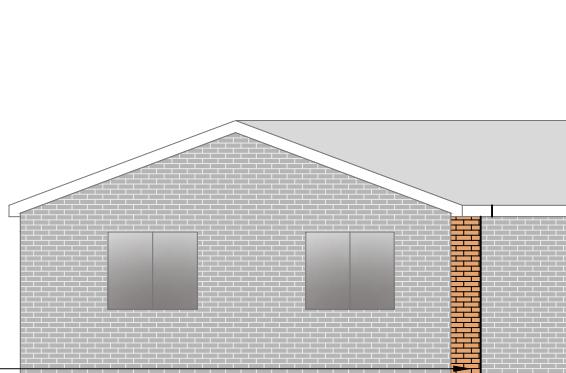

Side Elevation

0 1 2 3 4 5
metres 1:100 scale

brickwork match to existing

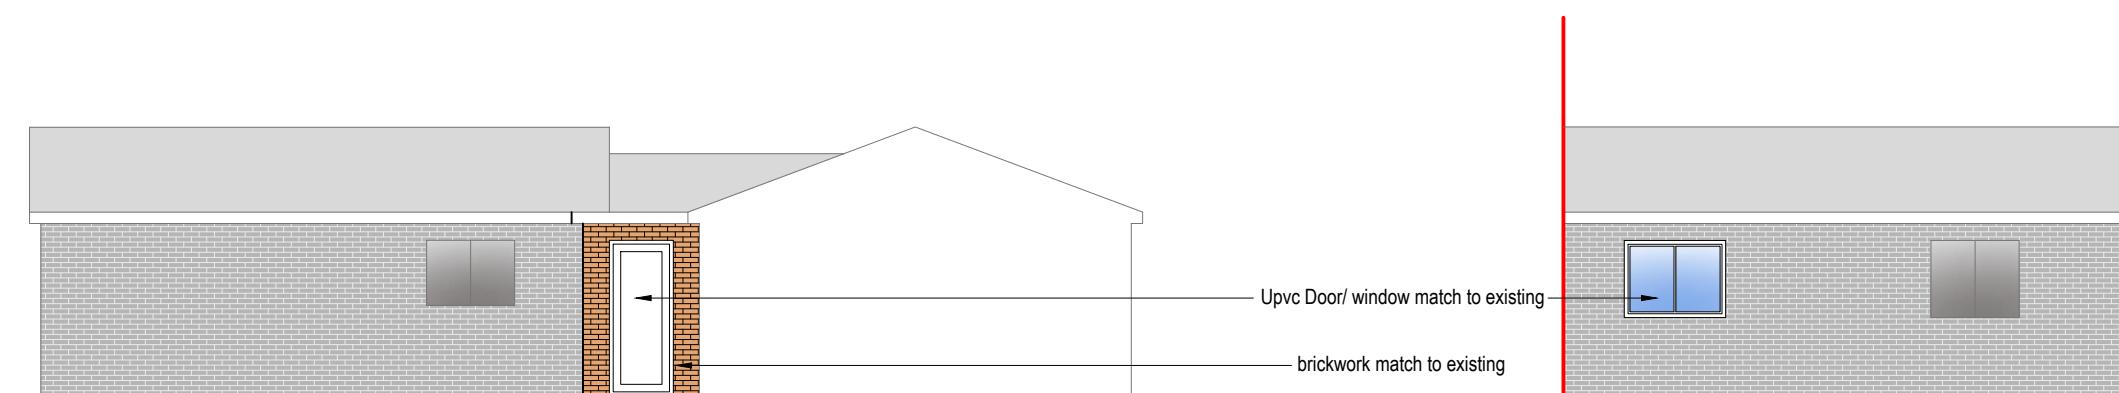

Rear Elevation


0 1 2 3 4 5
metres 1:100 scale

Upvc Door/ window match to existing

brickwork match to existing

Side Elevation

0 1 2 3 4 5
metres 1:100 scale

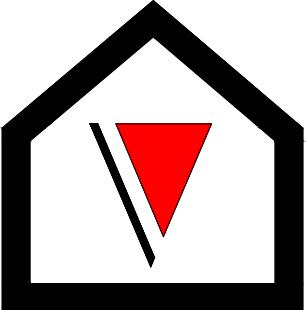

V - Design

Company: V-Design CAD Services Ltd
Website: www.vdesigncad.co.uk
Email Address: info@vdesigncad.co.uk
Tel : +44 20 3488 4890
Mobile: +44 7312015617

IMPORTANT NOTES:

Dimensions to be verified on site
DO NOT SCALE FROM THIS DRAWING.
Any areas indicated on this drawing are for guidance only.
No responsibility is taken for their accuracy.

This drawing is the property of **V-DESIGN CAD Services Ltd**. Copyright is reserved by them and the drawing is issued on the condition that it is not copied, reproduced, retained or disclosed to any unauthorized person, either wholly or in part without the consent in writing of **V-DESIGN CAD Services Ltd**.

88 St Clements Close,
Uxbridge,
UB8 3ST

LEGENDS:

EXISTING:	PROPOSED:
Existing Wall	Cavity Wall
Internal Wall	Internal Wall
Site Boundary	Site Boundary
Windows	Windows
Doors	Doors

Drawing Title:

Existing and Proposed Roof Plan

Scale: 1:100, 1:50 Paper Size: A3

REVISION/ COMMENTS :


No:	Comments:	Date:

Drawn By: VG

Job Ref: 24068


Date: July-2024

Drawing No. PL - 05

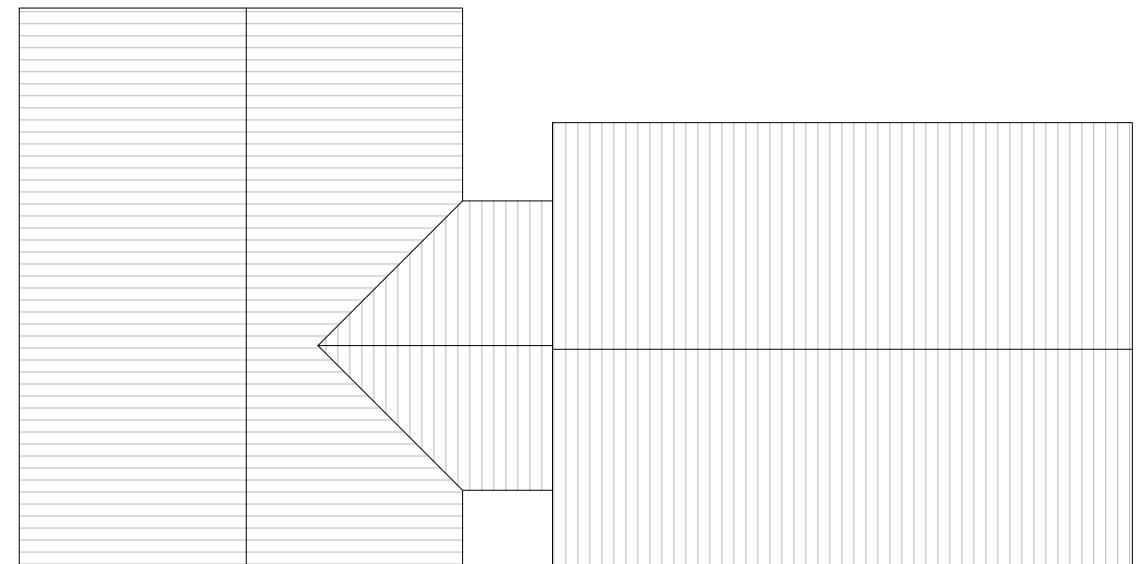

Existing Roof Plan

0 1 2 3 4 5
metres 1:100 scale

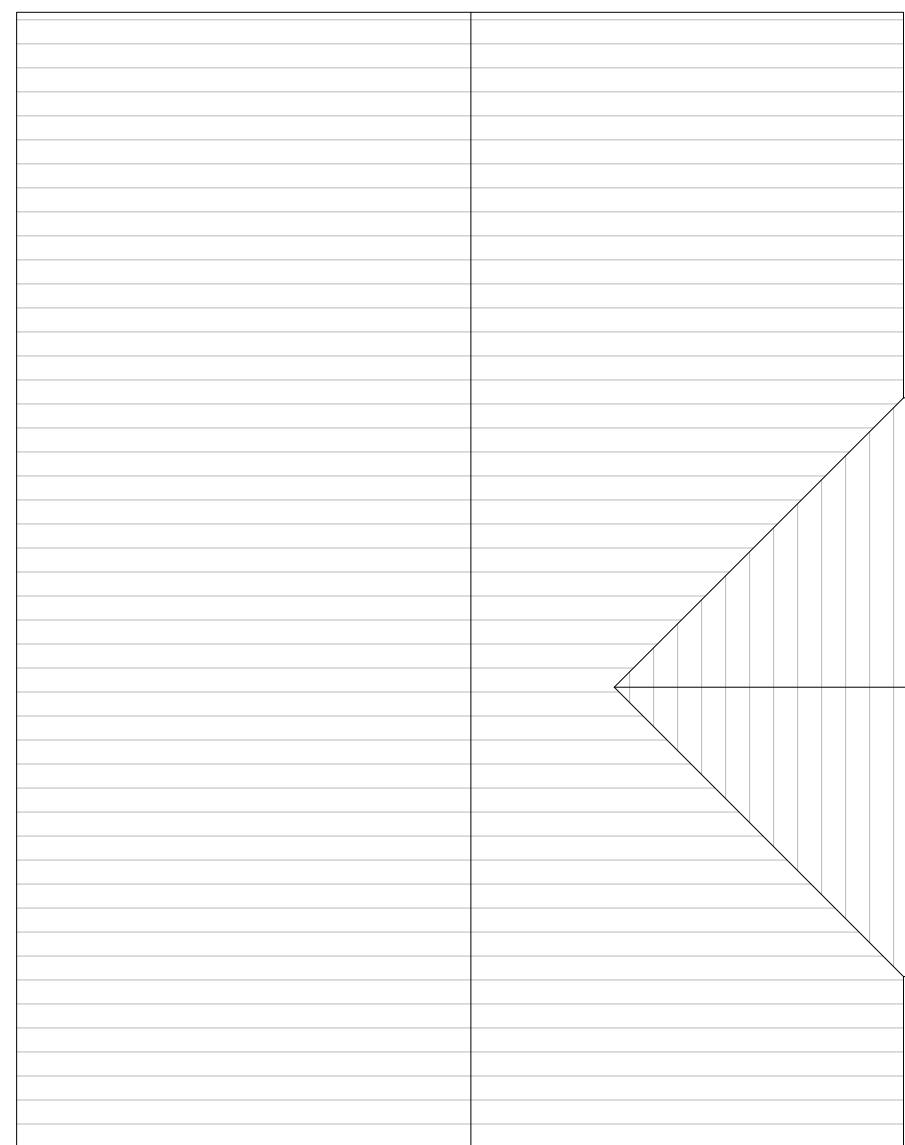

Proposed Roof Plan

0 0.5 1.0 1.5 2.0 2.5
metres 1:50 scale