

Key

- Metal cladding panels. Powder coated RAL 7035
- Gutters, roof flashing and downpipes. Powder coated RAL 7035
- Aluminium door/ glazing system
- Concertina doors for equipment access
- PV Panels
- Galvanised steel spiral round flue
- Aluminium louvres. Colour to match cladding
- Air source heat pump in aluminium louvre enclosure
- Metal insulated roof panels. RAL 7035

10. Aluminium fixed roof light


- Engineering brick plinth/wall base
- Gas canister storage in metal mesh cage
- Powder coated galvanised steel guarding/handrails
- Indicative Signage
- Condenser unit

Note:

Landscaping and signage indicative and subject to separate planning applications



East Elevation

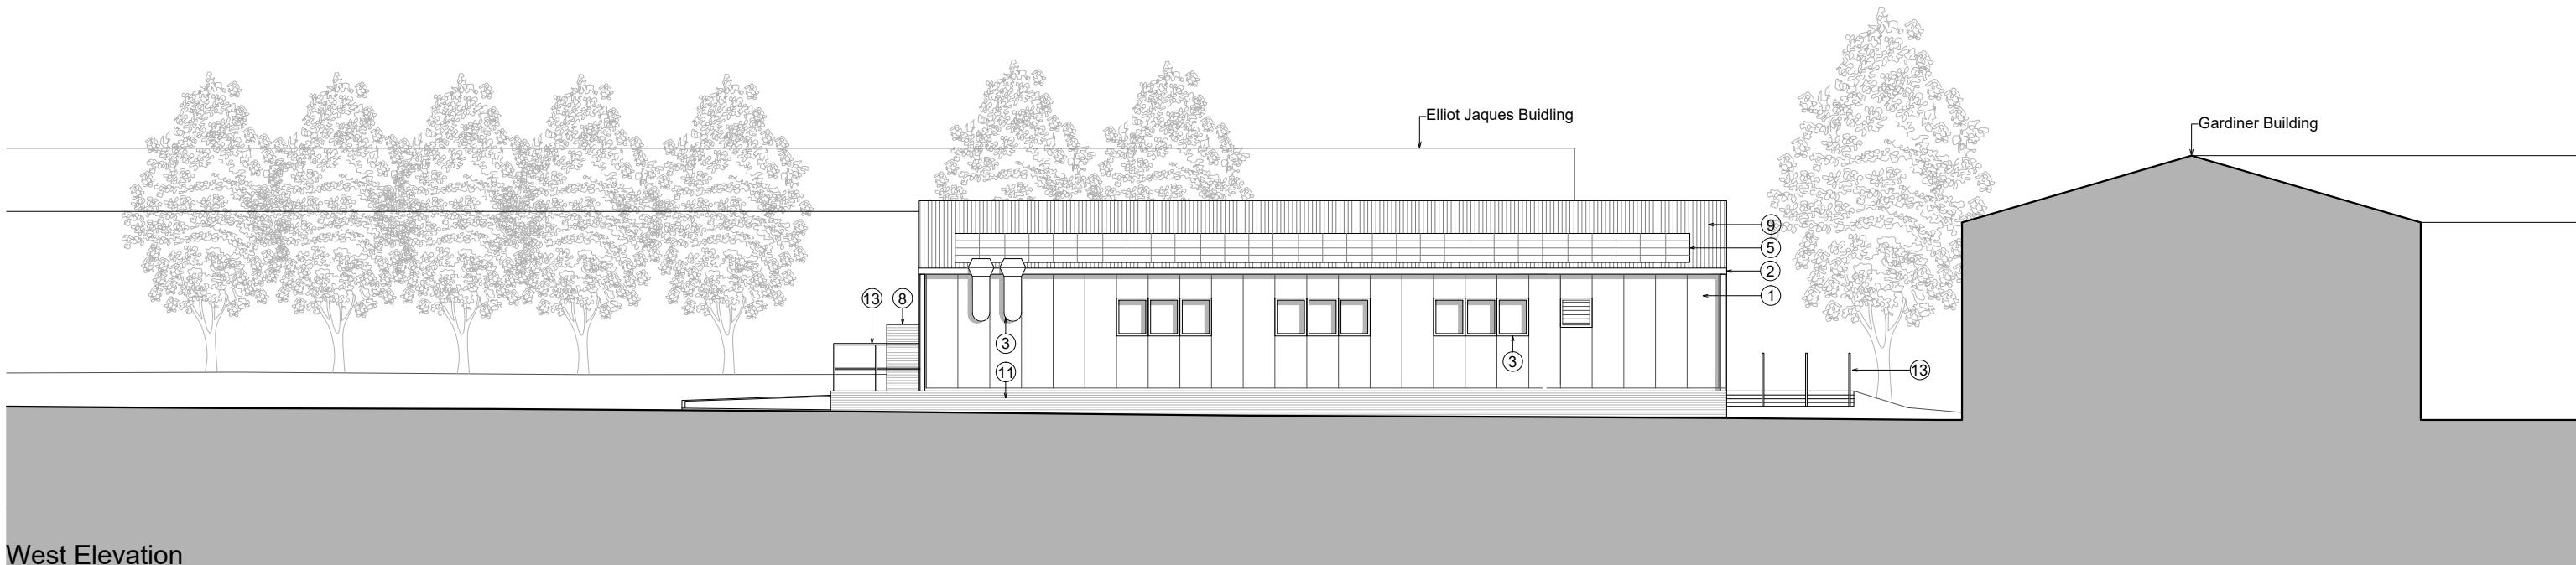

West Elevation

DRAWING NOTES	
1. filename: Proposed Elevation Building 3.dwg	REVISIONS
2. Do not scale this drawing in either paper or digital form. Use figured dimensions only. Detailed site survey to be carried out to establish tolerances. Figured dimensions are in mm. All dimensions shall be verified on site before proceeding with the work. The architect shall be notified of any discrepancies.	REV DATE STATUS
3. This drawing has been produced for sole use on this project and is not intended for use by any other person or for any other purpose. © Copyright RSS (U.K.)	P02 14.06.24 For planning
4. All printed copies should be made at 100% of the original page size. Use scale bars, where included, to check that the drawing has been printed to the intended scale as identified in the drawing title block.	Changes since last issue: Window positions updated
5. This drawing is not intended for construction unless specifically described as such.	

REVISIONS		
REV	DATE	STATUS



28 NAVIGATION ROAD LONDON E3 3TG
T : 020 7739 8945
E : rss@rss.co.uk
www.rivingtonstreetstudio.co.uk

rivingtonstreetstudio

job title Brunel University RAAC Replacement Buildings

drawing title Proposed East & West Elevation Site for Building 3

drawn by	job no.	suitability	revision	PROJECT	ORIGIN	VOLUME	LEVEL	TYPE	ROLE	NUMBER
RT /JY	1061	S4	P02	BUR	RSS	00	ZZ	DR	A	1421

scale 1:200