


#### Key


1. Metal cladding panels. Powder coated RAL 7035
2. Gutters, roof flashing and downpipes. Powder coated RAL 7035
3. Aluminium door/ glazing system. Grey RAL 7016
4. Concertina doors for equipment access
5. PV Panels
6. Galvanised steel spiral around flue
7. Aluminium louvres. Colour to match cladding
8. Air source heat pump in timber enclosure subject to separate planning app.

9. Metal faced insulated roof panels. RAL 7035
10. Aluminium fixed roof light
11. Engineering brick plinth/wallbase
12. Indicative Signage

**Note:**  
Landscaping and signage indicative and subject to separate planning applications

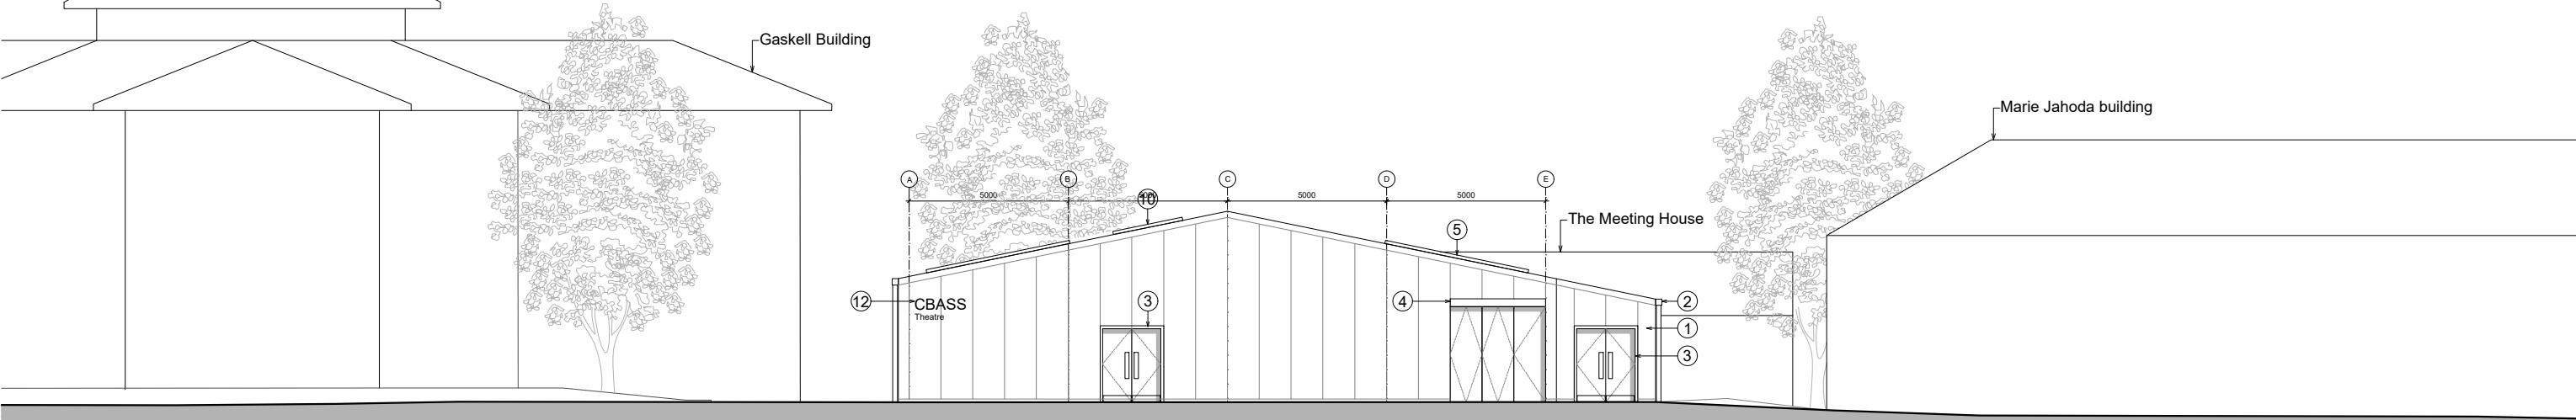


South Elevation

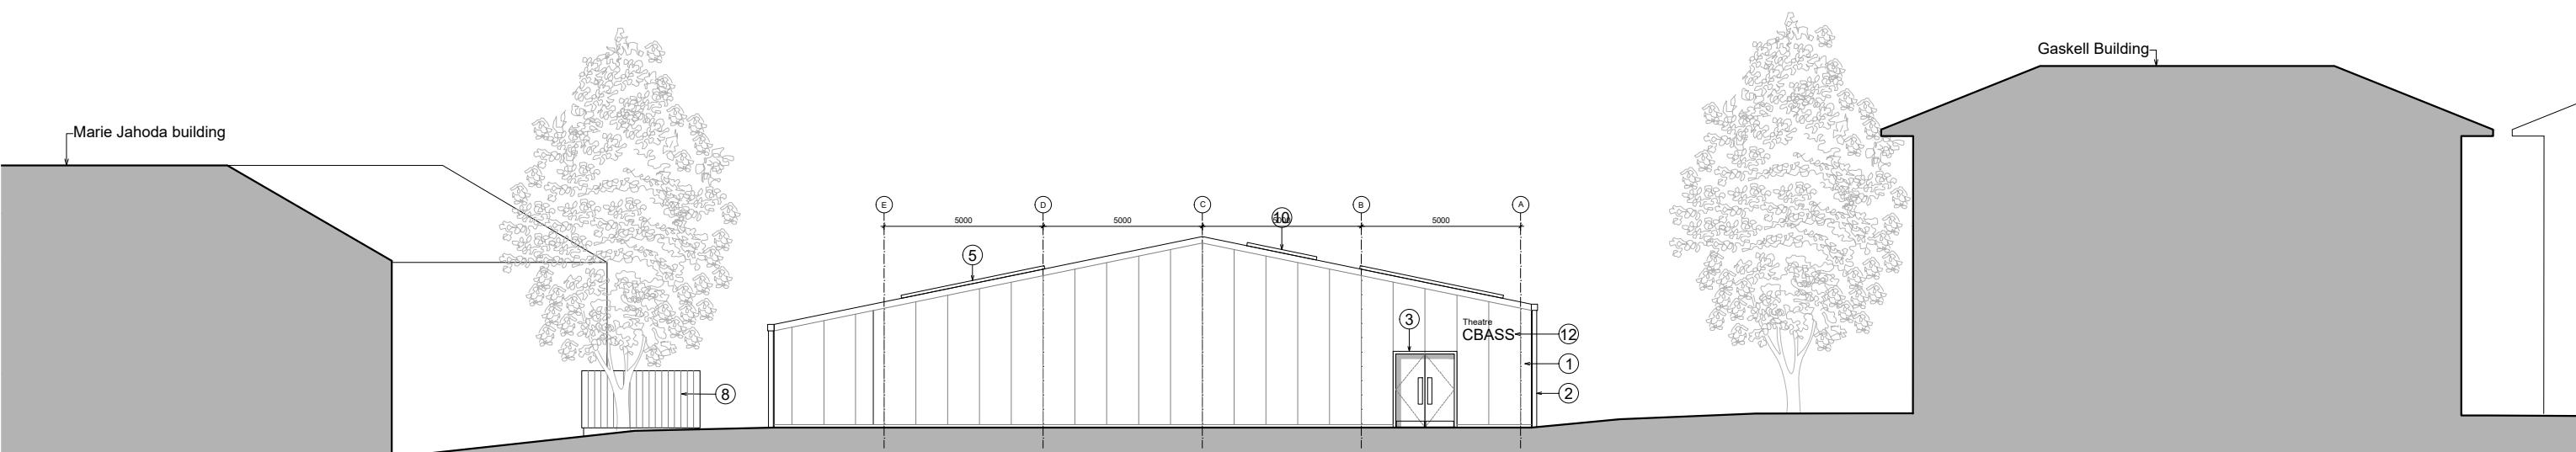

North Elevation

**DRAWING NOTES**  
1. filename: Proposed Elevation Building 2.dwg  
2. Do not scale this drawing in either paper or digital form. Use figured dimensions only. Detailed site survey to be carried out to establish tolerances. Figured dimensions are in mm. All dimensions shall be verified on site before proceeding with the work. The architect shall be notified of any discrepancies.  
3. This drawing has been produced for sole use on this project and is not intended for use by any other person or for any other purpose. © Copyright RSS (U.K.)  
4. All printed copies should be made at 100% of the original page size. Use scale bars, where included, to check that the drawing has been printed to the intended scale as identified in the drawing title block.  
5. This drawing is not intended for construction unless specifically described as such.

**REVISIONS**  
REV DATE STATUS  
P02 14.06.24 For planning  
  
Changes since last issue:  
Window positions updated

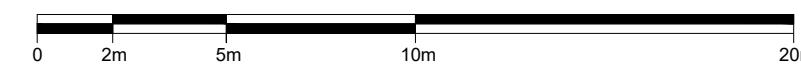

28 NAVIGATION ROAD LONDON E3 3TG  
T: 020 7739 8945  
E: rss@rss.co.uk  
www.rivingtonstreetstudio.co.uk

rivingtonstreetstudio

job title Brunel University RAAC Replacement Buildings

drawing title Existing South & North Elevation Site for Building 2

drawn by	job no.	suitability	revision	PROJECT	ORIGIN	VOLUME	LEVEL	TYPE	ROLE	NUMBER
RT /JY	1061	S4	P02	BUR	- RSS	- 00	- ZZ	- DR	- A	- 1410

scale 1:200