


**Existing Ground Floor Plan**

Scale 1:100

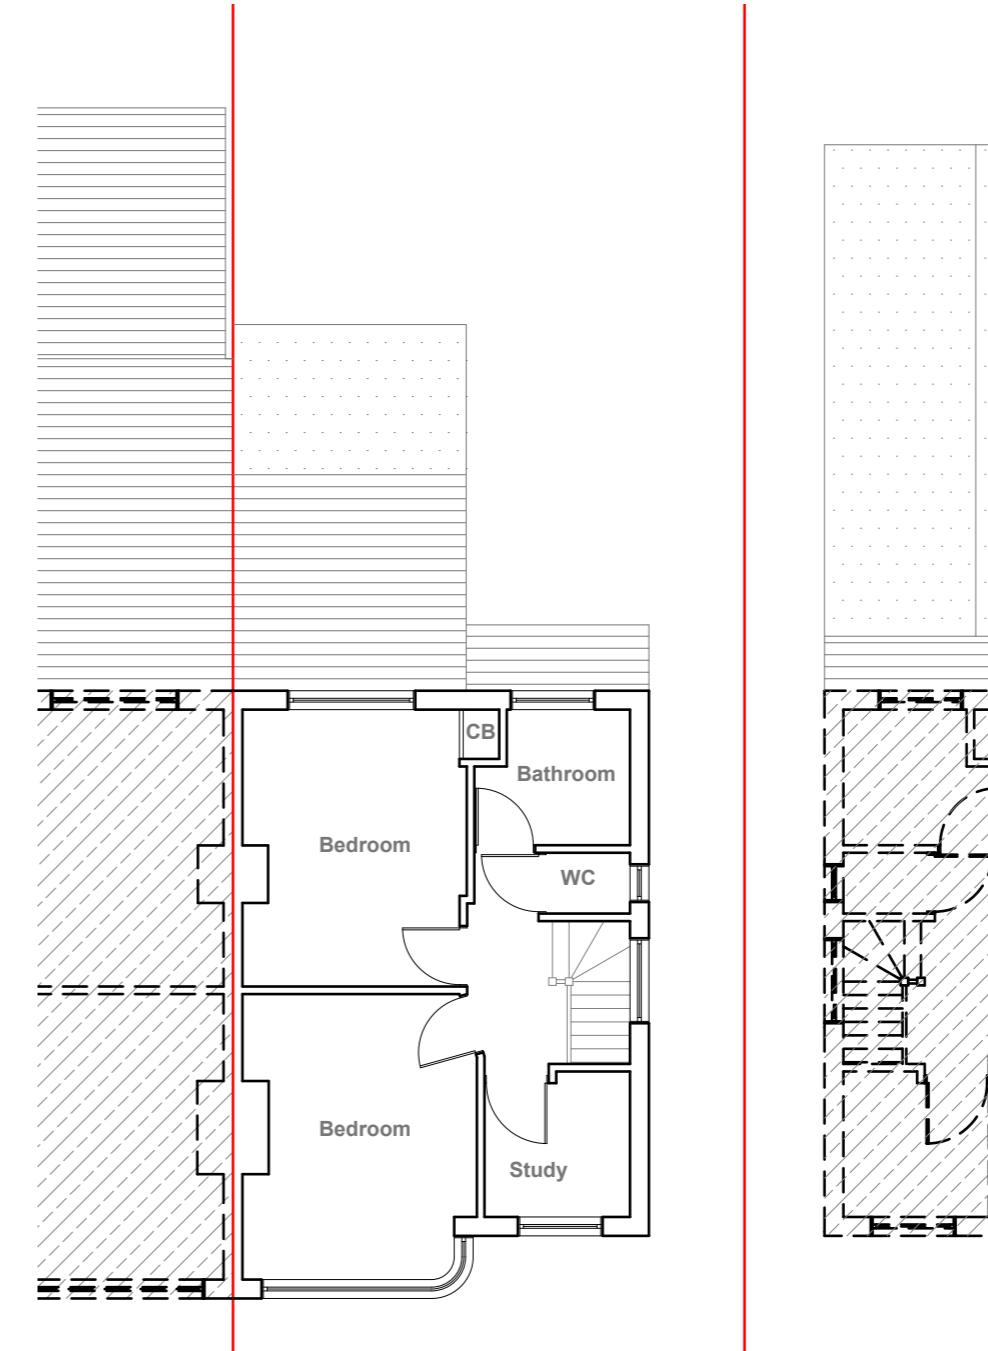

**Existing First Floor Plan**

Scale 1:100

10 Meter  
5  
2  
1  
0  
1:100

GENERAL NOTES:  
 1. ALL DIMENSIONS ARE IN MILLIMETER.  
 2. VERIFY ALL DIMENSIONS AND CONDITIONS BEFORE BUILDING OR  
 STARTING CONSTRUCTION. NOTIFY THE DESIGNER IMMEDIATELY OF ANY  
 DISCREPANCY OR VARIATION.  
 3. ALL WORK TO COMPLY WITH CURRENT BUILDING REGULATIONS  
 AND CODES OF PRACTICE

Title:

## Existing Floor Plans

Site Address  
26 Maple Road,  
Hayes,  
UB4 9LR

Scale: 1:100 @A3  
Date: 05/03/2024  
Drawing No.:  
2024/037 -01  
Drawn By:  
RO

Revision Date:  
\_\_\_\_\_  
\_\_\_\_\_  
\_\_\_\_\_  
\_\_\_\_\_  
e:mail -  
faluckpatel@yahoo.com  
(M) +44 (0) 7871 466 254

**Faluck  
Patel**




**Existing Front Elevation**  
Scale 1:100



**Existing Side Elevation**  
Scale 1:100



**Existing Rear Elevation**  
Scale 1:100

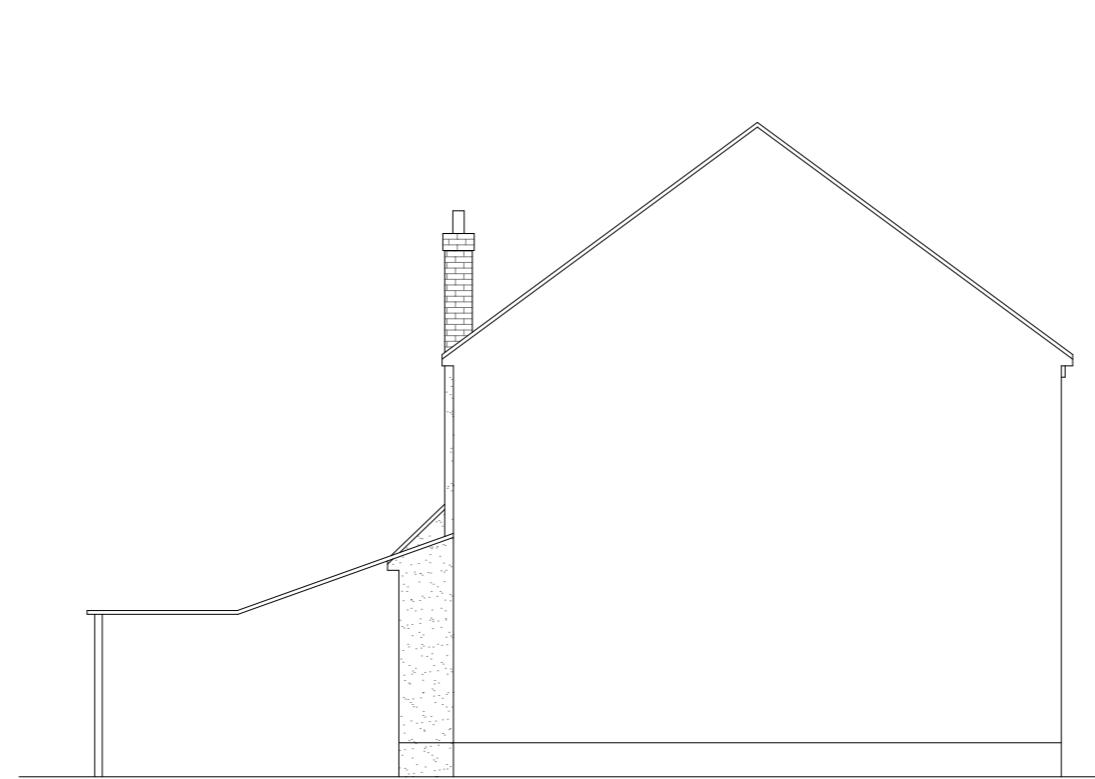

**Existing Side Elevation**  
Scale 1:100

10 Meter  
5  
2  
1  
0  
1:100

GENERAL NOTES:  
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Title:

## Existing Elevations



Site Address  
26 Maple Road,  
Hayes.  
UB4 9LR

Scale: 1:100 @A3  
Date: 05/03/2024  
Drawing No.:  
2024/037 -02  
Drawn By:  
RO

Revision Date:  
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**Faluck  
Patel**

Velux Window to be installed as per manufacturer specification, not projected more than 150mm from the plane of roof slope

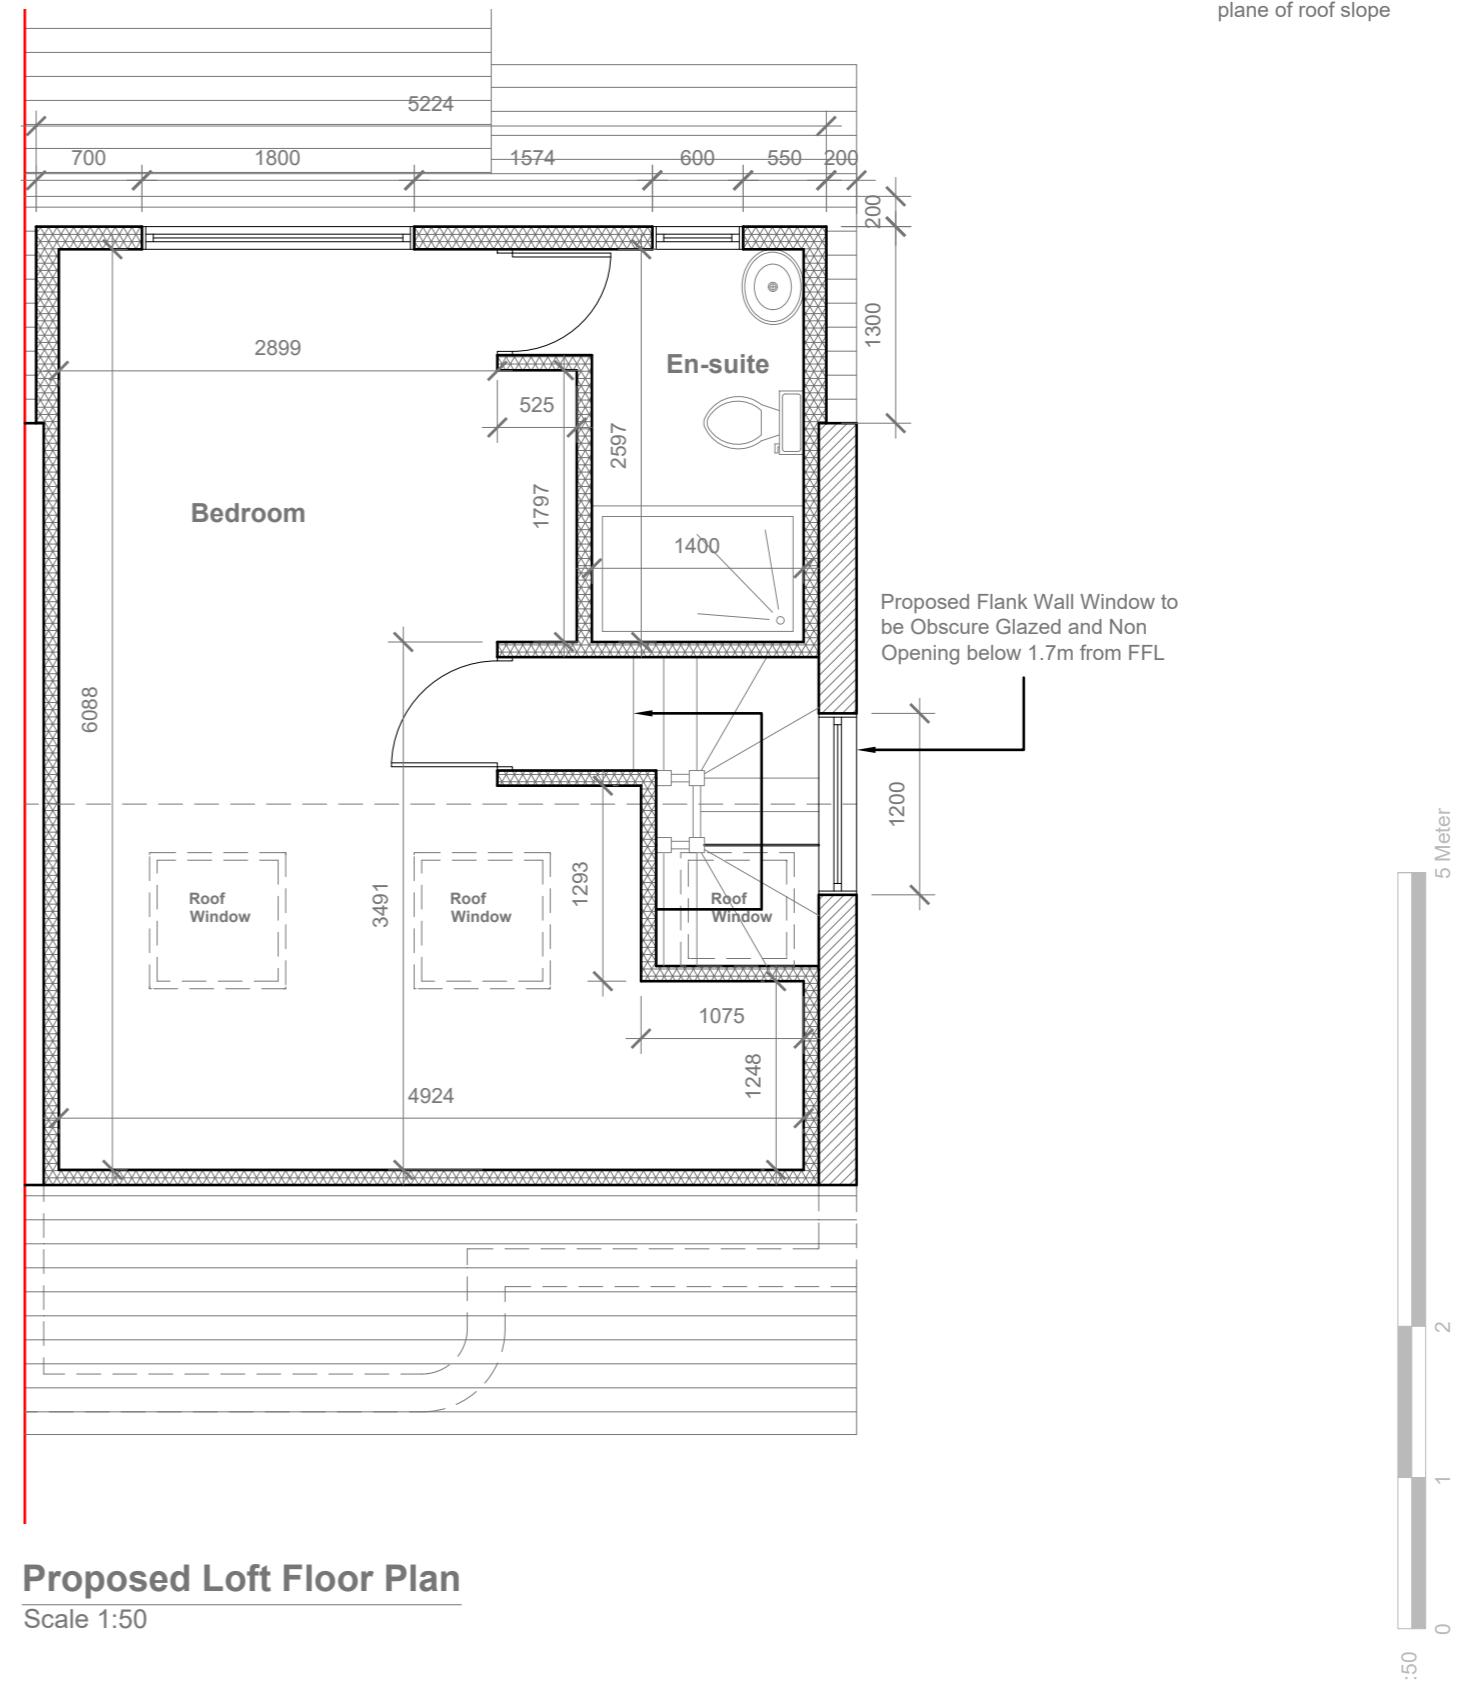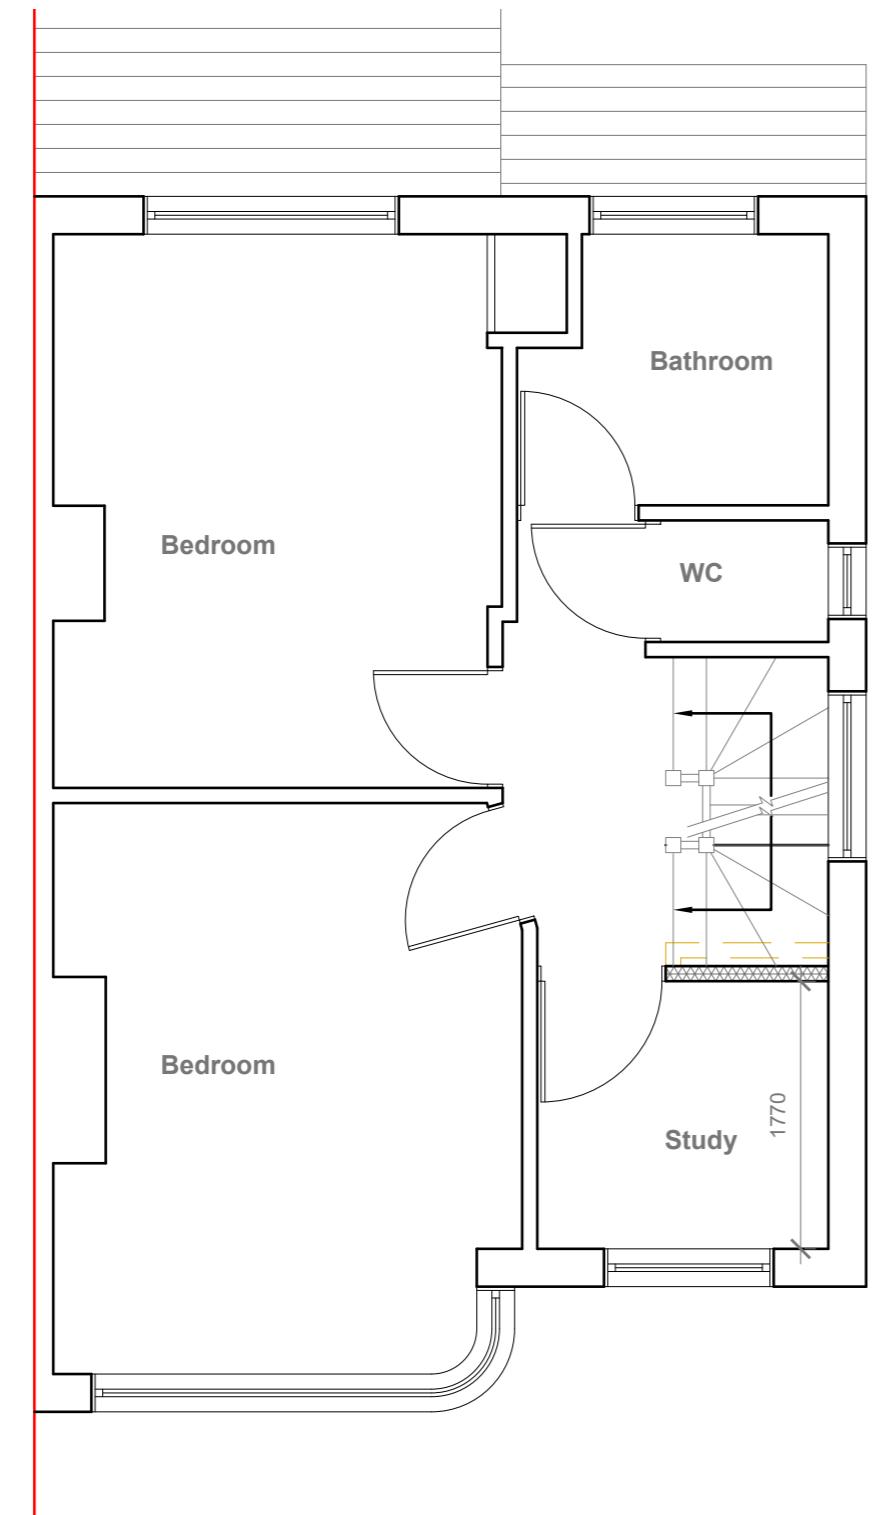

**GENERAL NOTES:**

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**Title:**

## Proposed First Floor & Loft Plans

**Site Address**

26 Maple Road,  
Hayes.  
UB4 9LR

**Scale: 1:50 @A3**


Date: 05/03/2024  
Drawing No.: 2024/037 -03

**Revision Date:**


Drawn By:  
RO

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**Faluck Patel**

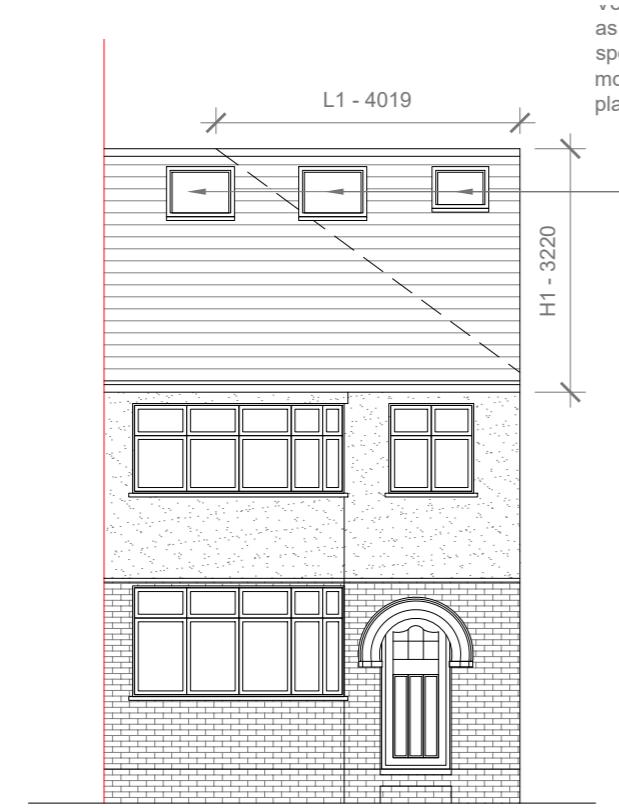


**Proposed Front Elevation**  
Scale 1:100

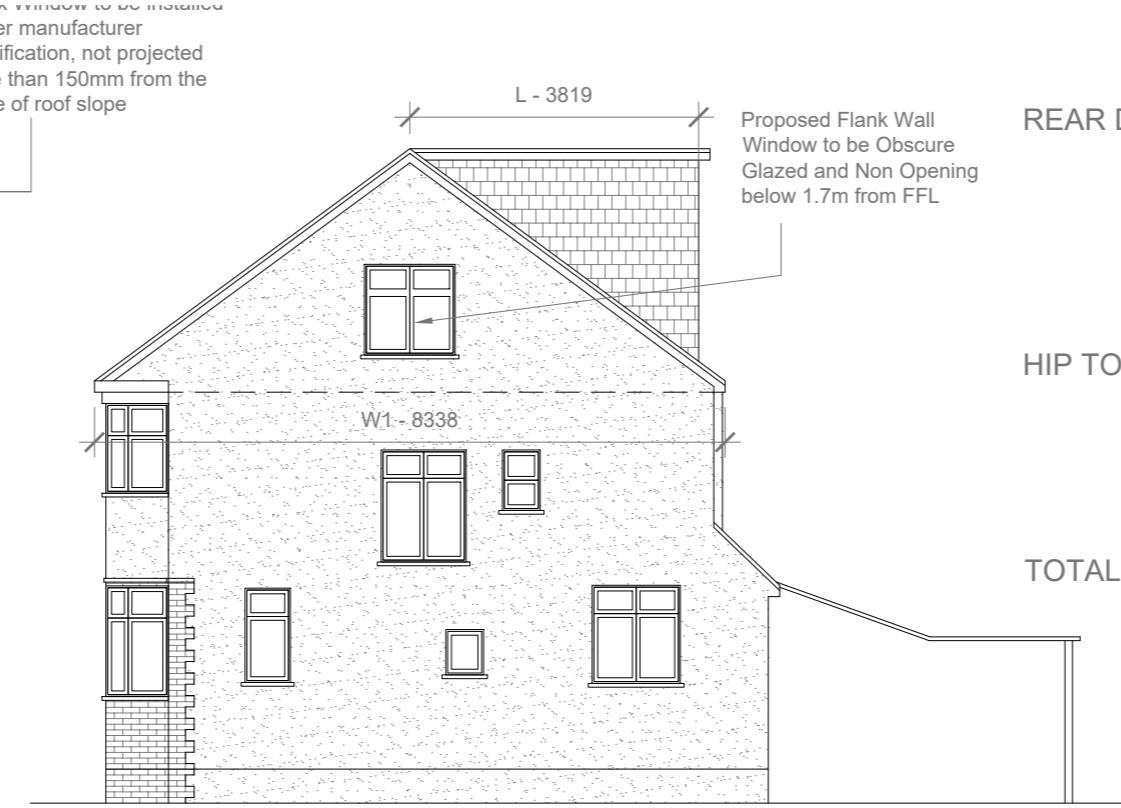

**Proposed Side Elevation**  
Scale 1:100



**Proposed Rear Elevation**  
Scale 1:100

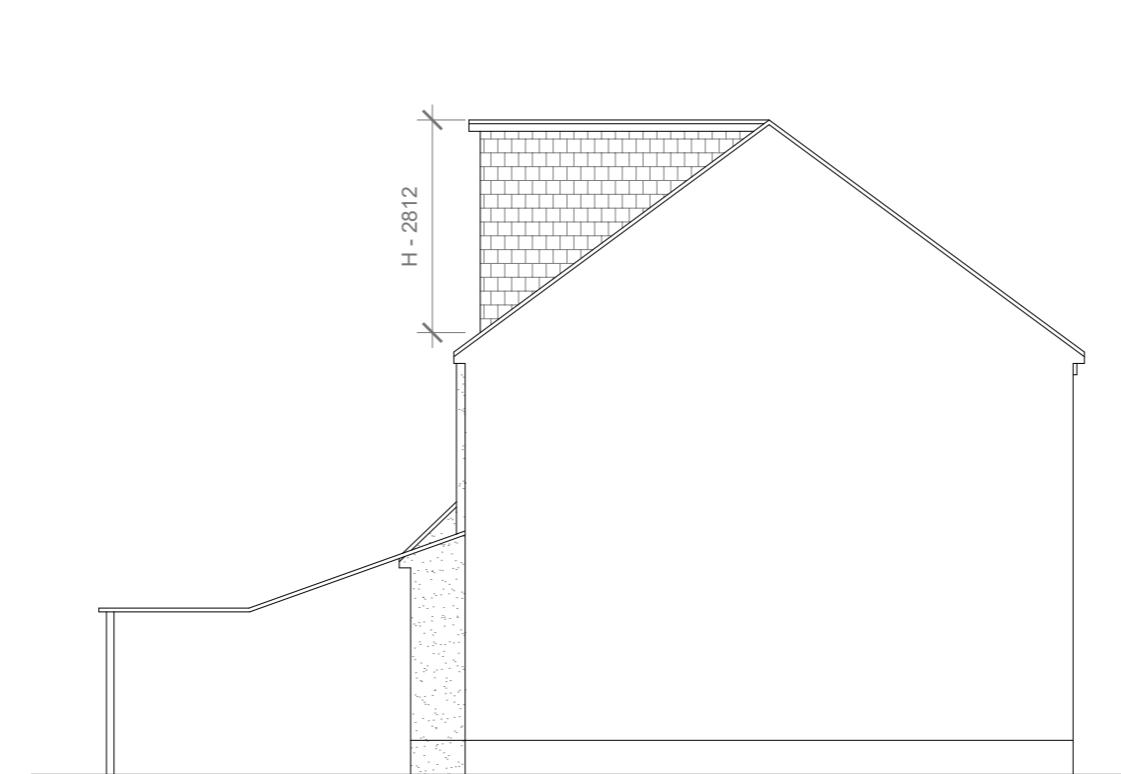

**Proposed Side Elevation**  
Scale 1:100

REAR DORMER VOLUME =

V1 =

W X H X L / 2  
5.224 X 2.812 X 3.819 / 2  
56.10 / 2  
28.05 CU.MT.

HIP TO GABLE ROOF VOLUME =

V2 =

W1 X H1 X L1 / 6  
8.338 X 3.220 X 4.019 / 6  
107.90 / 6  
17.98 CU.MT.

TOTAL ROOF VOLUME =

V1 + V2  
28.05 + 17.98  
46.03 CU.MT. < 50.00 CU.MT

Proposed External Finish Materials to Match Existing External Finish Materials

10 Meter  
5  
2  
1  
0  
1:100

GENERAL NOTES:  
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AND CODES OF PRACTICE

Title:

## Proposed Elevations

Site Address

26 Maple Road,  
Hayes.  
UB4 9LR

Scale: 1:100 @A3

Date: 05/03/2024  
Drawing No.: 2024/037 -04

Revision Date:

Drawn By:  
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**Faluck Patel**