



MATERIALS USED IN THE
CONSTRUCTION OF THE
OUTBUILDINGS WILL
MATCH THE MAIN DWELLINGS

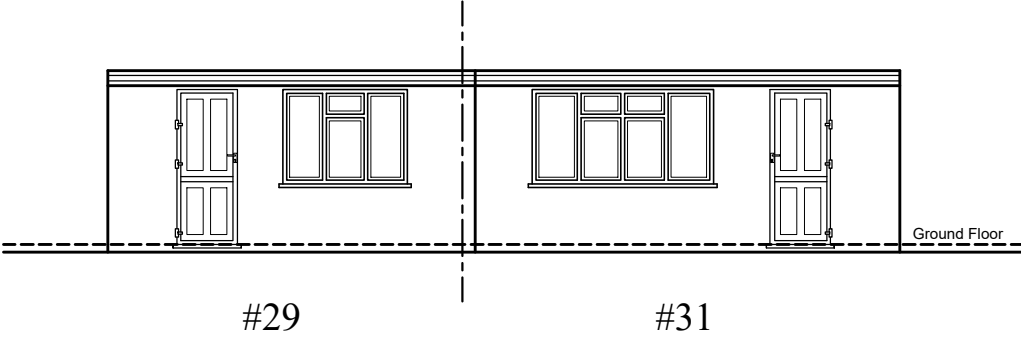

PROPOSED FRONT ELEVATION

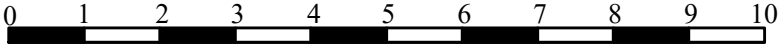

SCALE BAR 1:100
(1cm = 1M)

REFERENCE		NOTES: ALL DIMENSIONS TO BE CHECKED ON SITE PRIOR TO COMMENCEMENT OF WORKS. BEFORE BUILDING WORKS COMMENCES IT IS THE RESPONSIBILITY OF THE BUILDER OR OWNER TO SERVE PARTY WALL NOTICE. CLIENT TO ENSURE ALL OF THE CONTRACTORS' WORK ON SITE TO COMPLY WITH AND MEET APPROVAL OF THE RELEVANT BRITISH STANDARDS AND LOCAL AUTHORITY INCLUDING PLANNING AND BUILDING CONTROL DEPARTMENTS.	CONSULTANT: TECH ENGINEERING (UK) LTD. UNIT 2, 133B ILFORD LANE. ILFORD. IG1 2RP Tel: 020 3343 8334; Mob: 078 8885 0200 E: tech.engineering@yahoo.co.uk ; W: www.tech-engineering.co.uk	DRAWN GM CHECKED FH	CLIENT/PROJECT 29-31 WHITTINGTON AVENUE HAYES. UB4 0AD	TITLE FRONT ELEVATION	DRAWING NO: SH2-04	
							SCALE: 1:100 @ A3	
							DATE: 18-01-2024	