



GENERAL NOTES


- CHECK ALL DIMENSIONS ON SITE.
- ALL DIMENSIONS ARE IN MILLIMETRES UNLESS OTHERWISE STATED.
- ALL VERTICAL MEASUREMENTS ASSUME GROUND TO BE LEVEL UNLESS OTHERWISE STATED.
- THIS DRAWING SHOULD BE READ IN CONJUNCTION WITH THE GENERAL NOTES.
- WORKS TO BE CARRIED OUT WITH MATERIALS AND WORKMANSHIP IN COMPLIANCE WITH APPROVED DOCUMENT FOR REGULATION 7 (THE AMENDED BUILDING REGULATIONS 2013)
- WORKS TO BE CARRIED OUT IN A SAFE MANNER IN ACCORDANCE WITH CDM REGULATIONS 2015.
- OPEN UP EXISTING STRUCTURE AS REQUIRED BY THE BUILDING INSPECTOR
- THIRD PARTY SUPPLIER TO MEASURE ON SITE BEFORE MANUFACTURING
- GENERAL CONTRACTOR TO VERIFY FIELD CONDITIONS PRIOR TO COMMENCEMENT OF EACH PORTION OF THE WORK.
- ANY DISCREPANCIES IN THESE DRAWINGS SHOULD BE NOTIFIED TO US PRIOR TO ANY WORKS PROCEEDING.
- UNLESS OTHERWISE INDICATED, PLAN DIMENSIONS ARE TO COLUMN GRID ON CENTERLINES, NOMINAL SURFACE OF MASONRY, FACE OF STUDS AND FACE OF CONCRETE WALLS AND BEAM CENTRE TO CENTRES.
- "FLOOR LINE" REFERS TO TOP OF CONCRETE SLABS, FINISH FLOORING IS INSTALLED ABOVE THE FLOOR LINE. FOR DEPRESSED FLOORS AND CURBS, SEE STRUCTURAL DRAWINGS.
- REPETITIVE FEATURES ARE NOT ALWAYS DRAWN IN THEIR ENTIRETY AND SHALL BE COMPLETELY PROVIDED AS IF DRAWN IN FULL.
- WHERE A DOOR IS LOCATED NEAR CORNER OF ROOM AND IS NOT LOCATED BY DIMENSION ON PLAN OR DETAILS, DIMENSION SHALL BE 100MM FROM FACE OF STUD (WALL).
- LINE OF EXISTING FLOOR SLABS, AS SHOWN ON THE BUILDING ELEVATIONS AND SECTIONS ARE APPROXIMATE.
- FLOOR LEVELS AND BOUNDARIES ASSUMED WHERE NOTED, DEPICTED BY LINE DASH LINES.
- REFER TO ARCHITECTURAL, STRUCTURAL, MECHANICAL, ELECTRICAL, GENERAL SPECIFICATION AND OTHER CATEGORIES OR DRAWINGS FOR ADDITIONAL NOTES.
- VERIFY SIZE/LOCATION/FINISH/FIRE-RATING, ETC. AND PROVIDE COMPLETE AND REQUIRED OPENINGS THROUGH FLOORS AND WALLS, ACCESS DOORS, FURRING, CURBS, ANCHORS & INSERTS.
- CONTRACTOR TO CARRY OUT MOST LOGICAL SOLUTION BUT TO CHECK WITH ARCHITECT OR ENGINEER IF UNSURE, REQUESTS BY CLIENTS THAT DEVIATE FROM DESIGN VOIDS THE DESIGN LIABILITY.
- SEE STRUCTURAL GENERAL NOTES AND PLANS TO COMPLEMENT ARCHITECTURAL PLANS AT ALL TIMES, DO NOT ASSUME ANYTHING.
- STAIR LAYOUTS AND DESIGNS ARE INDICATIVE SIZE AND POSITION FOR BUILDING CONTROL APPROVAL, NOT TO BE USED AS CONSTRUCTION DRAWINGS. FINAL STAIR SPECIFICATIONS TBC FROM STAIR SUPPLIER.
- ALL DIMENSIONS ARE INDICATIVE AND TO BE CONFIRMED ON SITE BY CONTRACTOR.
- THIS DRAWING SET IS FOR PLANNING OR BUILDING CONTROL APPROVAL AND NOT TO BE USED AS FINAL CONSTRUCTION DRAWINGS, UNLESS STATED OTHERWISE.

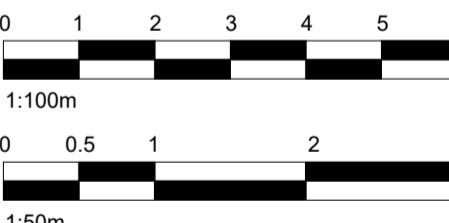

No.:	Revision:	Date:
BISCHELL THE DESIGN & BUILD COMPANY		
Bischell - Design & Build - Suite 114 80 Cumberland House, Scrubs Lane Hammersmith & Fulham, NW10 6RF www.bischell.co.uk		
Client:	20 Seaton Gardens, Ruislip HA4 0AX, UK	
Drawing Title:	Block and Location Plan	
Status:	PN	
Scale:	As indicated @A2	Date: 13/03/2024 Drawn By: SR
Drawing No.:	PN-002 Rev:	

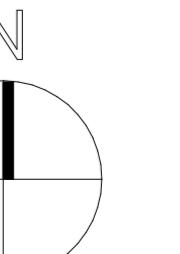



APPLICATION SITE

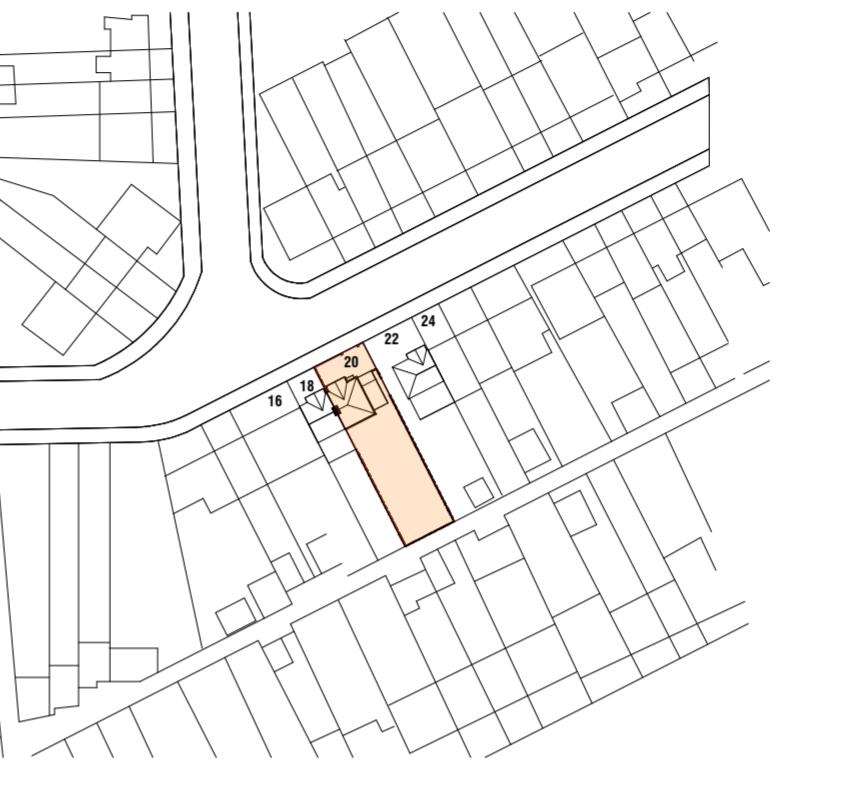

2 Location Plan
1 : 1250

GENERAL NOTES


1. CHECK ALL DIMENSIONS ON SITE.
2. ALL DIMENSIONS ARE IN MILLIMETRES UNLESS OTHERWISE STATED.
3. ALL VERTICAL MEASUREMENTS ASSUME GROUND TO BE LEVEL UNLESS OTHERWISE STATED.
4. THIS DRAWING SHOULD BE READ IN CONJUNCTION WITH THE GENERAL NOTES.
5. WORKS TO BE CARRIED OUT WITH MATERIALS AND WORKMANSHIP IN COMPLIANCE WITH APPROVED DOCUMENT FOR REGULATION 7 (THE AMENDED BUILDING REGULATIONS 2013)
6. WORKS TO BE CARRIED OUT IN A SAFE MANNER IN ACCORDANCE WITH CDM REGULATIONS 2015.
7. OPEN UP EXISTING STRUCTURE AS REQUIRED BY THE BUILDING INSPECTOR
8. THIRD PARTY SUPPLIER TO MEASURE ON SITE BEFORE MANUFACTURING
9. GENERAL CONTRACTOR TO VERIFY FIELD CONDITIONS PRIOR TO COMMENCEMENT OF EACH PORTION OF THE WORK.
10. ANY DISCREPANCIES IN THESE DRAWINGS SHOULD BE NOTIFIED TO US PRIOR TO ANY WORKS PROCEEDING.
11. UNLESS OTHERWISE INDICATED, PLAN DIMENSIONS ARE TO COLUMN GRID ON CENTERLINES, NOMINAL SURFACE OF MASONRY, FACE OF STUDS AND FACE OF CONCRETE WALLS AND BEAM CENTRE TO CENTRES.
12. "FLOOR LINE" REFERS TO TOP OF CONCRETE SLABS. FINISH FLOORING IS INSTALLED ABOVE THE FLOOR LINE. FOR DEPRESSED FLOORS AND CURBS, SEE STRUCTURAL DRAWINGS.
13. REPETITIVE FEATURES ARE NOT ALWAYS DRAWN IN THEIR ENTIRETY AND SHALL BE COMPLETELY PROVIDED AS IF DRAWN IN FULL.
14. WHERE A DOOR IS LOCATED NEAR CORNER OF ROOM AND IS NOT LOCATED BY DIMENSION ON PLAN OR DETAILS, DIMENSION SHALL BE 100MM FROM FACE OF STUD (WALL).
15. LINE OF EXISTING FLOOR SLABS, AS SHOWN ON THE BUILDING ELEVATIONS AND SECTIONS ARE APPROXIMATE.
16. FLOOR LEVELS AND BOUNDARIES ASSUMED WHERE NOTED, DEPICTED BY LINE DASH LINES.
17. REFER TO ARCHITECTURAL, STRUCTURAL, MECHANICAL, ELECTRICAL, GENERAL SPECIFICATION AND OTHER CATEGORIES OR DRAWINGS FOR ADDITIONAL NOTES.
18. VERIFY SIZE/LOCATION/FINISH/FIRE-RATING, ETC. AND PROVIDE COMPLETE AND REQUIRED OPENINGS THROUGH FLOORS AND WALLS, ACCESS DOORS, FURRING, CURBS, ANCHORS & INSERTS.
19. CONTRACTOR TO CARRY OUT MOST LOGICAL SOLUTION BUT TO CHECK WITH ARCHITECT OR ENGINEER IF UNSURE. REQUESTS BY CLIENTS THAT DEVIATE FROM DESIGN VOIDS THE DESIGN LIABILITY.
20. SEE STRUCTURAL GENERAL NOTES AND PLANS TO COMPLEMENT ARCHITECTURAL PLANS AT ALL TIMES, DO NOT ASSUME ANYTHING.
21. STAIR LAYOUTS AND DESIGNS ARE INDICATIVE SIZE AND POSITION FOR BUILDING CONTROL APPROVAL, NOT TO BE USED AS CONSTRUCTION DRAWINGS. FINAL STAIR SPECIFICATIONS TBC FROM STAIR SUPPLIER.
22. ALL DIMENSIONS ARE INDICATIVE AND TO BE CONFIRMED ON SITE BY CONTRACTOR.
23. THIS DRAWING SET IS FOR PLANNING OR BUILDING CONTROL APPROVAL AND NOT TO BE USED AS FINAL CONSTRUCTION DRAWINGS, UNLESS STATED OTHERWISE.

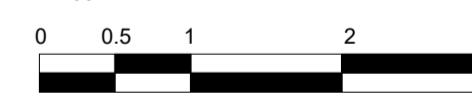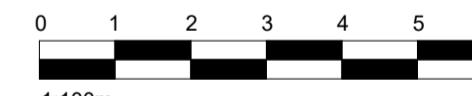

No.:	Revision:	Date:
 BISCHELL THE DESIGN & BUILD COMPANY		
Bischell - Design & Build - Suite 114 80 Cumberland House, Scrubs Lane Hammersmith & Fulham, NW10 6RF www.bischell.co.uk		
Client:	20 Seaton Gardens, Ruislip HA4 0AX, UK	
Drawing Title:	Site Plan	
Status:	PN	
Scale:	1 : 100 @A2	Date: 13/03/2024
Drawing No.:	Rev: PN-003	


1 Site Plan - Existing

1 : 100

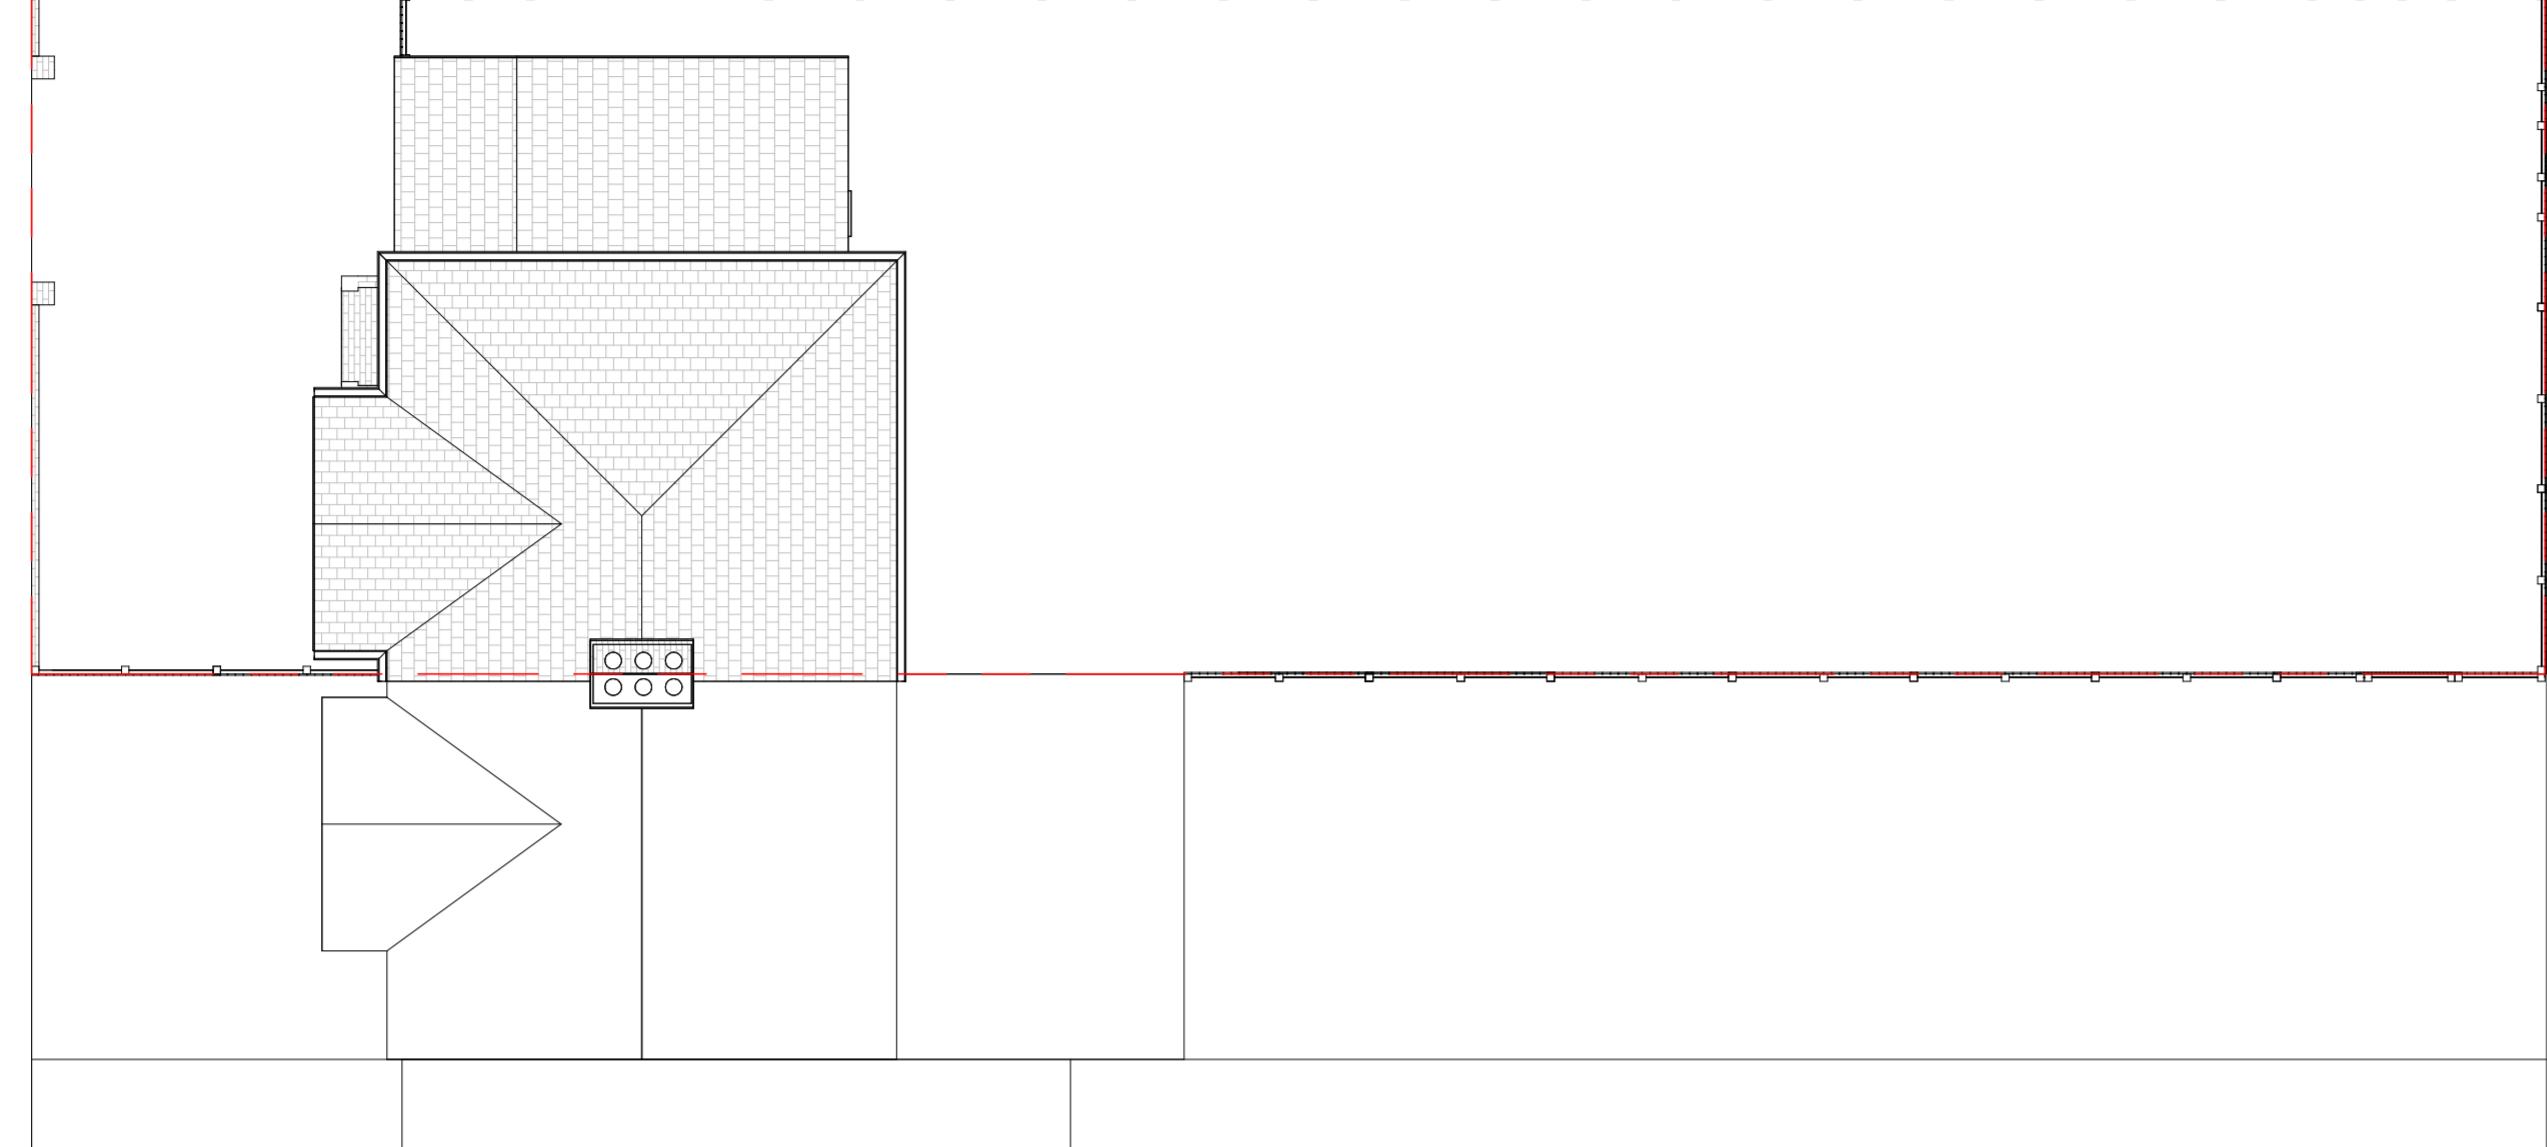


2 Site Plan - Proposed

1 : 100

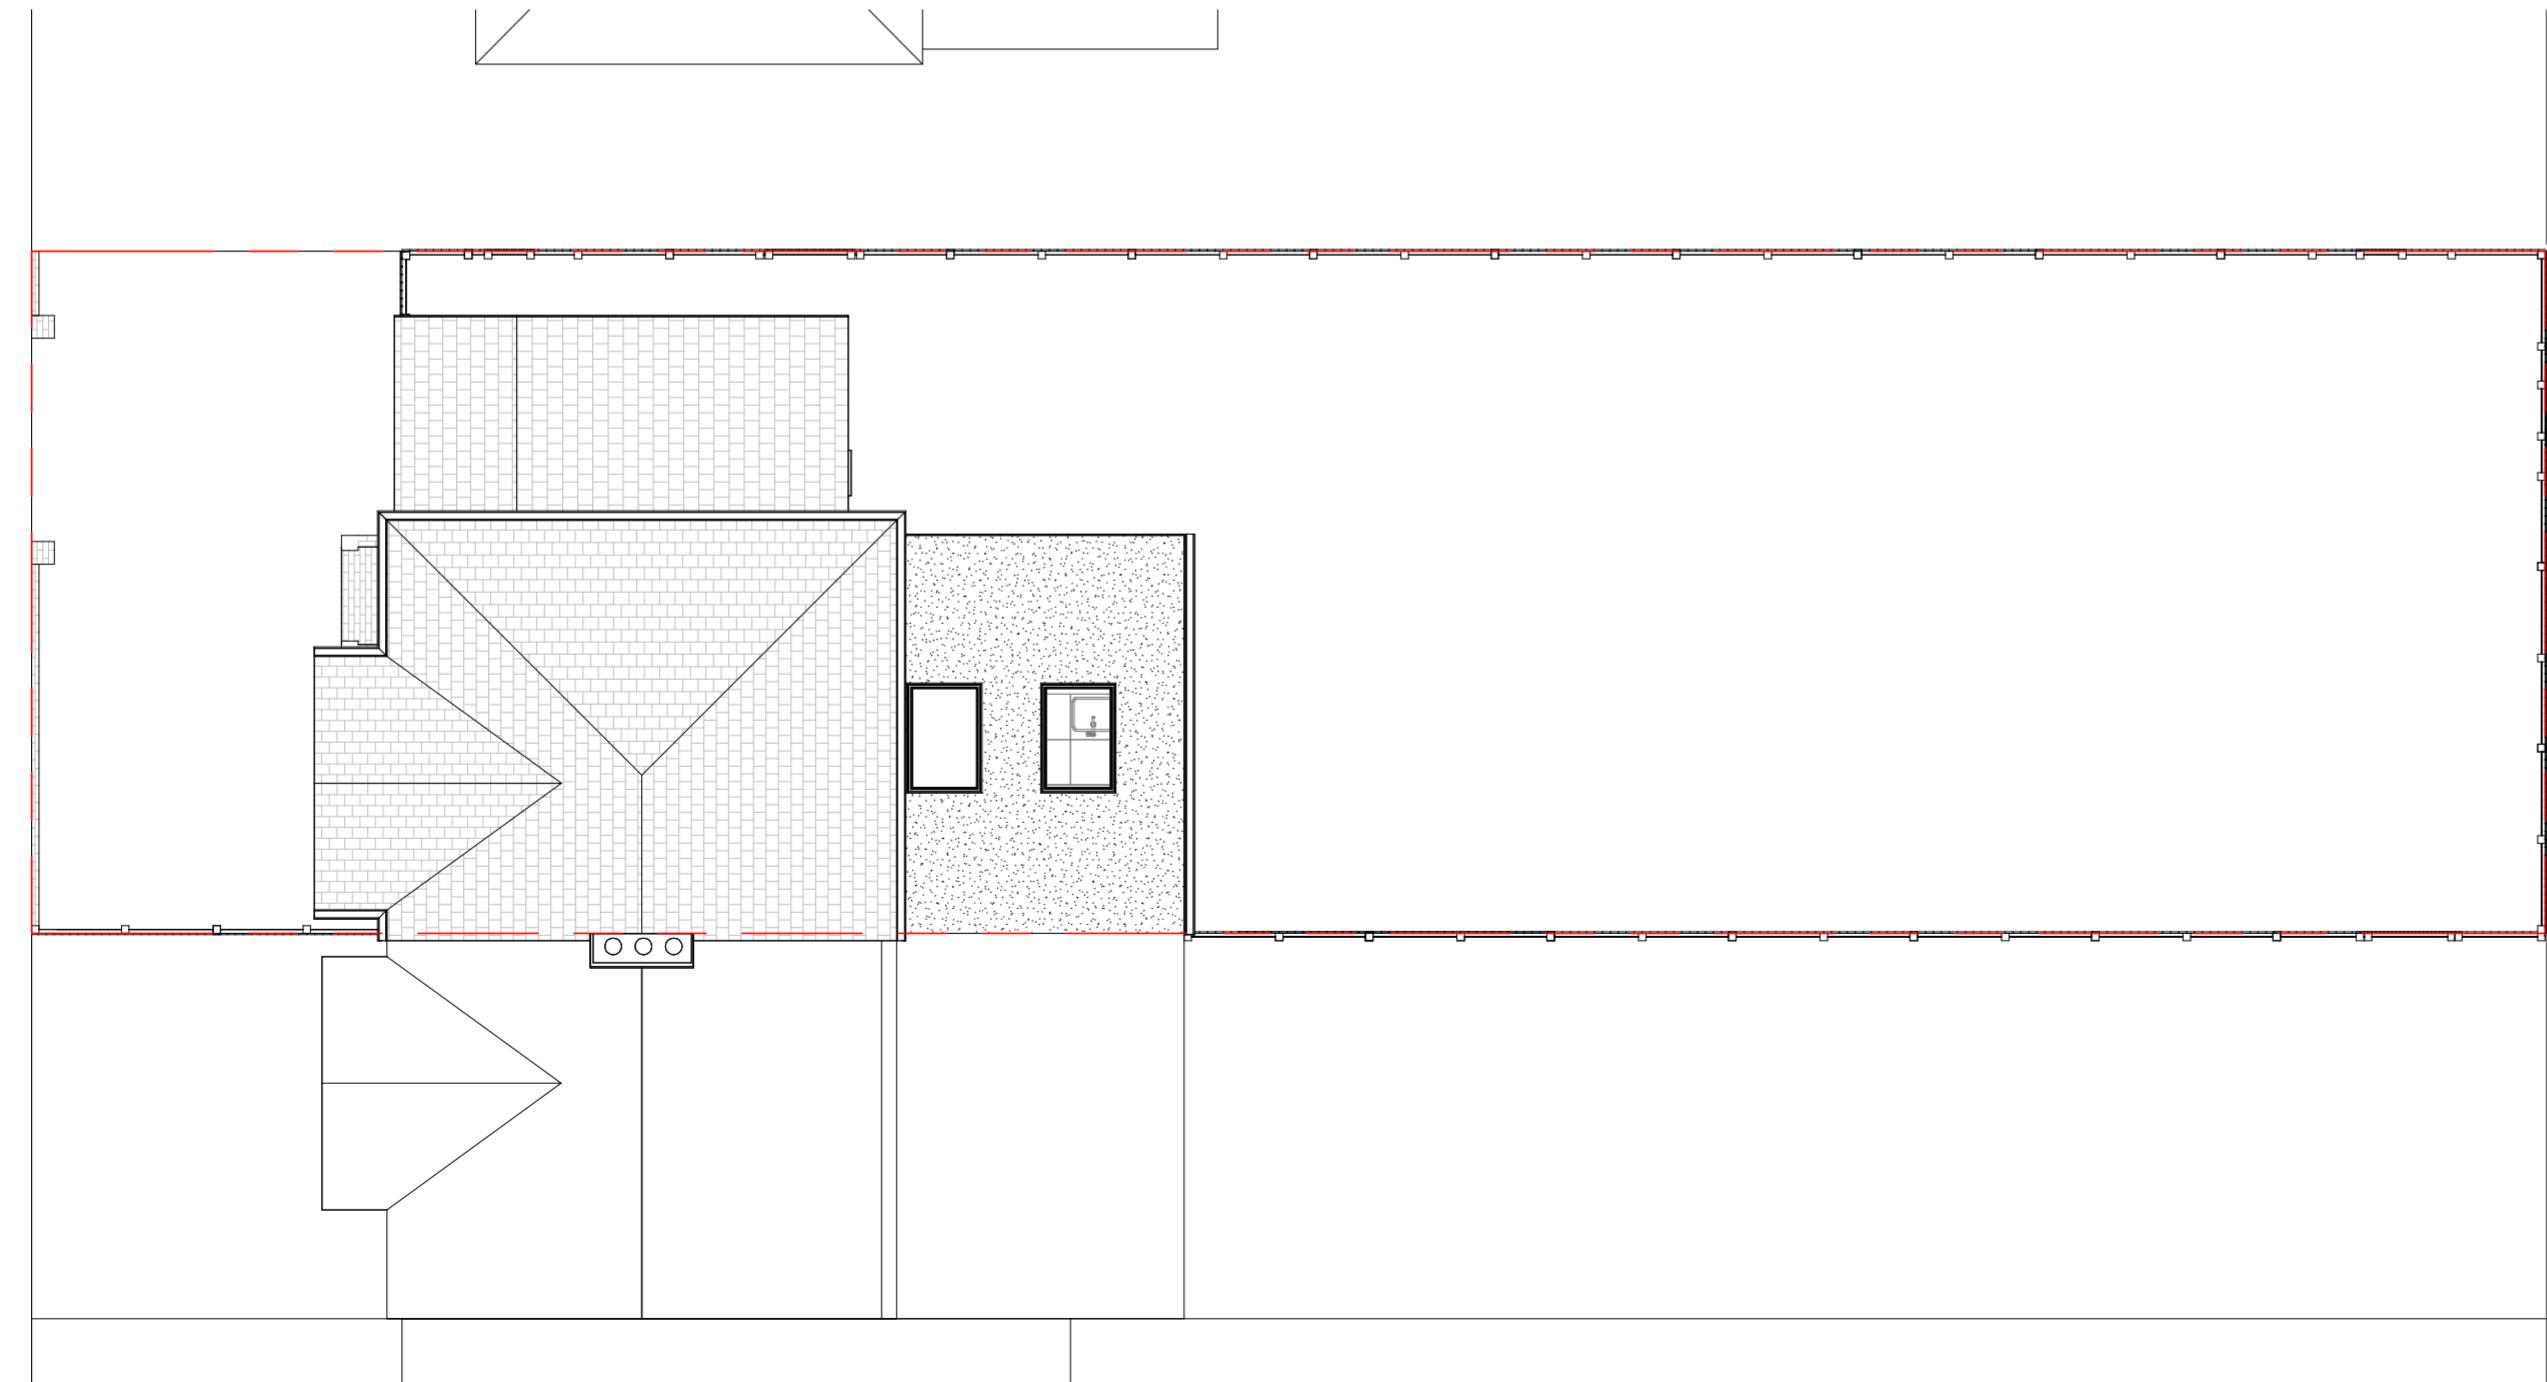


GENERAL NOTES

1. CHECK ALL DIMENSIONS ON SITE.
2. ALL DIMENSIONS ARE IN MILLIMETRES UNLESS OTHERWISE STATED.
3. ALL VERTICAL MEASUREMENTS ASSUME GROUND TO BE LEVEL UNLESS OTHERWISE STATED.
4. THIS DRAWING SHOULD BE READ IN CONJUNCTION WITH THE GENERAL NOTES.
5. WORKS TO BE CARRIED OUT WITH MATERIALS AND WORKMANSHIP IN COMPLIANCE WITH APPROVED DOCUMENT FOR REGULATION 7 (THE AMENDED BUILDING REGULATIONS 2013)
6. WORKS TO BE CARRIED OUT IN A SAFE MANNER IN ACCORDANCE WITH CDM REGULATIONS 2015.
7. OPEN UP EXISTING STRUCTURE AS REQUIRED BY THE BUILDING INSPECTOR
8. THIRD PARTY SUPPLIER TO MEASURE ON SITE BEFORE MANUFACTURING
9. GENERAL CONTRACTOR TO VERIFY FIELD CONDITIONS PRIOR TO COMMENCEMENT OF EACH PORTION OF THE WORK.
10. ANY DISCREPANCIES IN THESE DRAWINGS SHOULD BE NOTIFIED TO US PRIOR TO ANY WORKS PROCEEDING.
11. UNLESS OTHERWISE INDICATED, PLAN DIMENSIONS ARE TO COLUMN GRID ON CENTERLINES, NOMINAL SURFACE OF MASONRY, FACE OF STUDS AND FACE OF CONCRETE WALLS AND BEAM CENTRE TO CENTRES.
12. "FLOOR LINE" REFERS TO TOP OF CONCRETE SLABS, FINISH FLOORING IS INSTALLED ABOVE THE FLOOR LINE. FOR DEPRESSED FLOORS AND CURBS, SEE STRUCTURAL DRAWINGS.
13. REPETITIVE FEATURES ARE NOT ALWAYS DRAWN IN THEIR ENTIRETY AND SHALL BE COMPLETELY PROVIDED AS IF DRAWN IN FULL.
14. WHERE A DOOR IS LOCATED NEAR CORNER OF ROOM AND IS NOT LOCATED BY DIMENSION ON PLAN OR DETAILS, DIMENSION SHALL BE 100MM FROM FACE OF STUD (WALL).
15. LINE OF EXISTING FLOOR SLABS, AS SHOWN ON THE BUILDING ELEVATIONS AND SECTIONS ARE APPROXIMATE.
16. FLOOR LEVELS AND BOUNDARIES ASSUMED WHERE NOTED, DEPICTED BY LINE DASH LINES.
17. REFER TO ARCHITECTURAL, STRUCTURAL, MECHANICAL, ELECTRICAL, GENERAL SPECIFICATION AND OTHER CATEGORIES OR DRAWINGS FOR ADDITIONAL NOTES.
18. VERIFY SIZE/LOCATION/FINISH/FIRE-RATING, ETC. AND PROVIDE COMPLETE AND REQUIRED OPENINGS THROUGH FLOORS AND WALLS, ACCESS DOORS, FURRING, CURBS, ANCHORS & INSERTS.
19. CONTRACTOR TO CARRY OUT MOST LOGICAL SOLUTION BUT TO CHECK WITH ARCHITECT OR ENGINEER IF UNSURE. REQUESTS BY CLIENTS THAT DEVIATE FROM DESIGN VOIDS THE DESIGN LIABILITY.
20. SEE STRUCTURAL GENERAL NOTES AND PLANS TO COMPLEMENT ARCHITECTURAL PLANS AT ALL TIMES, DO NOT ASSUME ANYTHING.
21. STAIR LAYOUTS AND DESIGNS ARE INDICATIVE SIZE AND POSITION FOR BUILDING CONTROL APPROVAL, NOT TO BE USED AS CONSTRUCTION DRAWINGS. FINAL STAIR SPECIFICATIONS TBC FROM STAIR SUPPLIER.
22. ALL DIMENSIONS ARE INDICATIVE AND TO BE CONFIRMED ON SITE BY CONTRACTOR.
23. THIS DRAWING SET IS FOR PLANNING OR BUILDING CONTROL APPROVAL AND NOT TO BE USED AS FINAL CONSTRUCTION DRAWINGS, UNLESS STATED OTHERWISE.

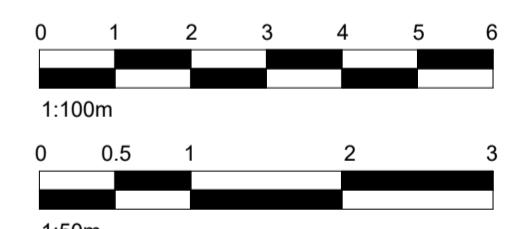


No.:	Revision:	Date:
BISCHELL		
THE DESIGN & BUILD COMPANY		
Bischell - Design & Build -		
Suite 114		
80 Cumberland House, Scrubs Lane		
Hammersmith & Fulham, NW10 6RF		
www.bischell.co.uk		
Client: 20 Seaton Gardens, Ruislip HA4 0AX, UK		
Drawing Title: Existing Plans		
Status: PN		
Scale: 1:50 @A2 Date: 13/03/2024 Drawn By: SR		
Drawing No.: PN-004 Rev:		

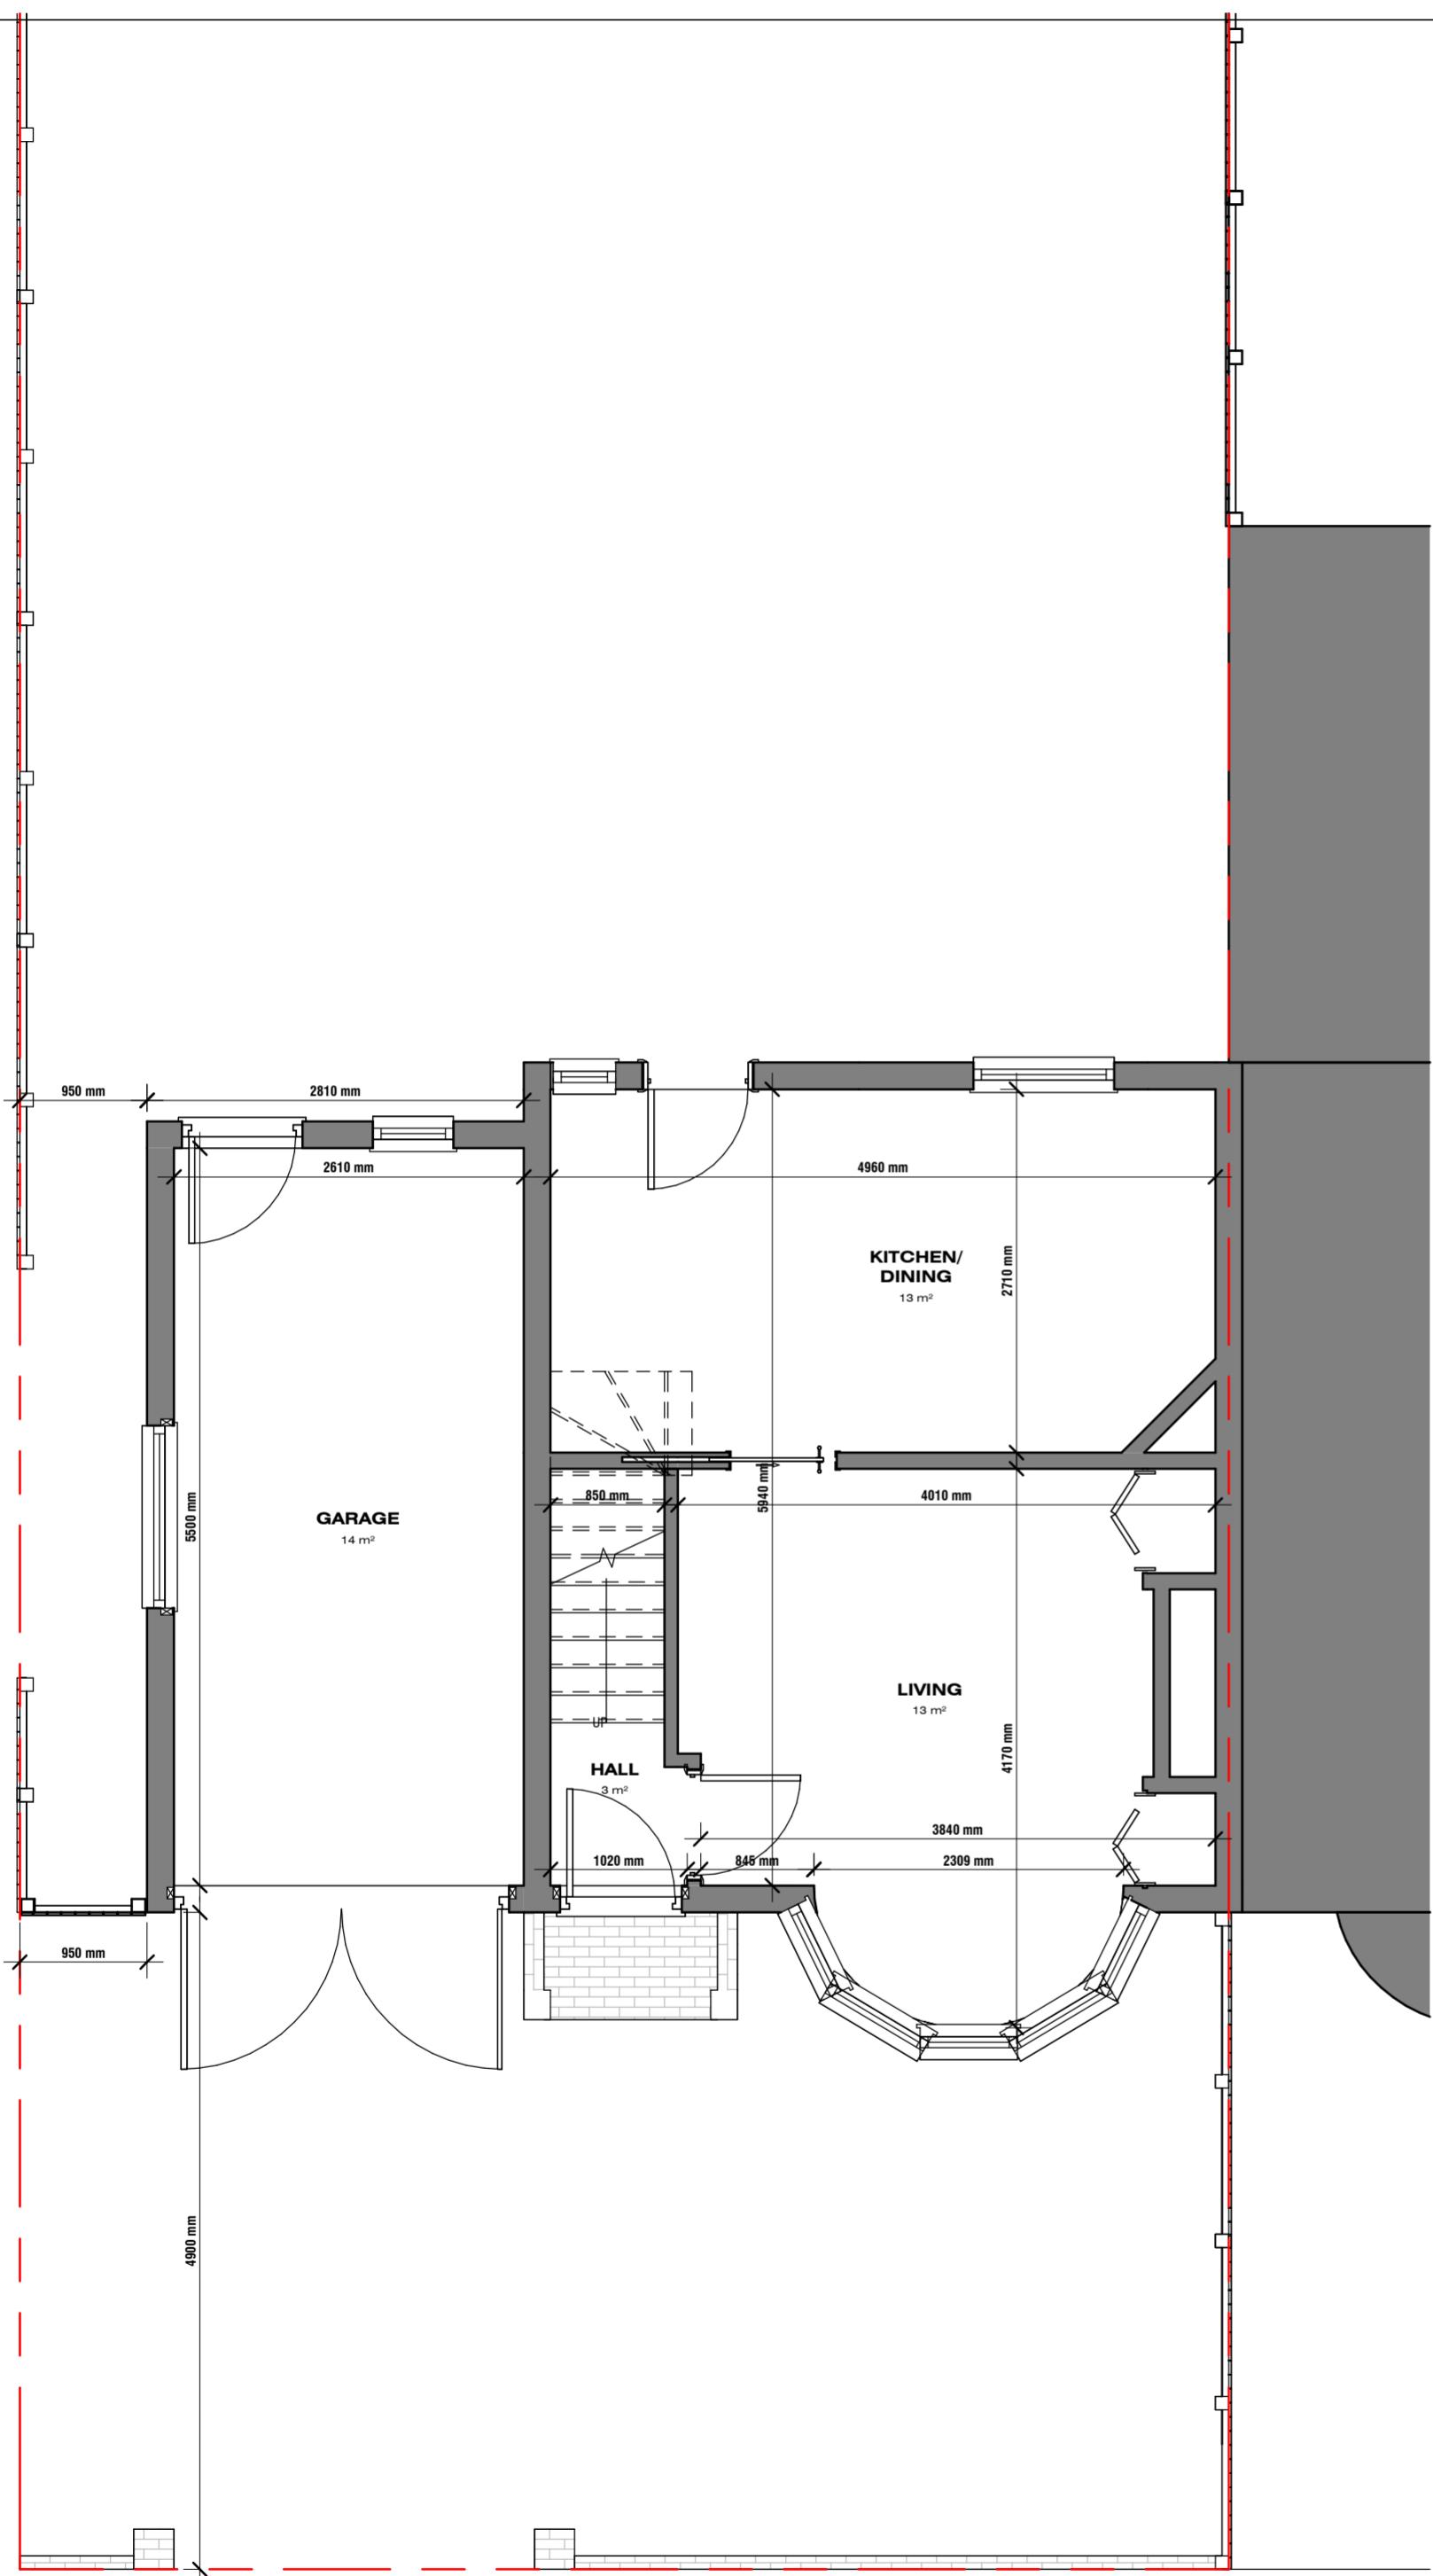

1 Ground Floor Plan - Existing

1 : 50

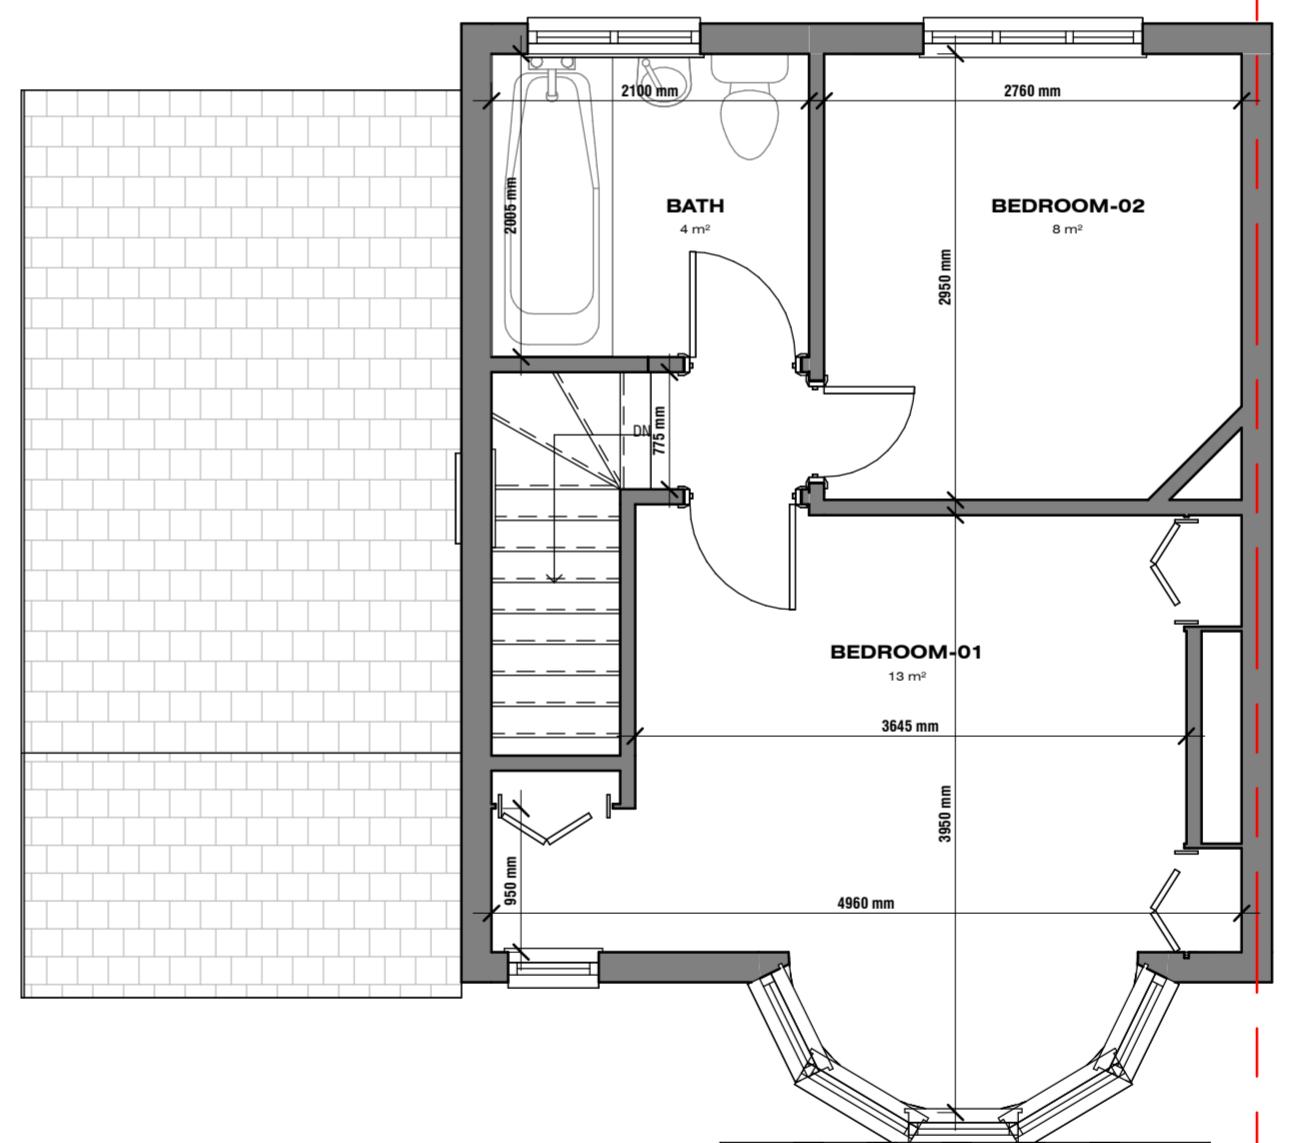

2 First Floor Plan - Existing

1 : 50

GENERAL NOTES

1. CHECK ALL DIMENSIONS ON SITE.
2. ALL DIMENSIONS ARE IN MILLIMETRES UNLESS OTHERWISE STATED.
3. ALL VERTICAL MEASUREMENTS ASSUME GROUND TO BE LEVEL UNLESS OTHERWISE STATED.
4. THIS DRAWING SHOULD BE READ IN CONJUNCTION WITH THE GENERAL NOTES.
5. WORKS TO BE CARRIED OUT WITH MATERIALS AND WORKMANSHIP IN COMPLIANCE WITH APPROVED DOCUMENT FOR REGULATION 7 (THE AMENDED BUILDING REGULATIONS 2013)
6. WORKS TO BE CARRIED OUT IN A SAFE MANNER IN ACCORDANCE WITH CDM REGULATIONS 2015.
7. OPEN UP EXISTING STRUCTURE AS REQUIRED BY THE BUILDING INSPECTOR
8. THIRD PARTY SUPPLIER TO MEASURE ON SITE BEFORE MANUFACTURING
9. GENERAL CONTRACTOR TO VERIFY FIELD CONDITIONS PRIOR TO COMMENCEMENT OF EACH PORTION OF THE WORK.
10. ANY DISCREPANCIES IN THESE DRAWINGS SHOULD BE NOTIFIED TO US PRIOR TO ANY WORKS PROCEEDING.
11. UNLESS OTHERWISE INDICATED, PLAN DIMENSIONS ARE TO COLUMN GRID ON CENTERLINES, NOMINAL SURFACE OF MASONRY, FACE OF STUDS AND FACE OF CONCRETE WALLS AND BEAM CENTRE TO CENTRES.
12. "FLOOR LINE" REFERS TO TOP OF CONCRETE SLABS, FINISH FLOORING IS INSTALLED ABOVE THE FLOOR LINE. FOR DEPRESSED FLOORS AND CURBS, SEE STRUCTURAL DRAWINGS.
13. REPETITIVE FEATURES ARE NOT ALWAYS DRAWN IN THEIR ENTIRETY AND SHALL BE COMPLETELY PROVIDED AS IF DRAWN IN FULL.

14. WHERE A DOOR IS LOCATED NEAR CORNER OF ROOM AND IS NOT LOCATED BY DIMENSION ON PLAN OR DETAILS, DIMENSION SHALL BE 100MM FROM FACE OF STUD (WALL).

15. LINE OF EXISTING FLOOR SLABS, AS SHOWN ON THE BUILDING ELEVATIONS AND SECTIONS ARE APPROXIMATE.

16. FLOOR LEVELS AND BOUNDARIES ASSUMED WHERE NOTED, DEPICTED BY LINE DASH LINES.

17. REFER TO ARCHITECTURAL, STRUCTURAL, MECHANICAL, ELECTRICAL, GENERAL SPECIFICATION AND OTHER CATEGORIES OR DRAWINGS FOR ADDITIONAL NOTES.

18. VERIFY SIZE/LOCATION/FINISH/FIRE-RATING, ETC. AND PROVIDE COMPLETE AND REQUIRED OPENINGS THROUGH FLOORS AND WALLS, ACCESS DOORS, FURRING, CURBS, ANCHORS & INSERTS.

19. CONTRACTOR TO CARRY OUT MOST LOGICAL SOLUTION BUT TO CHECK WITH ARCHITECT OR ENGINEER IF UNSURE, REQUESTS BY CLIENTS THAT DEVIATE FROM DESIGN VOIDS THE DESIGN LIABILITY.

20. SEE STRUCTURAL GENERAL NOTES AND PLANS TO COMPLEMENT ARCHITECTURAL PLANS AT ALL TIMES, DO NOT ASSUME ANYTHING.

21. STAIR LAYOUTS AND DESIGNS ARE INDICATIVE SIZE AND POSITION FOR BUILDING CONTROL APPROVAL, NOT TO BE USED AS CONSTRUCTION DRAWINGS. FINAL STAIR SPECIFICATIONS TBC FROM STAIR SUPPLIER.

22. ALL DIMENSIONS ARE INDICATIVE AND TO BE CONFIRMED ON SITE BY CONTRACTOR.

23. THIS DRAWING SET IS FOR PLANNING OR BUILDING CONTROL APPROVAL AND NOT TO BE USED AS FINAL CONSTRUCTION DRAWINGS, UNLESS STATED OTHERWISE.



No.: Revision: Date:

BISCHELL
THE DESIGN & BUILD COMPANY

Bischell - Design & Build -
Suite 114
80 Cumberland House, Scrubs Lane
Hammersmith & Fulham, NW10 6RF
www.bischell.co.uk

Client: 20 Seaton Gardens, Ruislip HA4 0AX, UK



Drawing Title: Existing Plans

Status: PN

Scale: 1:50 @A2 Date: 13/03/2024 Drawn By: SR

Drawing No.: PN-005 Rev:

15/03/2024 09:57:54

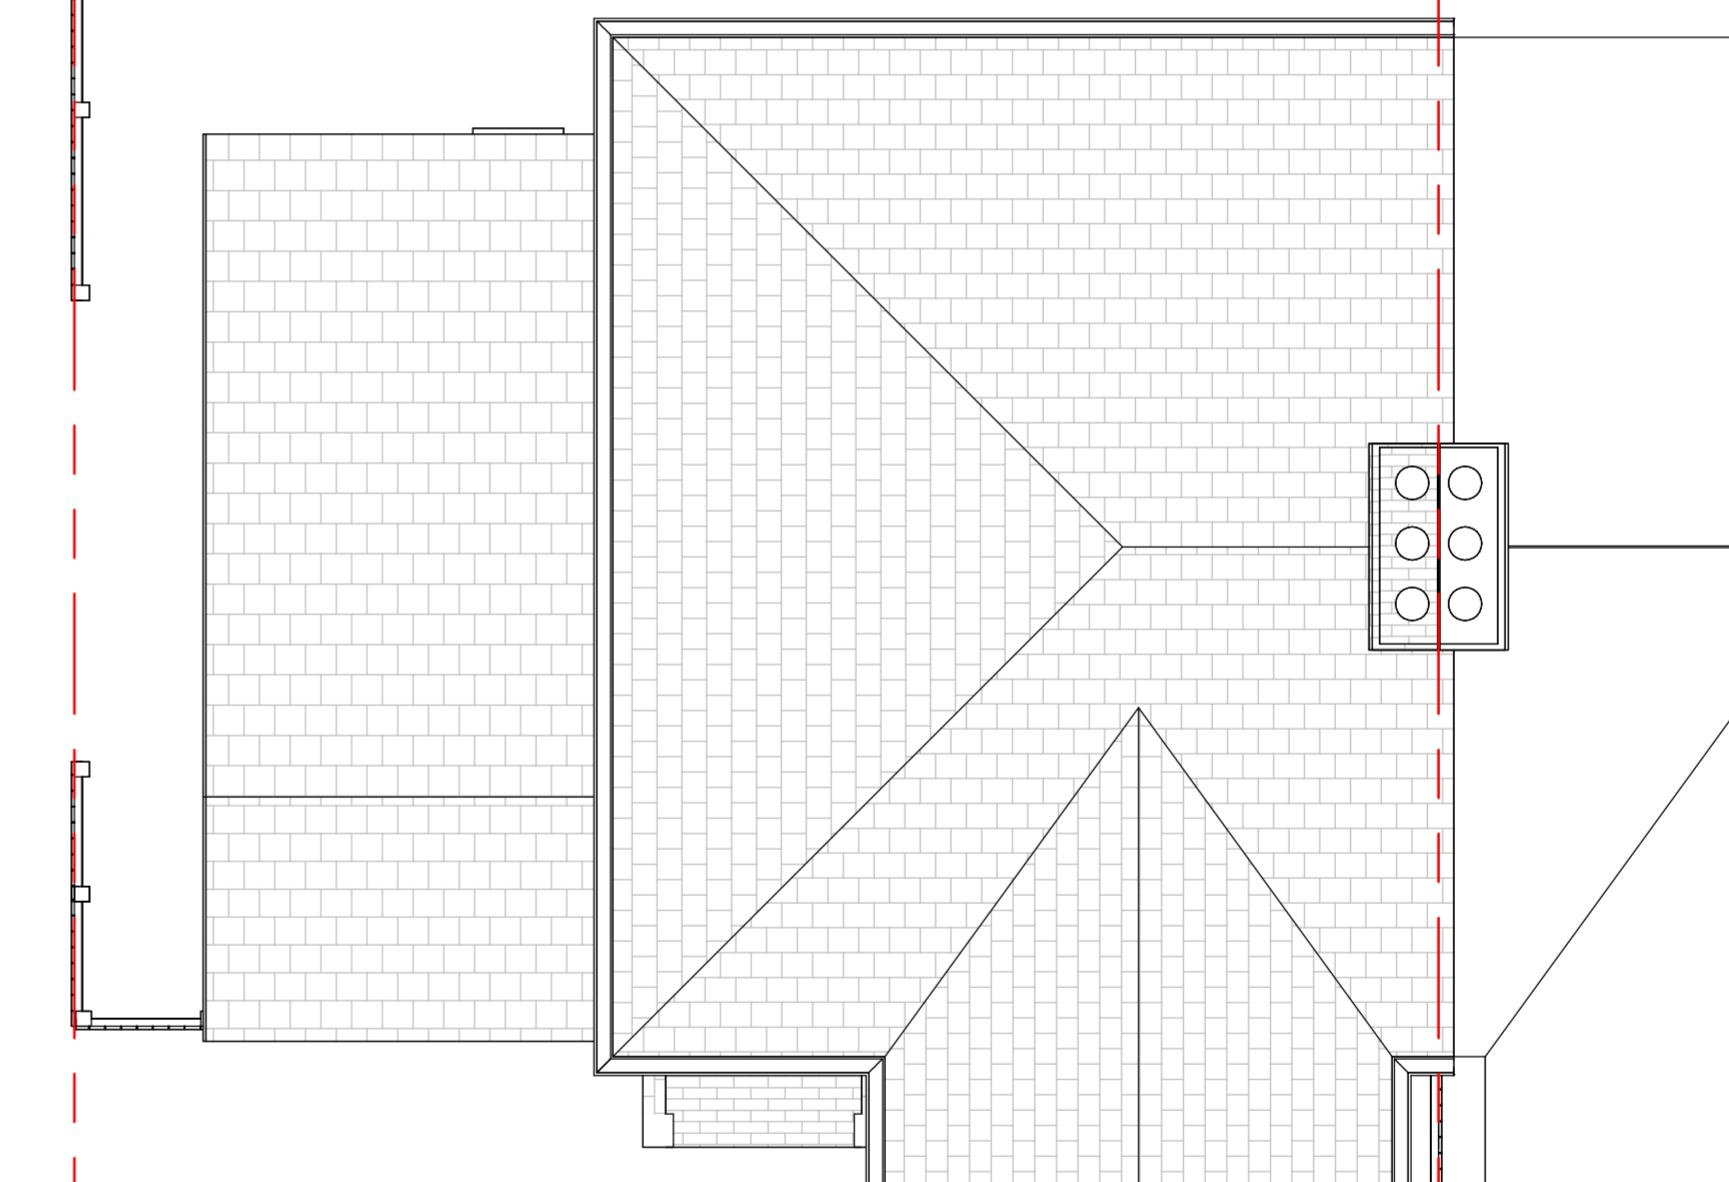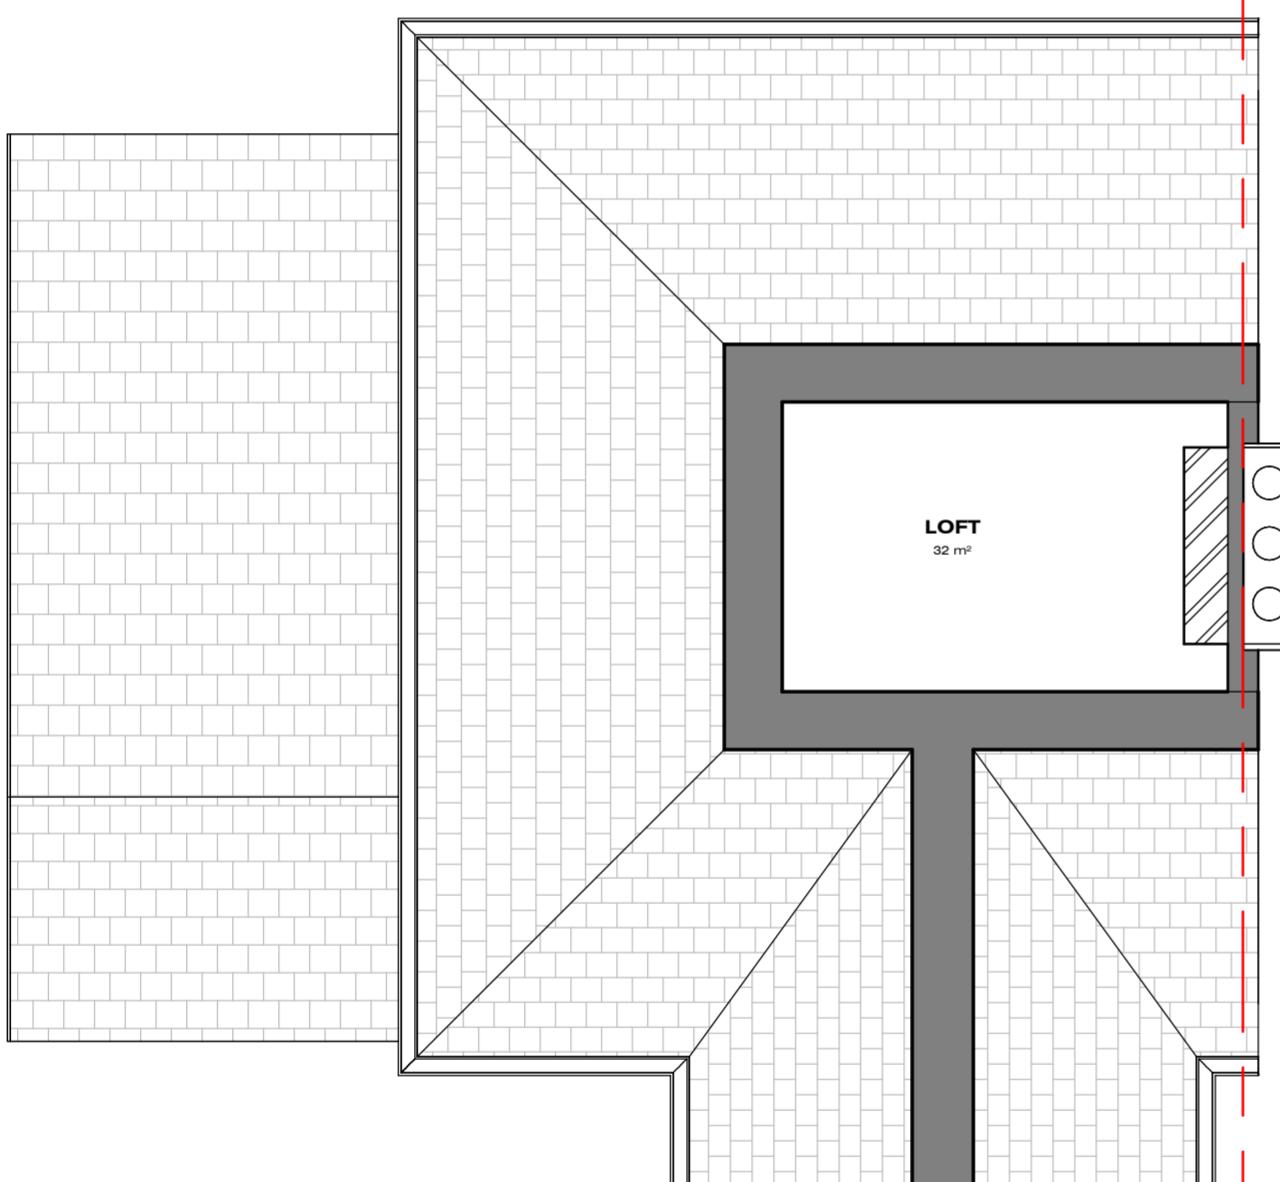

2 Roof Plan - Existing

1 : 50


1 Second Floor Plan - Existing

1 : 50


GENERAL NOTES

1. CHECK ALL DIMENSIONS ON SITE.
2. ALL DIMENSIONS ARE IN MILLIMETRES UNLESS OTHERWISE STATED.
3. ALL VERTICAL MEASUREMENTS ASSUME GROUND TO BE LEVEL UNLESS OTHERWISE STATED.
4. THIS DRAWING SHOULD BE READ IN CONJUNCTION WITH THE GENERAL NOTES.
5. WORKS TO BE CARRIED OUT WITH MATERIALS AND WORKMANSHIP IN COMPLIANCE WITH APPROVED DOCUMENT FOR REGULATION 7 (THE AMENDED BUILDING REGULATIONS 2013)
6. WORKS TO BE CARRIED OUT IN A SAFE MANNER IN ACCORDANCE WITH CDM REGULATIONS 2015.
7. OPEN UP EXISTING STRUCTURE AS REQUIRED BY THE BUILDING INSPECTOR
8. THIRD PARTY SUPPLIER TO MEASURE ON SITE BEFORE MANUFACTURING
9. GENERAL CONTRACTOR TO VERIFY FIELD CONDITIONS PRIOR TO COMMENCEMENT OF EACH PORTION OF THE WORK.
10. ANY DISCREPANCIES IN THESE DRAWINGS SHOULD BE NOTIFIED TO US PRIOR TO ANY WORKS PROCEEDING.
11. UNLESS OTHERWISE INDICATED, PLAN DIMENSIONS ARE TO COLUMN GRID ON CENTERLINES, NOMINAL SURFACE OF MASONRY, FACE OF STUDS AND FACE OF CONCRETE WALLS AND BEAM CENTRE TO CENTRES.
12. "FLOOR LINE" REFERS TO TOP OF CONCRETE SLABS, FINISH FLOORING IS INSTALLED ABOVE THE FLOOR LINE. FOR DEPRESSED FLOORS AND CURBS, SEE STRUCTURAL DRAWINGS.
13. REPETITIVE FEATURES ARE NOT ALWAYS DRAWN IN THEIR ENTIRETY AND SHALL BE COMPLETELY PROVIDED AS IF DRAWN IN FULL.
14. WHERE A DOOR IS LOCATED NEAR CORNER OF ROOM AND IS NOT LOCATED BY DIMENSION ON PLAN OR DETAILS, DIMENSION SHALL BE 100MM FROM FACE OF STUD (WALL).
15. LINE OF EXISTING FLOOR SLABS, AS SHOWN ON THE BUILDING ELEVATIONS AND SECTIONS ARE APPROXIMATE.
16. FLOOR LEVELS AND BOUNDARIES ASSUMED WHERE NOTED, DEPICTED BY LINE DASH LINES.
17. REFER TO ARCHITECTURAL, STRUCTURAL, MECHANICAL, ELECTRICAL, GENERAL SPECIFICATION AND OTHER CATEGORIES OR DRAWINGS FOR ADDITIONAL NOTES.

18. VERIFY SIZE/LOCATION/FINISH/FIRE-RATING, ETC. AND PROVIDE COMPLETE AND REQUIRED OPENINGS THROUGH FLOORS AND WALLS, ACCESS DOORS, FUHRING, CURBS, ANCHORS & INSERTS.
19. CONTRACTOR TO CARRY OUT MOST LOGICAL SOLUTION BUT TO CHECK WITH ARCHITECT OR ENGINEER IF UNSURE, REQUESTS BY CLIENTS THAT DEVIATE FROM DESIGN VOIDS THE DESIGN LIABILITY.
20. SEE STRUCTURAL GENERAL NOTES AND PLANS TO COMPLEMENT ARCHITECTURAL PLANS AT ALL TIMES, DO NOT ASSUME ANYTHING.
21. STAIR LAYOUTS AND DESIGNS ARE INDICATIVE SIZE AND POSITION FOR BUILDING CONTROL APPROVAL, NOT TO BE USED AS CONSTRUCTION DRAWINGS. FINAL STAIR SPECIFICATIONS TBC FROM STAIR SUPPLIER.
22. ALL DIMENSIONS ARE INDICATIVE AND TO BE CONFIRMED ON SITE BY CONTRACTOR.
23. THIS DRAWING SET IS FOR PLANNING OR BUILDING CONTROL APPROVAL AND NOT TO BE USED AS FINAL CONSTRUCTION DRAWINGS, UNLESS STATED OTHERWISE.

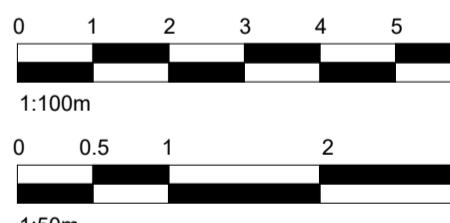


No.:	Revision:	Date:
BISCHELL THE DESIGN & BUILD COMPANY		
Bischell - Design & Build - Suite 114 80 Cumberland House, Scrubs Lane Hammersmith & Fulham, NW10 6RF www.bischell.co.uk		
Client: 20 Seaton Gardens, Ruislip HA4 0AX, UK		
Drawing Title: Existing Elevations		
Status: PN		
Scale: 1:50 @A2 Date: 13/03/2024 Drawn By: SR		
Drawing No.: PN-006 Rev:		

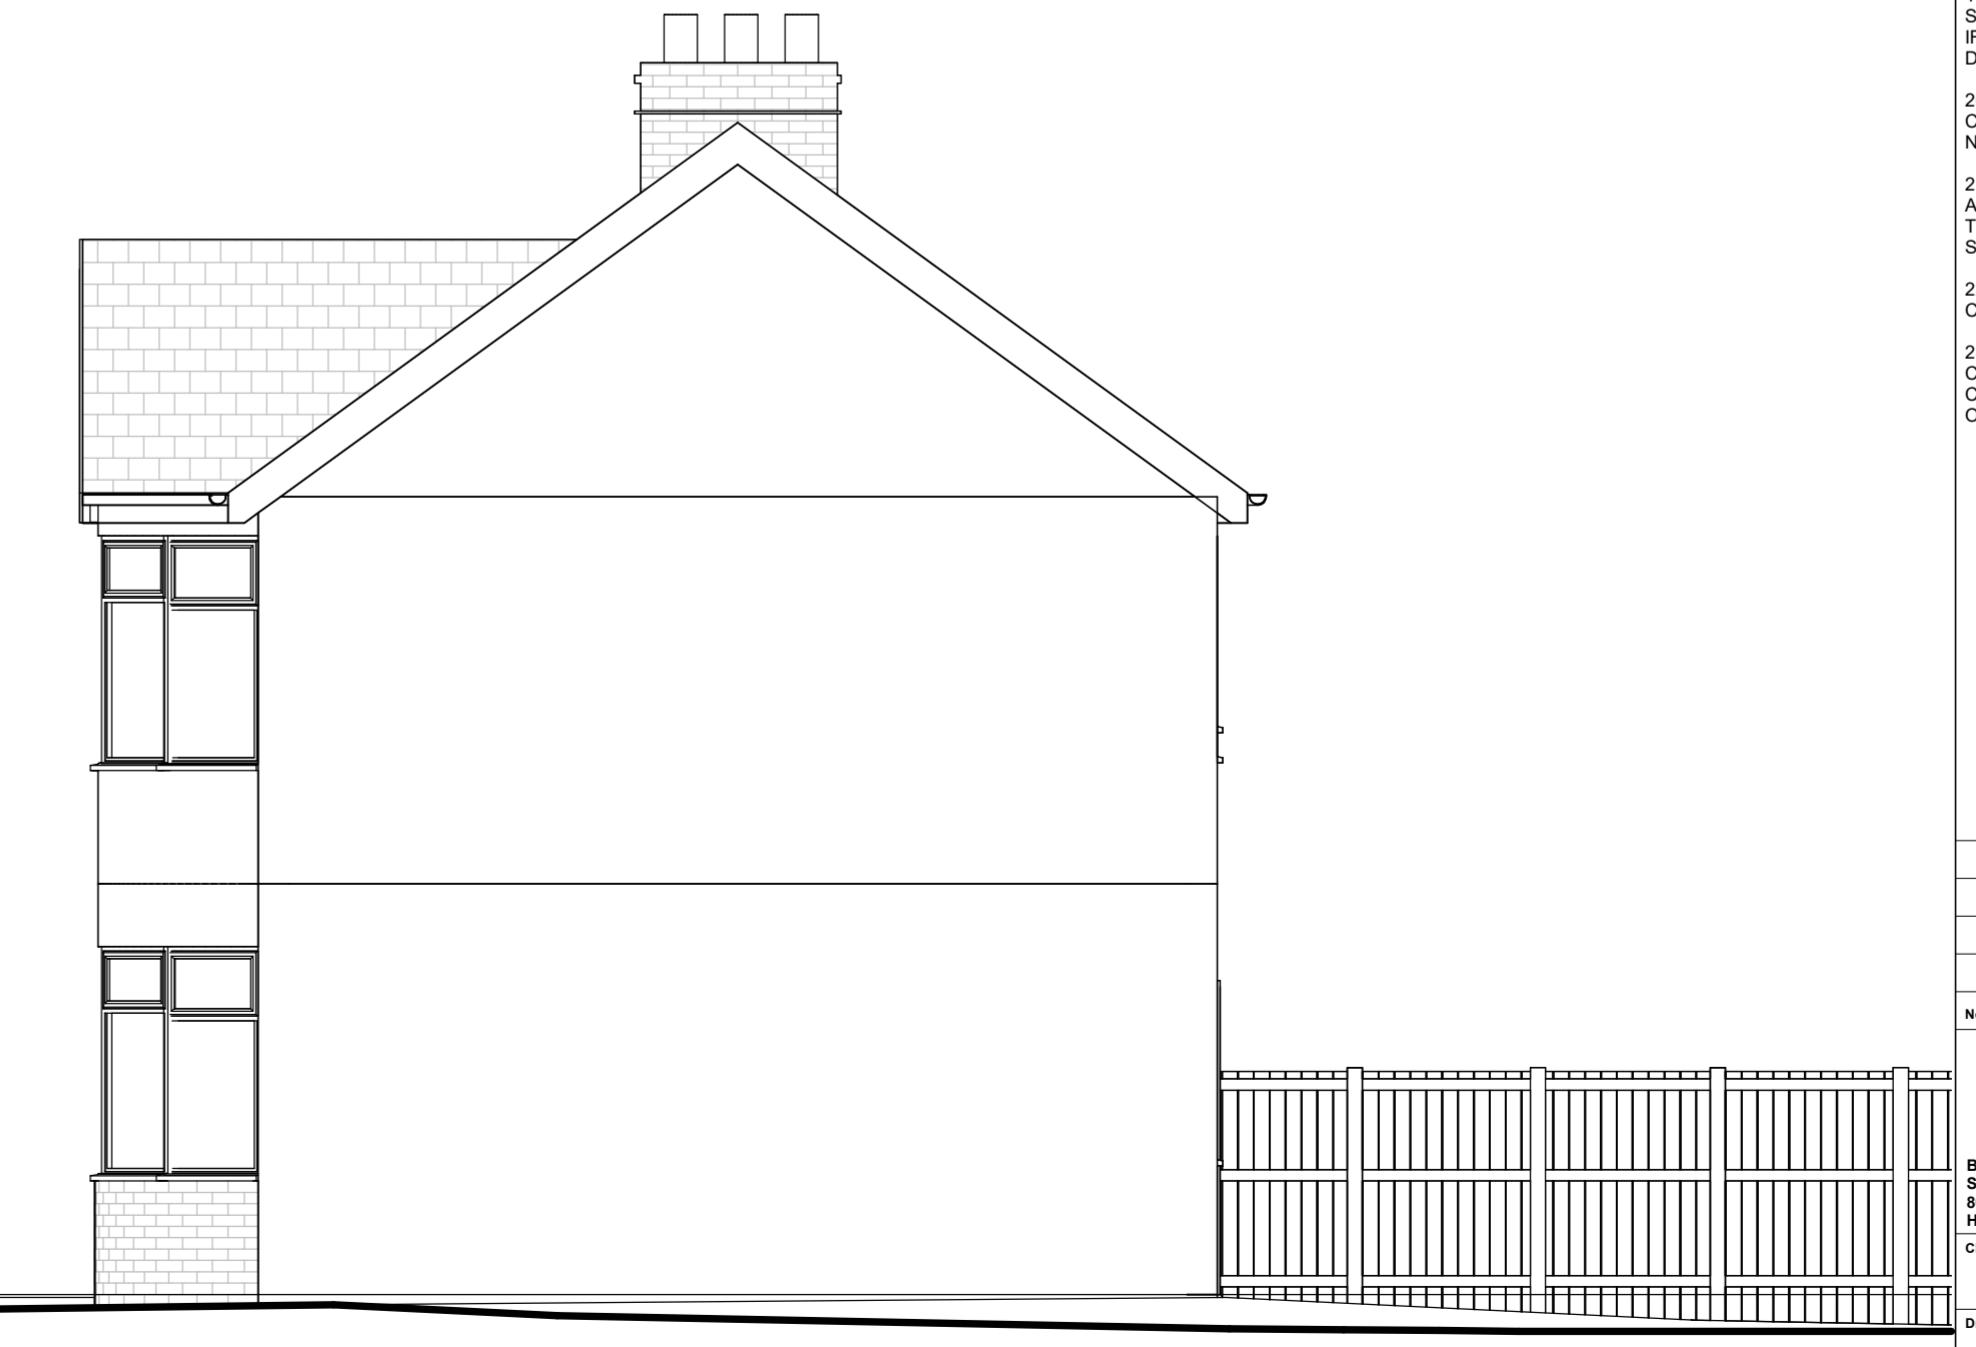


GENERAL NOTES


- CHECK ALL DIMENSIONS ON SITE.
- ALL DIMENSIONS ARE IN MILLIMETRES UNLESS OTHERWISE STATED.
- ALL VERTICAL MEASUREMENTS ASSUME GROUND TO BE LEVEL UNLESS OTHERWISE STATED.
- THIS DRAWING SHOULD BE READ IN CONJUNCTION WITH THE GENERAL NOTES.
- WORKS TO BE CARRIED OUT WITH MATERIALS AND WORKMANSHIP IN COMPLIANCE WITH APPROVED DOCUMENT FOR REGULATION 7 (THE AMENDED BUILDING REGULATIONS 2013)
- WORKS TO BE CARRIED OUT IN A SAFE MANNER IN ACCORDANCE WITH CDM REGULATIONS 2015.
- OPEN UP EXISTING STRUCTURE AS REQUIRED BY THE BUILDING INSPECTOR
- THIRD PARTY SUPPLIER TO MEASURE ON SITE BEFORE MANUFACTURING
- GENERAL CONTRACTOR TO VERIFY FIELD CONDITIONS PRIOR TO COMMENCEMENT OF EACH PORTION OF THE WORK.
- ANY DISCREPANCIES IN THESE DRAWINGS SHOULD BE NOTIFIED TO US PRIOR TO ANY WORKS PROCEEDING.
- UNLESS OTHERWISE INDICATED, PLAN DIMENSIONS ARE TO COLUMN GRID ON CENTERLINES, NOMINAL SURFACE OF MASONRY, FACE OF STUDS AND FACE OF CONCRETE WALLS AND BEAM CENTRE TO CENTRES.
- "FLOOR LINE" REFERS TO TOP OF CONCRETE SLABS, FINISH FLOORING IS INSTALLED ABOVE THE FLOOR LINE. FOR DEPRESSED FLOORS AND CURBS, SEE STRUCTURAL DRAWINGS.
- REPETITIVE FEATURES ARE NOT ALWAYS DRAWN IN THEIR ENTIRETY AND SHALL BE COMPLETELY PROVIDED AS IF DRAWN IN FULL.
- WHERE A DOOR IS LOCATED NEAR CORNER OF ROOM AND IS NOT LOCATED BY DIMENSION ON PLAN OR DETAILS, DIMENSION SHALL BE 100MM FROM FACE OF STUD (WALL).
- LINE OF EXISTING FLOOR SLABS, AS SHOWN ON THE BUILDING ELEVATIONS AND SECTIONS ARE APPROXIMATE.
- FLOOR LEVELS AND BOUNDARIES ASSUMED WHERE NOTED, DEPICTED BY LINE DASH LINES.
- REFER TO ARCHITECTURAL, STRUCTURAL, MECHANICAL, ELECTRICAL, GENERAL SPECIFICATION AND OTHER CATEGORIES OR DRAWINGS FOR ADDITIONAL NOTES.
- VERIFY SIZE/LOCATION/FINISH/FIRE-RATING, ETC. AND PROVIDE COMPLETE AND REQUIRED OPENINGS THROUGH FLOORS AND WALLS, ACCESS DOORS, FURRING, CURBS, ANCHORS & INSERTS.
- CONTRACTOR TO CARRY OUT MOST LOGICAL SOLUTION BUT TO CHECK WITH ARCHITECT OR ENGINEER IF UNSURE. REQUESTS BY CLIENTS THAT DEVIATE FROM DESIGN VOIDS THE DESIGN LIABILITY.
- SEE STRUCTURAL GENERAL NOTES AND PLANS TO COMPLEMENT ARCHITECTURAL PLANS AT ALL TIMES, DO NOT ASSUME ANYTHING.
- STAIR LAYOUTS AND DESIGNS ARE INDICATIVE SIZE AND POSITION FOR BUILDING CONTROL APPROVAL, NOT TO BE USED AS CONSTRUCTION DRAWINGS. FINAL STAIR SPECIFICATIONS TBC FROM STAIR SUPPLIER.
- ALL DIMENSIONS ARE INDICATIVE AND TO BE CONFIRMED ON SITE BY CONTRACTOR.
- THIS DRAWING SET IS FOR PLANNING OR BUILDING CONTROL APPROVAL AND NOT TO BE USED AS FINAL CONSTRUCTION DRAWINGS, UNLESS STATED OTHERWISE.

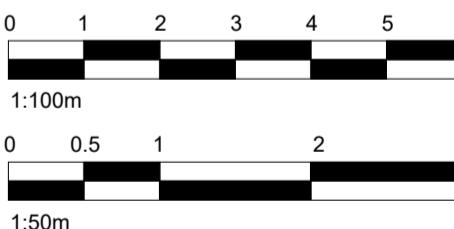

No.:	Revision:	Date:
BISCHELL THE DESIGN & BUILD COMPANY		
Bischell - Design & Build - Suite 114 80 Cumberland House, Scrubs Lane Hammersmith & Fulham, NW10 6RF		
www.bischell.co.uk		
Client: 20 Seaton Gardens, Ruislip HA4 0AX, UK		
Drawing Title: Proposed Plans		
Status: PN		
Scale: 1:50 @A2 Date: 13/03/2024 Drawn By: SR		
Drawing No.: PN-007 Rev:		

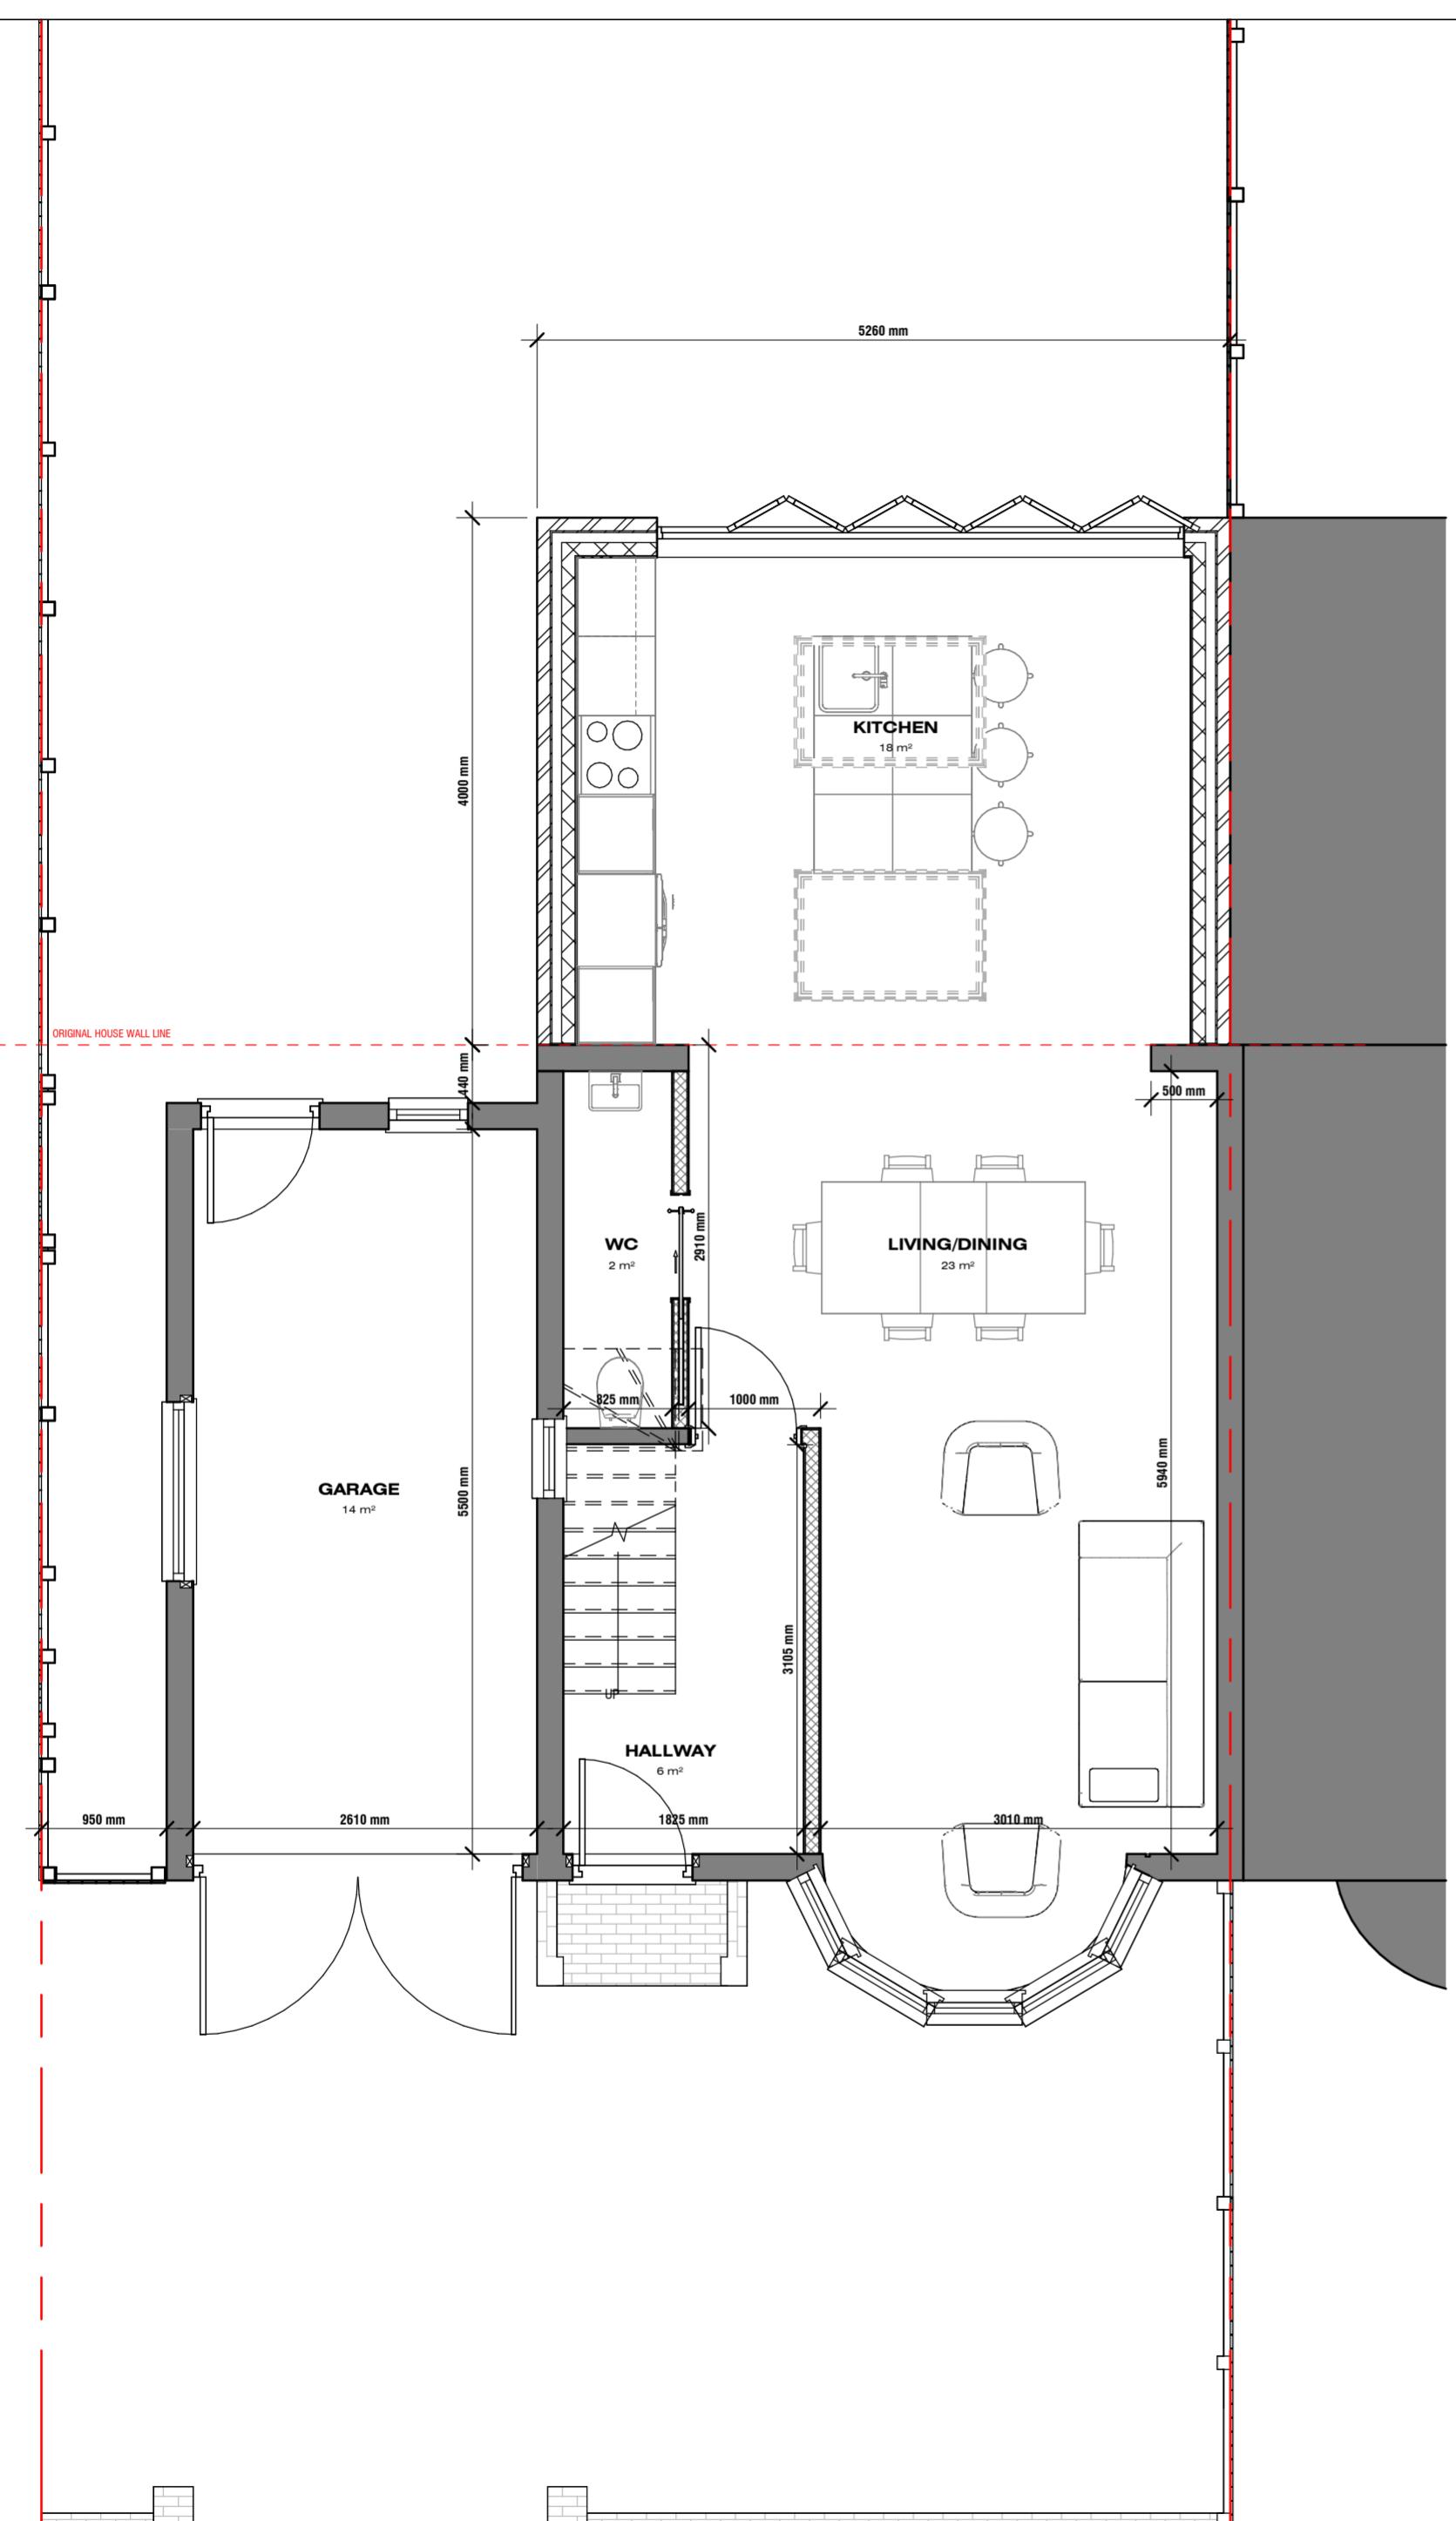

1 Ground Floor Plan - Proposed
1 : 50

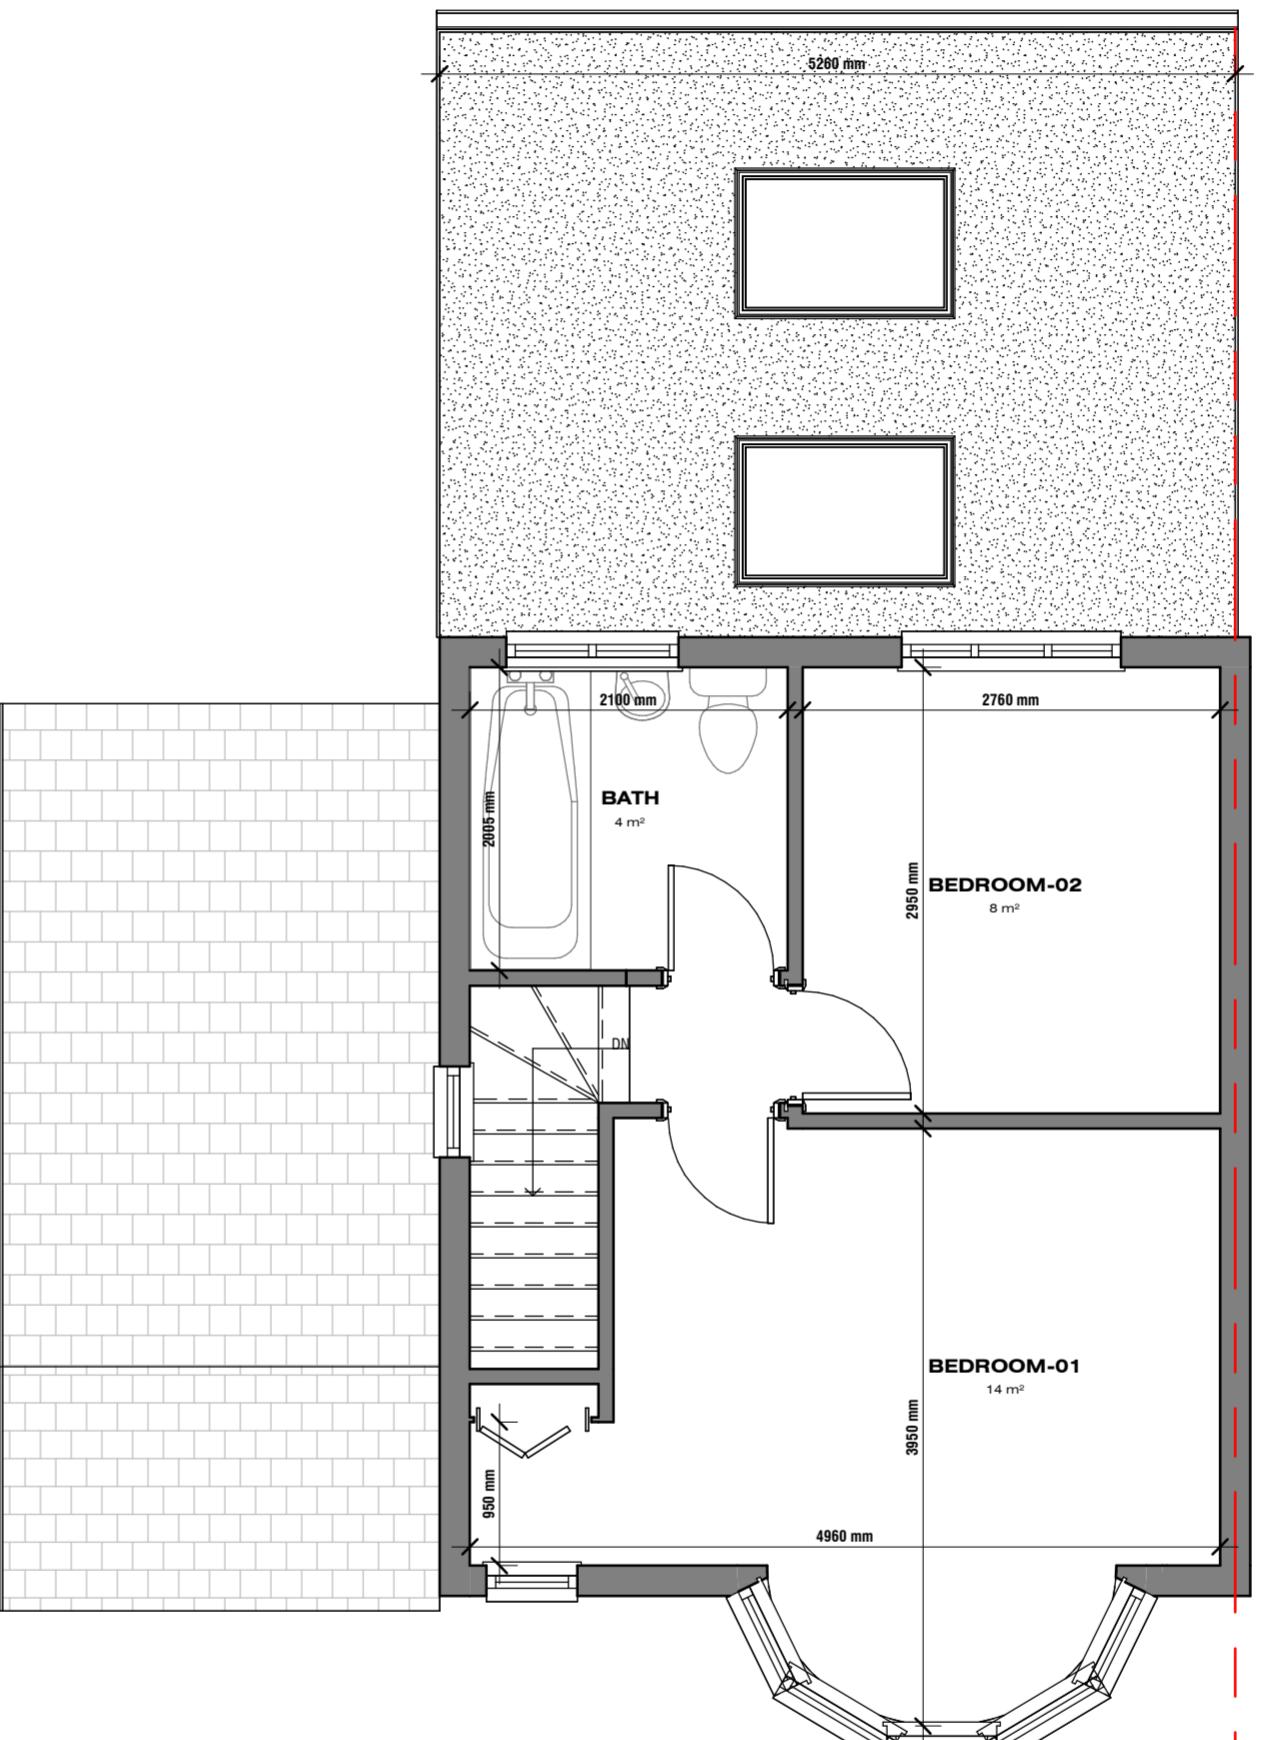

2 First Floor Plan - Proposed
1 : 50

GENERAL NOTES

1. CHECK ALL DIMENSIONS ON SITE.
2. ALL DIMENSIONS ARE IN MILLIMETRES UNLESS OTHERWISE STATED.
3. ALL VERTICAL MEASUREMENTS ASSUME GROUND TO BE LEVEL UNLESS OTHERWISE STATED.
4. THIS DRAWING SHOULD BE READ IN CONJUNCTION WITH THE GENERAL NOTES.
5. WORKS TO BE CARRIED OUT WITH MATERIALS AND WORKMANSHIP IN COMPLIANCE WITH APPROVED DOCUMENT FOR REGULATION 7 (THE AMENDED BUILDING REGULATIONS 2013)
6. WORKS TO BE CARRIED OUT IN A SAFE MANNER IN ACCORDANCE WITH CDM REGULATIONS 2015.
7. OPEN UP EXISTING STRUCTURE AS REQUIRED BY THE BUILDING INSPECTOR
8. THIRD PARTY SUPPLIER TO MEASURE ON SITE BEFORE MANUFACTURING
9. GENERAL CONTRACTOR TO VERIFY FIELD CONDITIONS PRIOR TO COMMENCEMENT OF EACH PORTION OF THE WORK.
10. ANY DISCREPANCIES IN THESE DRAWINGS SHOULD BE NOTIFIED TO US PRIOR TO ANY WORKS PROCEEDING.
11. UNLESS OTHERWISE INDICATED, PLAN DIMENSIONS ARE TO COLUMN GRID ON CENTERLINES, NOMINAL SURFACE OF MASONRY, FACE OF STUDS AND FACE OF CONCRETE WALLS AND BEAM CENTRE TO CENTRES.
12. "FLOOR LINE" REFERS TO TOP OF CONCRETE SLABS, FINISH FLOORING IS INSTALLED ABOVE THE FLOOR LINE. FOR DEPRESSED FLOORS AND CURBS, SEE STRUCTURAL DRAWINGS.
13. REPETITIVE FEATURES ARE NOT ALWAYS DRAWN IN THEIR ENTIRETY AND SHALL BE COMPLETELY PROVIDED AS IF DRAWN IN FULL.
14. WHERE A DOOR IS LOCATED NEAR CORNER OF ROOM AND IS NOT LOCATED BY DIMENSION ON PLAN OR DETAILS, DIMENSION SHALL BE 100MM FROM FACE OF STUD (WALL).
15. LINE OF EXISTING FLOOR SLABS, AS SHOWN ON THE BUILDING ELEVATIONS AND SECTIONS ARE APPROXIMATE.
16. FLOOR LEVELS AND BOUNDARIES ASSUMED WHERE NOTED, DEPICTED BY LINE DASH LINES.
17. REFER TO ARCHITECTURAL, STRUCTURAL, MECHANICAL, ELECTRICAL, GENERAL SPECIFICATION AND OTHER CATEGORIES OR DRAWINGS FOR ADDITIONAL NOTES.
18. VERIFY SIZE/LOCATION/FINISH/FIRE-RATING, ETC. AND PROVIDE COMPLETE AND REQUIRED OPENINGS THROUGH FLOORS AND WALLS, ACCESS DOORS, FURRING, CURBS, ANCHORS & INSERTS.
19. CONTRACTOR TO CARRY OUT MOST LOGICAL SOLUTION BUT TO CHECK WITH ARCHITECT OR ENGINEER IF UNSURE. REQUESTS BY CLIENTS THAT DEVIATE FROM DESIGN VOIDS THE DESIGN LIABILITY.
20. SEE STRUCTURAL GENERAL NOTES AND PLANS TO COMPLEMENT ARCHITECTURAL PLANS AT ALL TIMES, DO NOT ASSUME ANYTHING.
21. STAIR LAYOUTS AND DESIGNS ARE INDICATIVE SIZE AND POSITION FOR BUILDING CONTROL APPROVAL, NOT TO BE USED AS CONSTRUCTION DRAWINGS. FINAL STAIR SPECIFICATIONS TBC FROM STAIR SUPPLIER.
22. ALL DIMENSIONS ARE INDICATIVE AND TO BE CONFIRMED ON SITE BY CONTRACTOR.
23. THIS DRAWING SET IS FOR PLANNING OR BUILDING CONTROL APPROVAL AND NOT TO BE USED AS FINAL CONSTRUCTION DRAWINGS, UNLESS STATED OTHERWISE.



No.: Revision: Date:

BISCHELL
THE DESIGN & BUILD COMPANY

Bischell - Design & Build -
Suite 114
80 Cumberland House, Scrubs Lane
Hammersmith & Fulham, NW10 6RF
www.bischell.co.uk



Client: 20 Seaton Gardens, Ruislip HA4 0AX, UK

Drawing Title: Proposed Plans

Status: PN

Scale: 1:50 @A2 Date: 13/03/2024 Drawn By: SR

Drawing No.: PN-008 Rev:

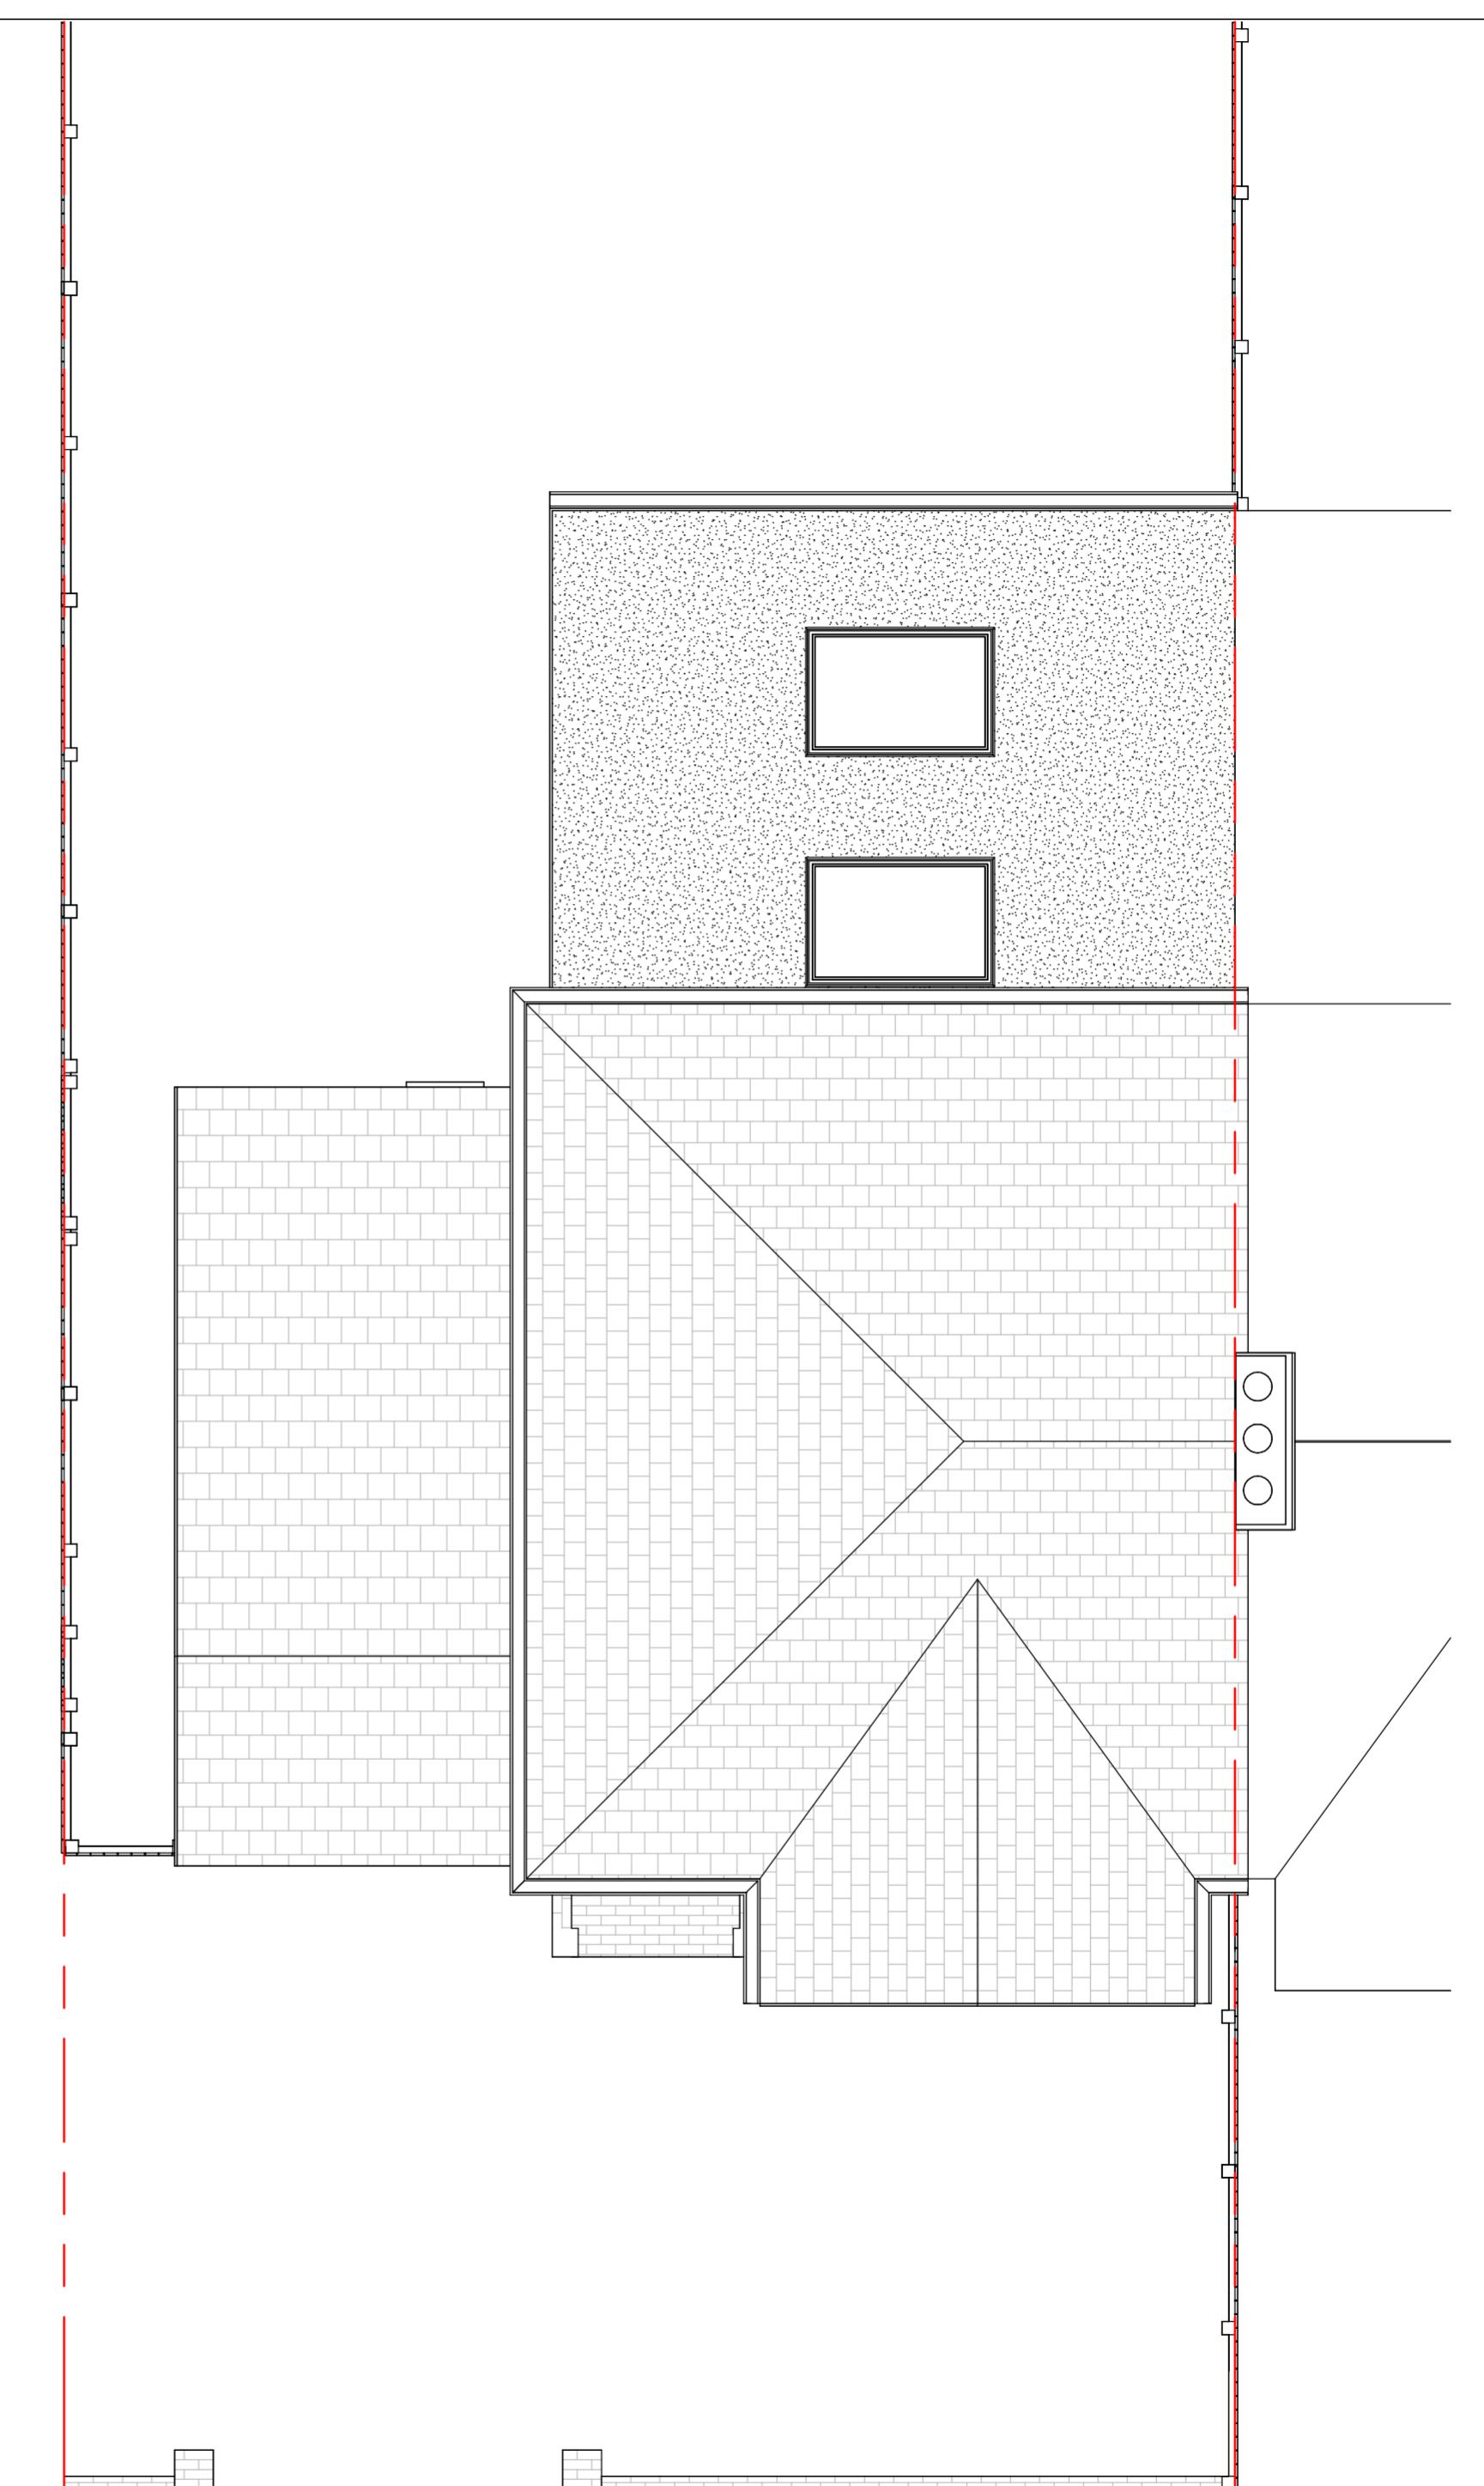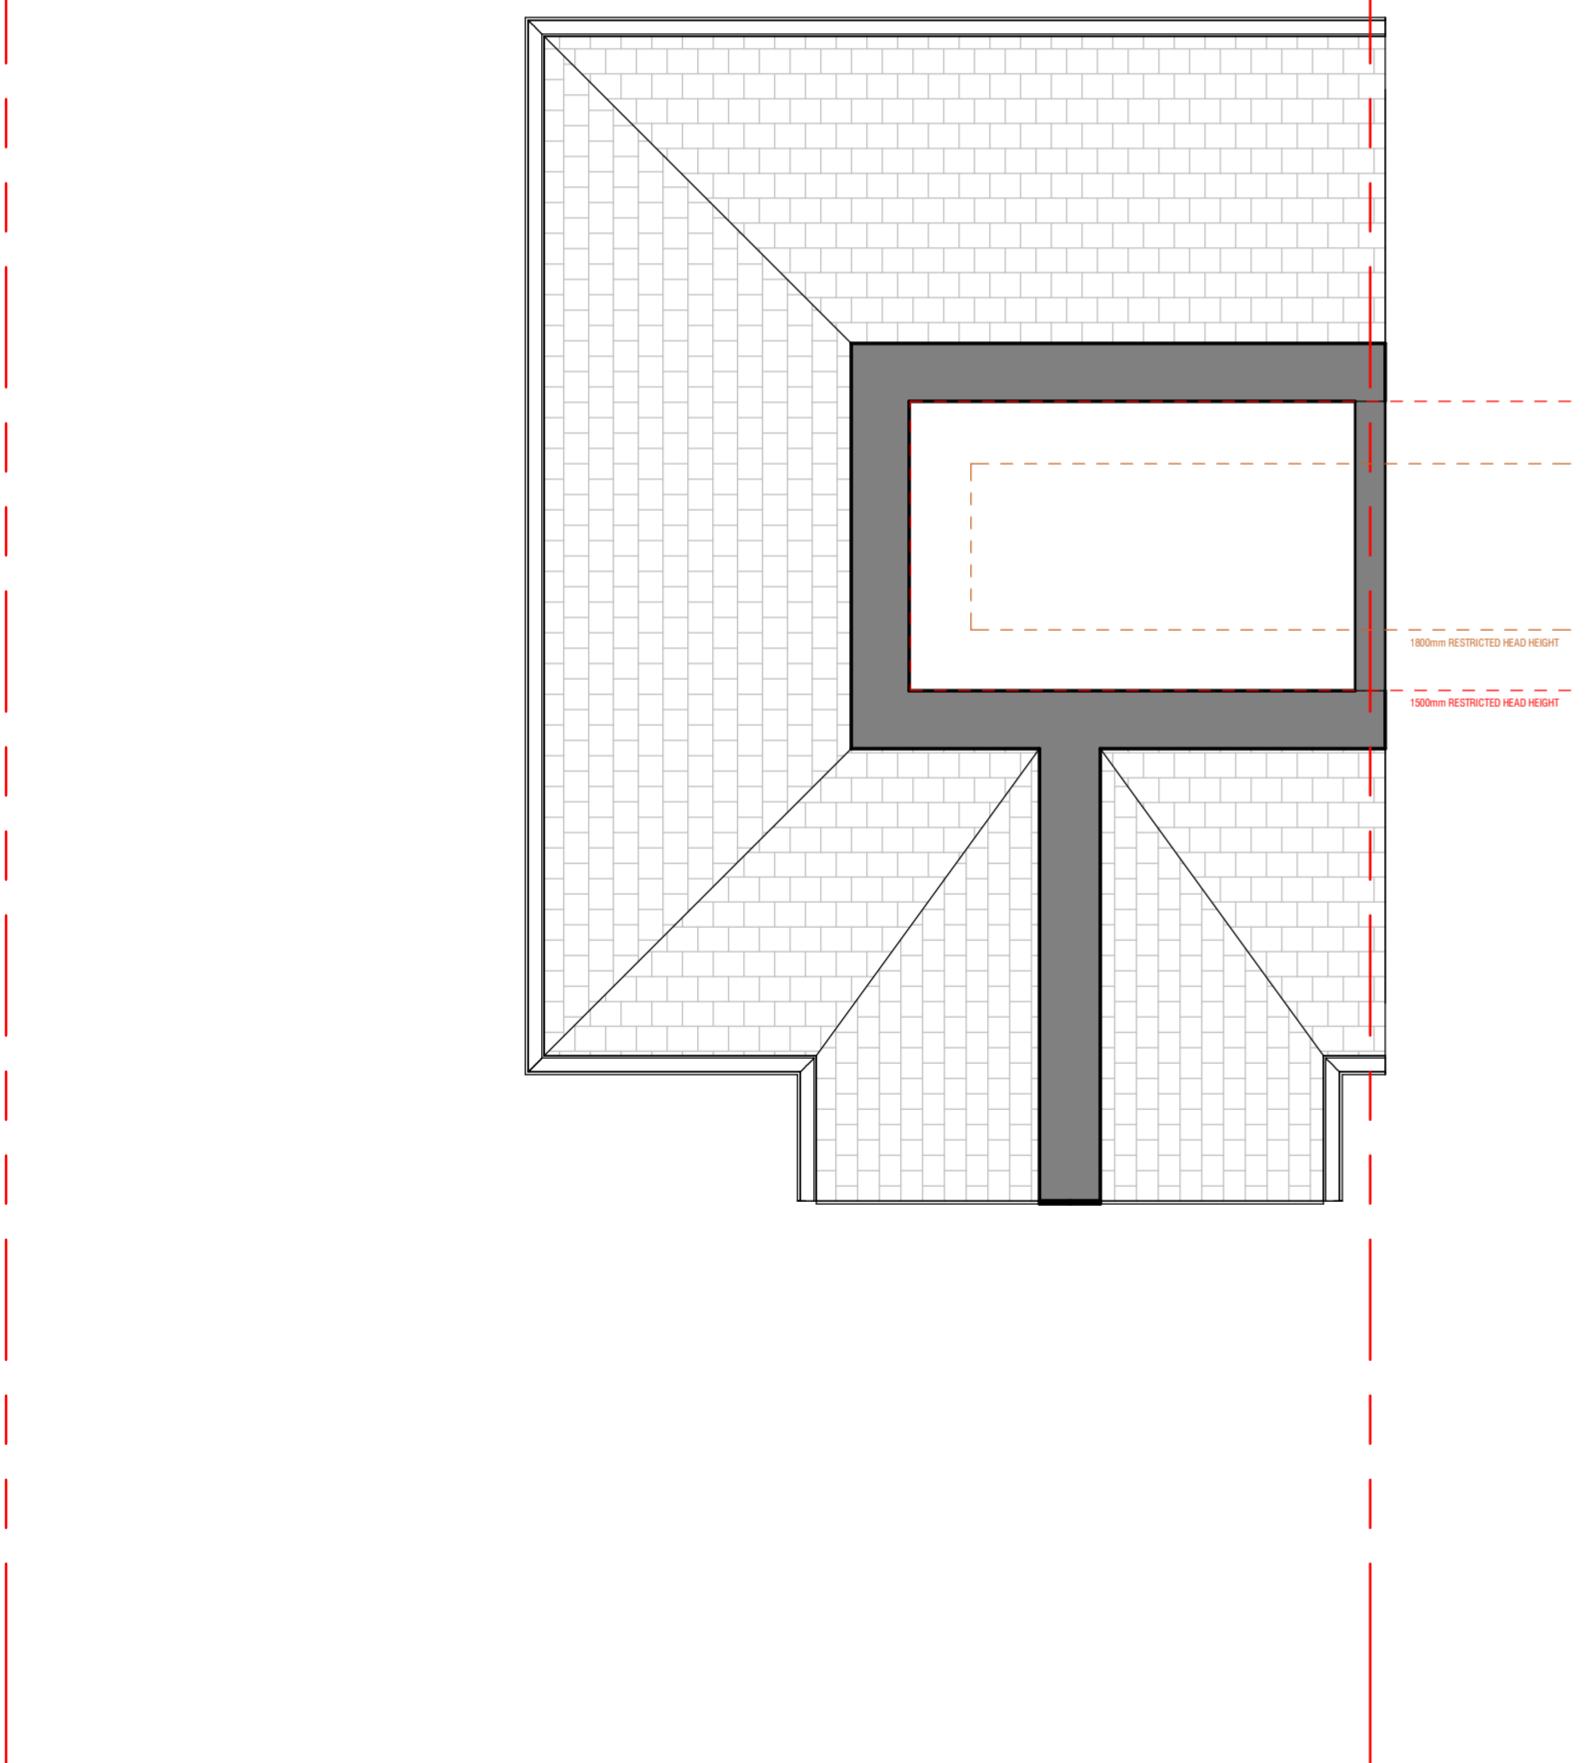

1 Loft Plan - Proposed

1 : 50

2 Roof Plan - Proposed

1 : 50


GENERAL NOTES

1. CHECK ALL DIMENSIONS ON SITE.
2. ALL DIMENSIONS ARE IN MILLIMETRES UNLESS OTHERWISE STATED.
3. ALL VERTICAL MEASUREMENTS ASSUME GROUND TO BE LEVEL UNLESS OTHERWISE STATED.
4. THIS DRAWING SHOULD BE READ IN CONJUNCTION WITH THE GENERAL NOTES.
5. WORKS TO BE CARRIED OUT WITH MATERIALS AND WORKMANSHIP IN COMPLIANCE WITH APPROVED DOCUMENT FOR REGULATION 7 (THE AMENDED BUILDING REGULATIONS 2013)
6. WORKS TO BE CARRIED OUT IN A SAFE MANNER IN ACCORDANCE WITH CDM REGULATIONS 2015.
7. OPEN UP EXISTING STRUCTURE AS REQUIRED BY THE BUILDING INSPECTOR
8. THIRD PARTY SUPPLIER TO MEASURE ON SITE BEFORE MANUFACTURING
9. GENERAL CONTRACTOR TO VERIFY FIELD CONDITIONS PRIOR TO COMMENCEMENT OF EACH PORTION OF THE WORK.
10. ANY DISCREPANCIES IN THESE DRAWINGS SHOULD BE NOTIFIED TO US PRIOR TO ANY WORKS PROCEEDING.
11. UNLESS OTHERWISE INDICATED, PLAN DIMENSIONS ARE TO COLUMN GRID ON CENTERLINES. NOMINAL SURFACE OF MASONRY, FACE OF STUDS AND FACE OF CONCRETE WALLS AND BEAM CENTRES.
12. "FLOOR LINE" REFERS TO TOP OF CONCRETE SLABS. FINISH FLOORING IS INSTALLED ABOVE THE FLOOR LINE. FOR DEPRESSED FLOORS AND CURBS, SEE STRUCTURAL DRAWINGS.
13. REPETITIVE FEATURES ARE NOT ALWAYS DRAWN IN THEIR ENTIRETY AND SHALL BE COMPLETELY PROVIDED AS IF DRAWN IN FULL.
14. WHERE A DOOR IS LOCATED NEAR CORNER OF ROOM AND IS NOT LOCATED BY DIMENSION ON PLAN OR DETAILS, DIMENSION SHALL BE 100MM FROM FACE OF STUD (WALL).
15. LINE OF EXISTING FLOOR SLABS, AS SHOWN ON THE BUILDING ELEVATIONS AND SECTIONS ARE APPROXIMATE.
16. FLOOR LEVELS AND BOUNDARIES ASSUMED WHERE NOTED, DEPICTED BY LINE DASH LINES.
17. REFER TO ARCHITECTURAL, STRUCTURAL, MECHANICAL, ELECTRICAL, GENERAL SPECIFICATION AND OTHER CATEGORIES OR DRAWINGS FOR ADDITIONAL NOTES.
18. VERIFY SIZE/LOCATION/FINISH/FIRE-RATING, ETC. AND PROVIDE COMPLETE AND REQUIRED OPENINGS THROUGH FLOORS AND WALLS, ACCESS DOORS, FUHRING, CURBS, ANCHORS & INSERTS.
19. CONTRACTOR TO CARRY OUT MOST LOGICAL SOLUTION BUT TO CHECK WITH ARCHITECT OR ENGINEER IF UNSURE. REQUESTS BY CLIENTS THAT DEVIATE FROM DESIGN VOIDS THE DESIGN LIABILITY.
20. SEE STRUCTURAL GENERAL NOTES AND PLANS TO COMPLEMENT ARCHITECTURAL PLANS AT ALL TIMES, DO NOT ASSUME ANYTHING.
21. STAIR LAYOUTS AND DESIGNS ARE INDICATIVE SIZE AND POSITION FOR BUILDING CONTROL APPROVAL, NOT TO BE USED AS CONSTRUCTION DRAWINGS. FINAL STAIR SPECIFICATIONS TBC FROM STAIR SUPPLIER.
22. ALL DIMENSIONS ARE INDICATIVE AND TO BE CONFIRMED ON SITE BY CONTRACTOR.
23. THIS DRAWING SET IS FOR PLANNING OR BUILDING CONTROL APPROVAL AND NOT TO BE USED AS FINAL CONSTRUCTION DRAWINGS, UNLESS STATED OTHERWISE.




1 Proposed Front Elevation

1 : 50

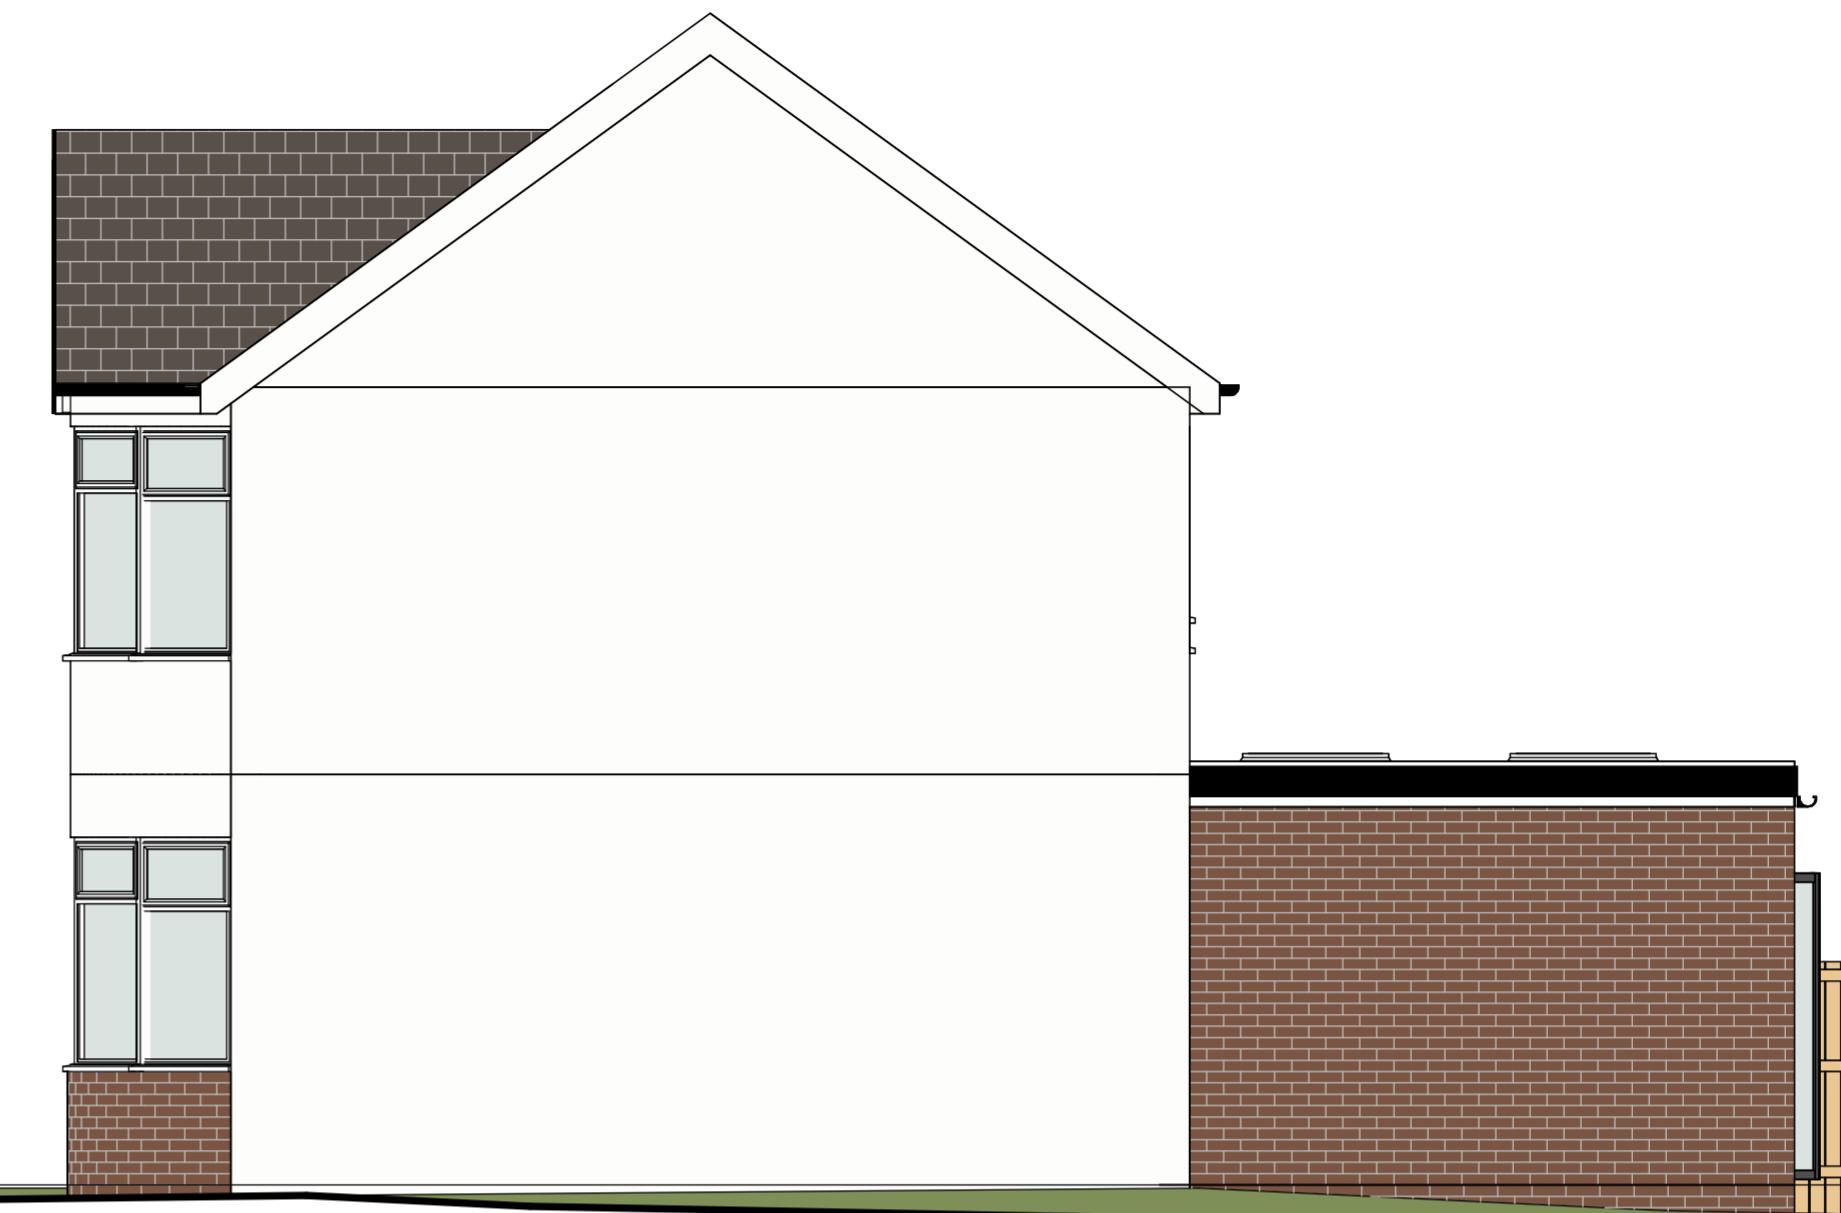

2 Proposed Right Side Elevation

1 : 50

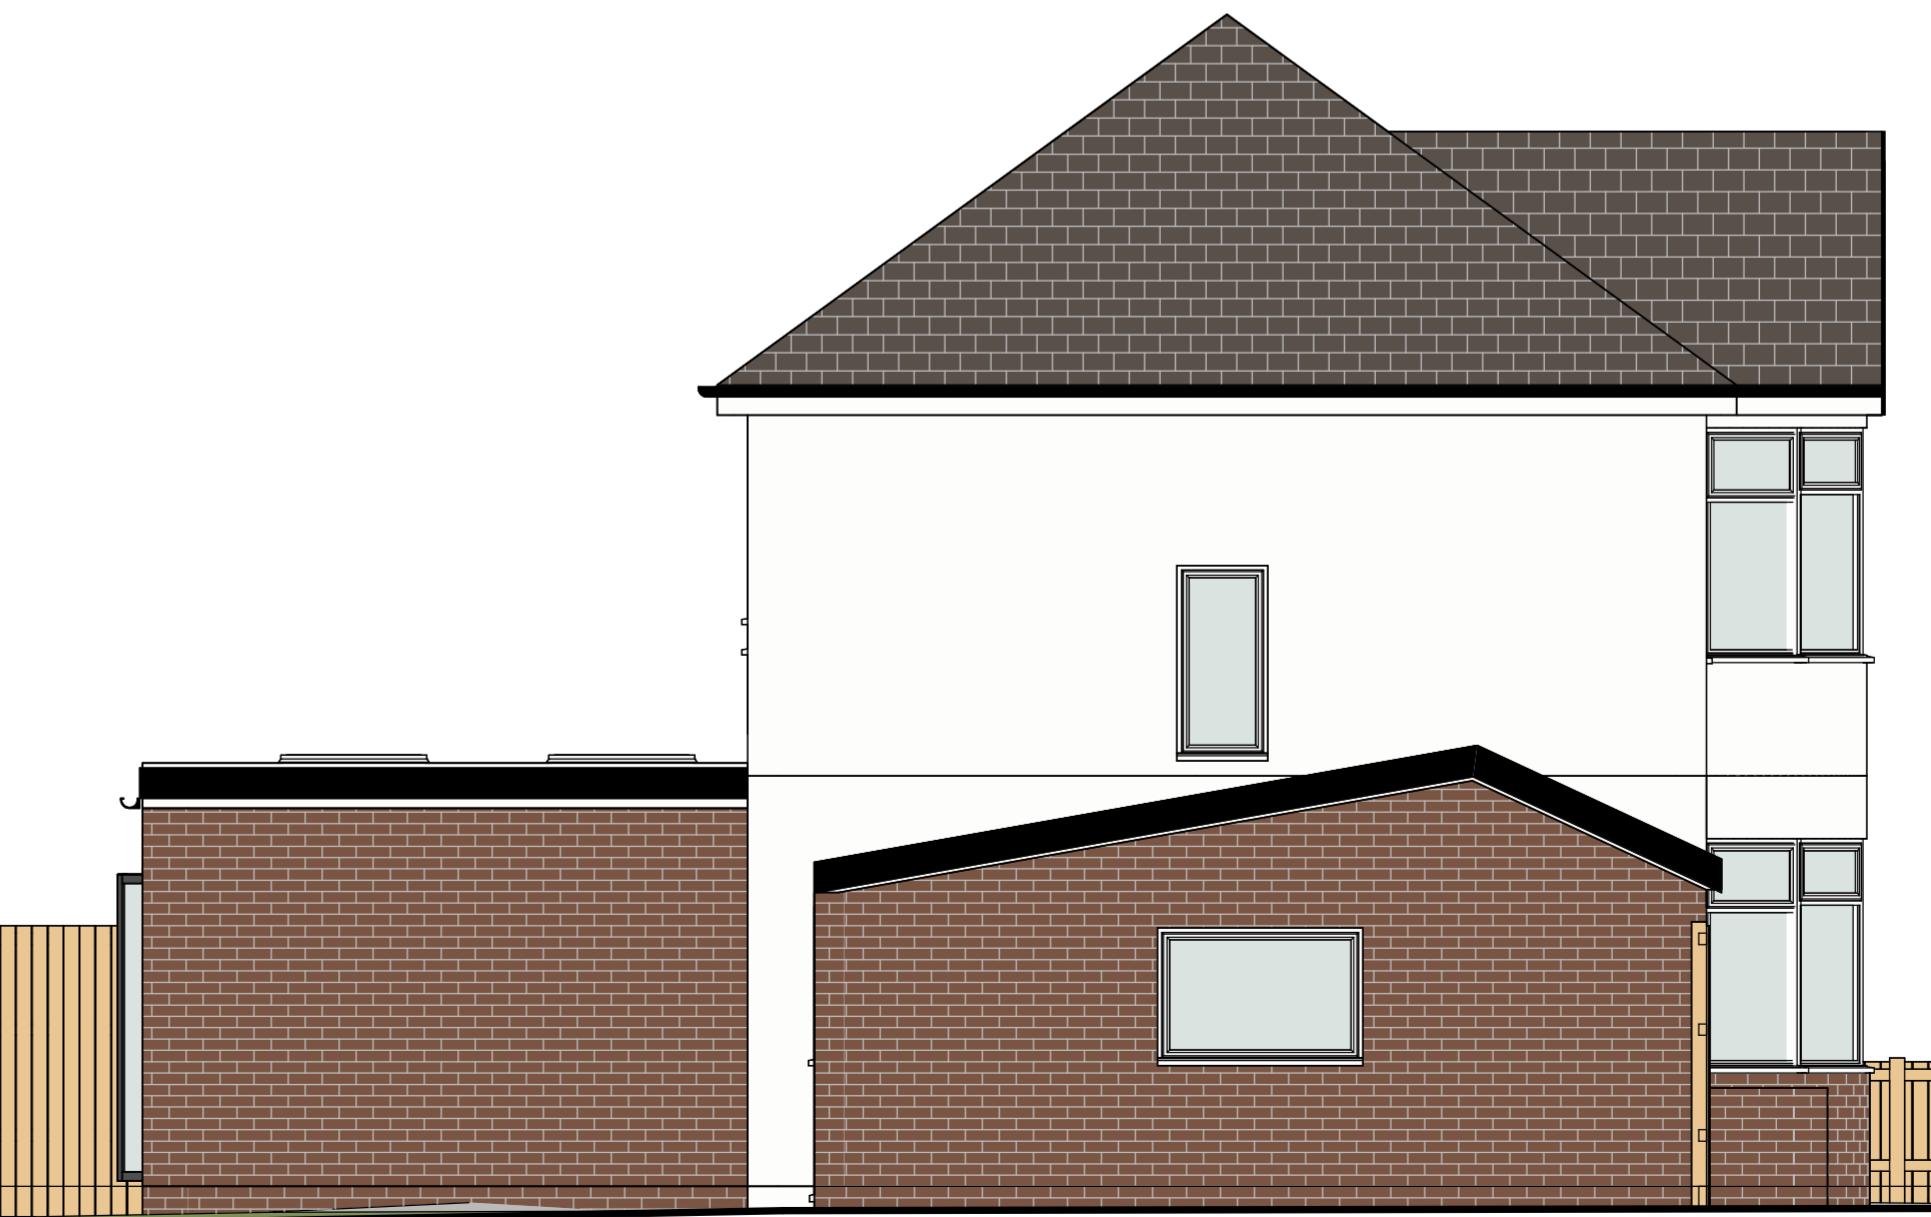

4 Proposed Left Side Elevation

1 : 50



3 Proposed Rear Elevation

1 : 50

0 1 2 3 4 5 6

1:100m

0 0.5 1 2 3 3

1:50m

No.: Revision: Date:

BISCHELL
THE DESIGN & BUILD COMPANY

Bischell - Design & Build -
Suite 114
80 Cumberland House, Scrubs Lane
Hammersmith & Fulham, NW10 6RF
www.bischell.co.uk

Client: 20 Seaton Gardens, Ruislip HA4 0AX, UK

Drawing Title: Proposed Elevations

Status: PN

Scale: 1 : 50 @ A2 Date: 13/03/2024 Drawn By: SR

Drawing No.: PN-009 Rev: