




Existing Ground Floor Plan
Scale 1:100

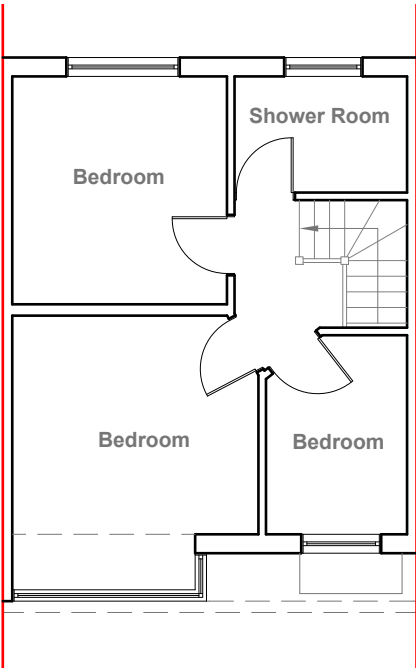


Existing First Floor Plan
Scale 1:100

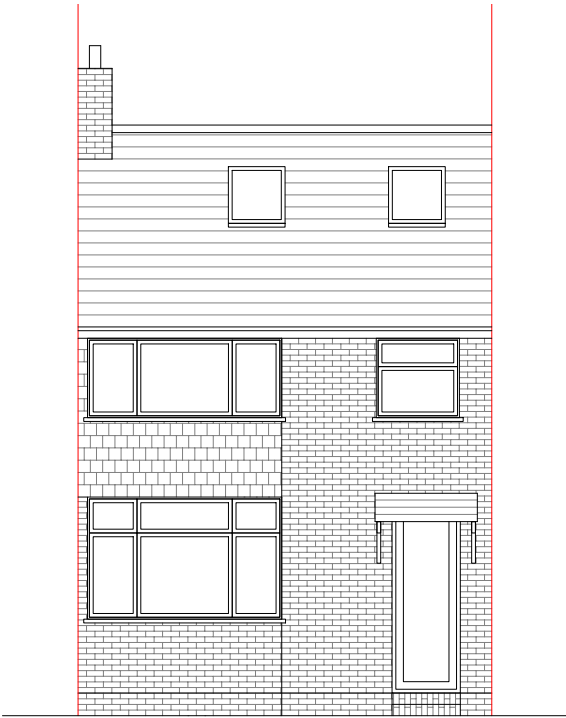


Existing Front Elevation
Scale 1:100

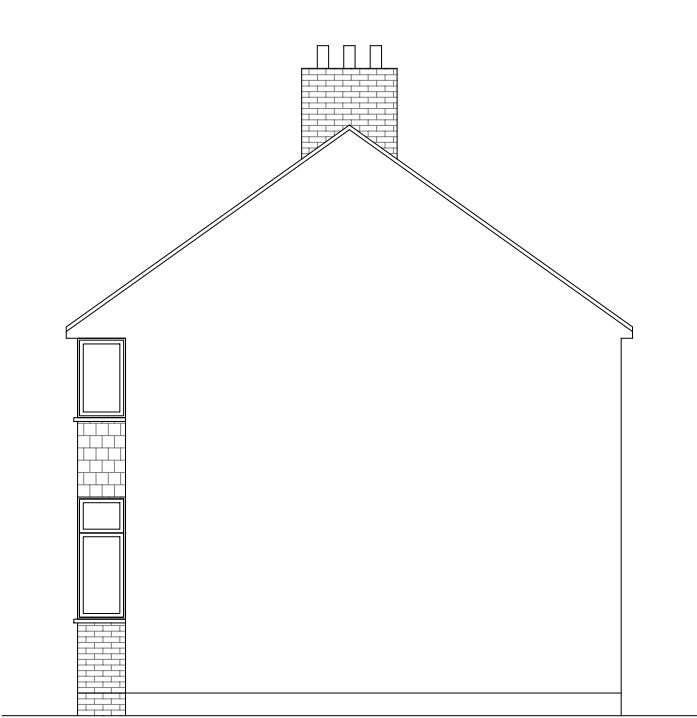

Existing Side Elevation
Scale 1:100

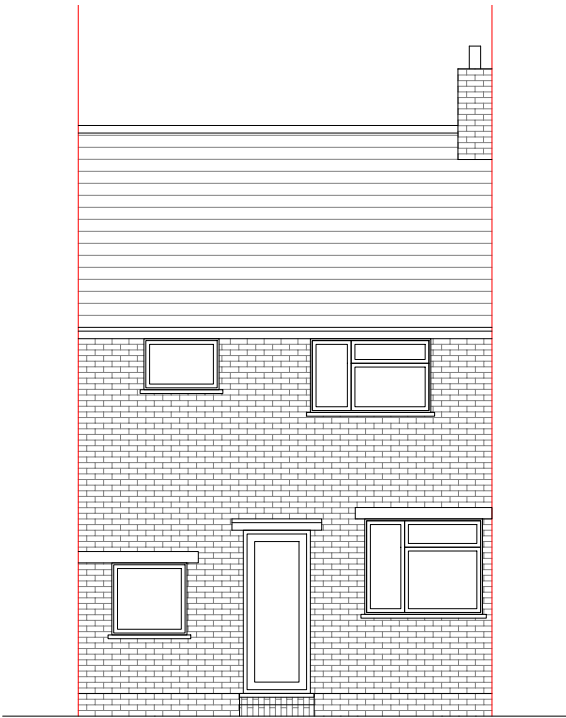

Existing Rear Elevation
Scale 1:100

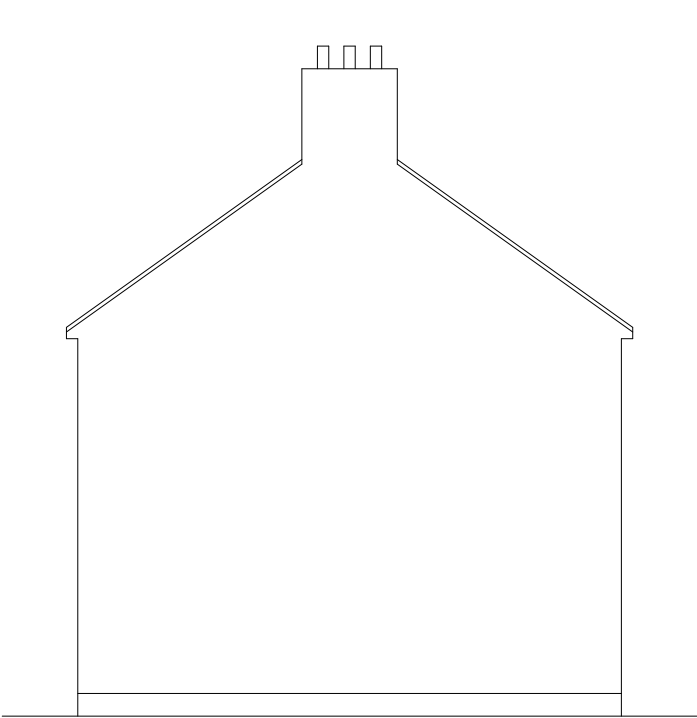

Existing Side Elevation
Scale 1:100




GENERAL NOTES:
1. ALL DIMENSIONS ARE IN MILLIMETER.
2. VERIFY ALL DIMENSIONS AND CONDITIONS BEFORE BUILDING OR STARTING CONSTRUCTION. NOTIFY THE DESIGNER IMMEDIATELY OF ANY DISCREPANCY OR VARIATION.
3. ALL WORK TO COMPLY WITH CURRENT BUILDING REGULATIONS AND CODES OF PRACTICE

Title:


Existing Plans & Elevations

Site Address	Scale: 1:100 @A3	Revision Date:
68 Princes Park Lane, Hayes, Middlesex, UB3 1JX	Date: 13/05/2025	
	Drawing No.: 2024/027 -01PD	
	Drawn By: JG	e:mail - faluckpatel@yahoo.com (M) +44 (0) 7871 466 254



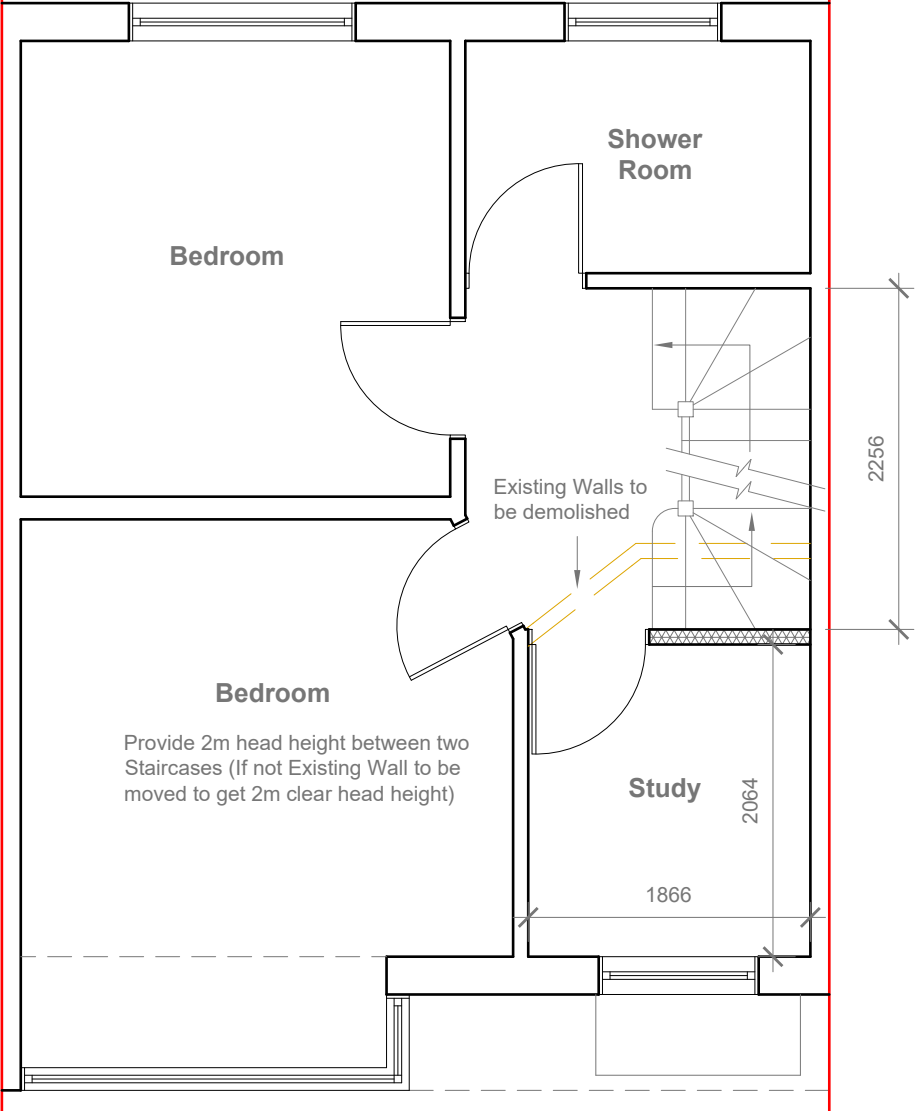

Proposed First Floor Plan
Scale 1:50

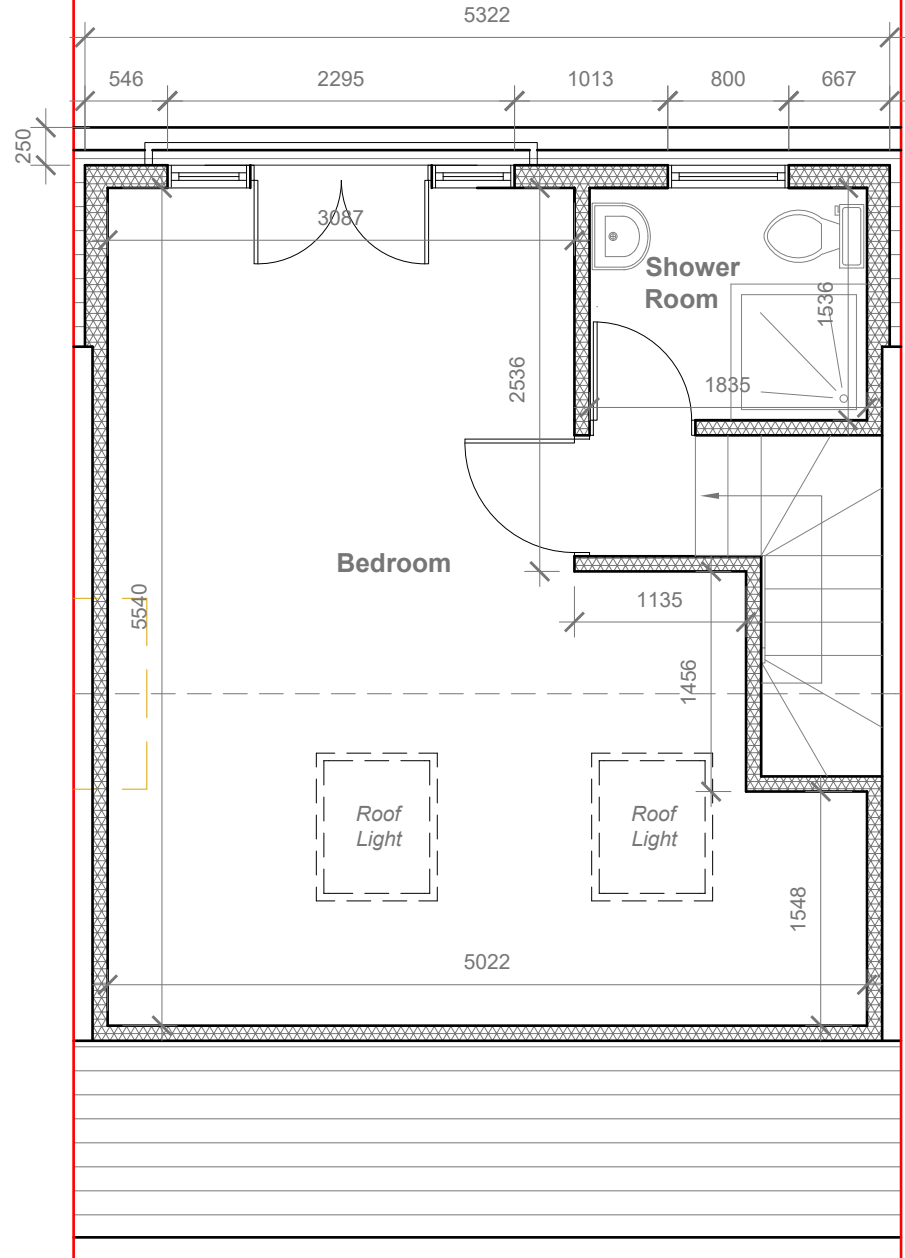

Proposed Loft Floor Plan
Scale 1:50



GENERAL NOTES:
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 2. VERIFY ALL DIMENSIONS AND CONDITIONS BEFORE BUILDING OR STARTING CONSTRUCTION. NOTIFY THE DESIGNER IMMEDIATELY OF ANY DISCREPANCY OR VARIATION.
 3. ALL WORK TO COMPLY WITH CURRENT BUILDING REGULATIONS AND CODES OF PRACTICE

Title:

Proposed Plans


Site Address	Scale: 1:50 @A3	Revision Date:
68 Princes Park Lane, Hayes, Middlesex, UB3 1JX	Date: 13/05/2025	
	Drawing No.: 2024/027 -02PD	
	Drawn By: JG	
		e:mail - faluckpatel@yahoo.com (M) +44 (0) 7871 466 254



Velux Window to be installed as per manufacturer specification, not projected more than 150mm from the plane of roof slope



Proposed Front Elevation
Scale 1:100

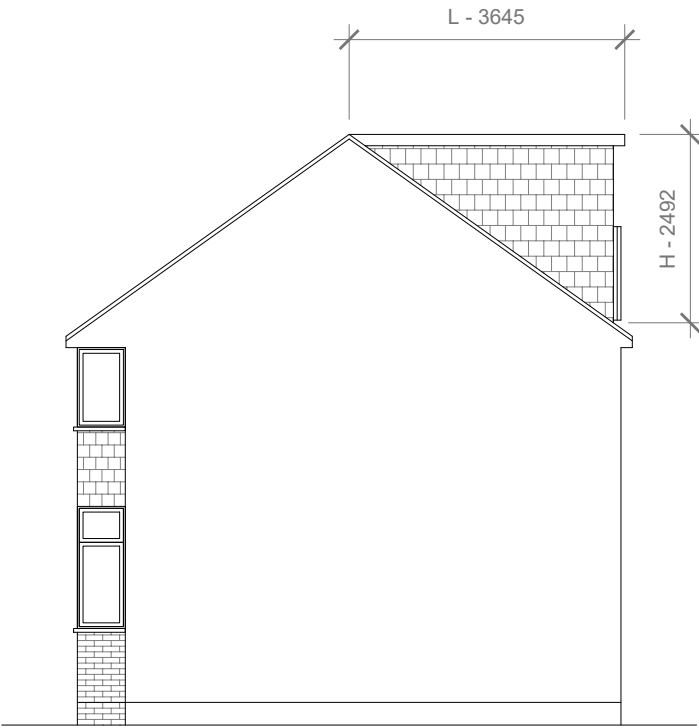


Proposed Side Elevation
Scale 1:100


Proposed External Finish Materials to Match Existing External Finish Materials

REAR DORMER VOLUME

$$V = \frac{W \times H \times L}{2}$$
$$= \frac{5.422 \times 2.492 \times 3.645}{2}$$
$$= \frac{49.25}{2}$$
$$= 24.63 \text{ CU.MT.} < 40 \text{ CU.MT.}$$

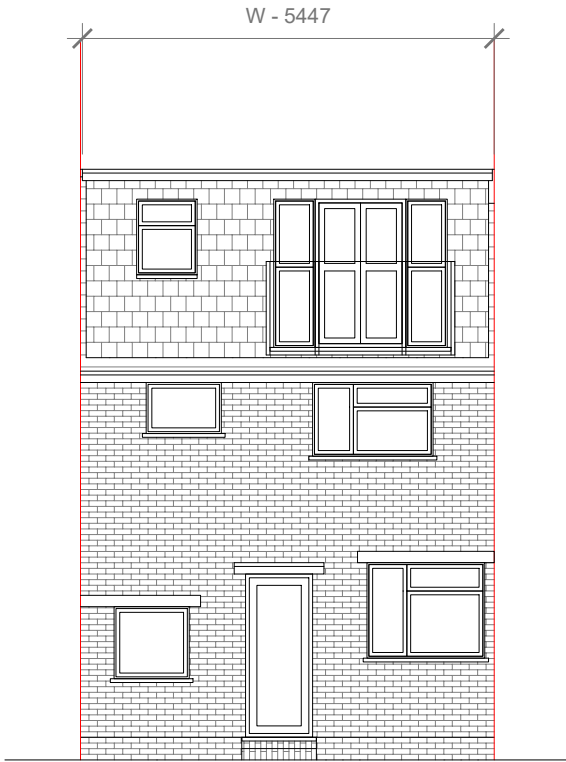

Proposed Rear Elevation
Scale 1:100

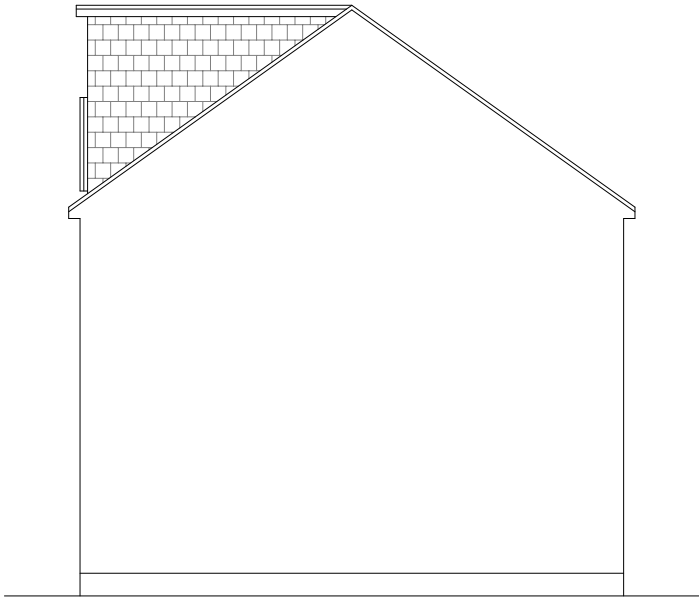

Proposed Side Elevation
Scale 1:100



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3. ALL WORK TO COMPLY WITH CURRENT BUILDING REGULATIONS AND CODES OF PRACTICE

Title:

Proposed Elevations

Site Address	Scale: 1:100 @A3	Revision Date:
68 Princes Park Lane, Hayes, Middlesex, UB3 1JX	Date: 13/05/2025	
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