


**Existing Ground Floor Plan**

Scale 1:100

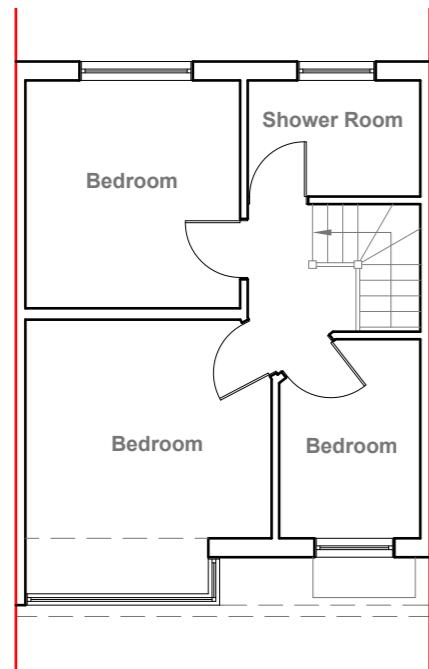


**Existing First Floor Plan**

Scale 1:100




**Existing Front Elevation**

Scale 1:100

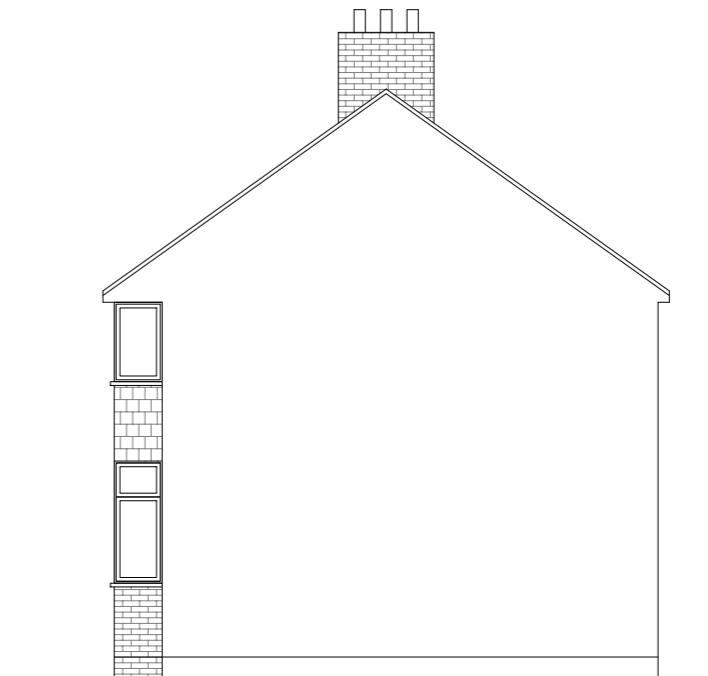


**Existing Side Elevation**

Scale 1:100

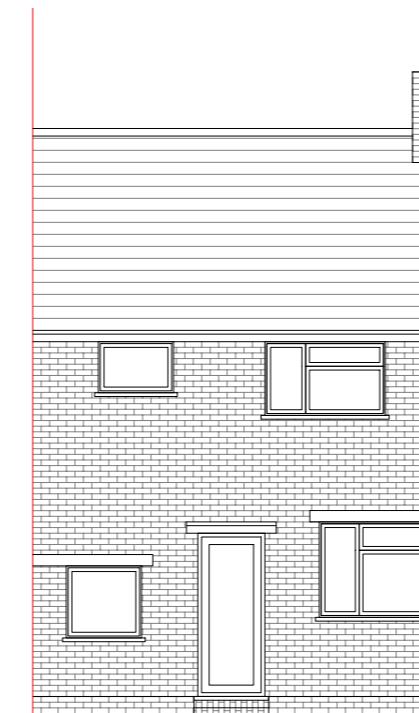

**Existing Rear Elevation**

Scale 1:100

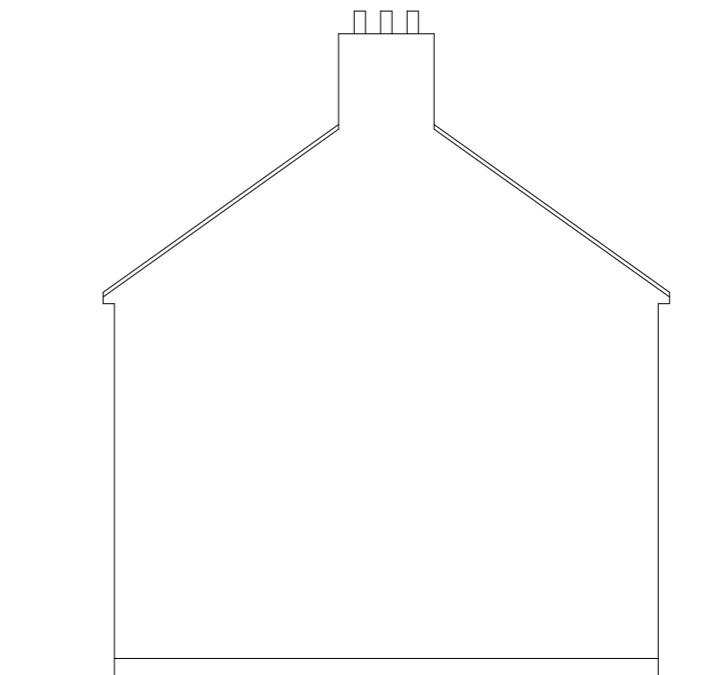

**Existing Side Elevation**

Scale 1:100

10 Meter  
5  
2  
1  
0  
1:100

GENERAL NOTES:  
 1. ALL DIMENSIONS ARE IN MILLIMETER.  
 2. VERIFY ALL DIMENSIONS AND CONDITIONS BEFORE BUILDING OR  
 STARTING CONSTRUCTION. NOTIFY THE DESIGNER IMMEDIATELY OF ANY  
 DISCREPANCY OR VARIATION.  
 3. ALL WORK TO COMPLY WITH CURRENT BUILDING REGULATIONS  
 AND CODES OF PRACTICE


Title:

## Existing Plans & Elevations


Site Address  
68 Princes Park  
Lane, Hayes,  
Middlesex,  
UB3 1JX

Scale: 1:100 @A3  
Date: 13/05/2025  
Drawing No.:  
2024/027 -01PD  
Drawn By:  
JG

Revision Date:  
\_\_\_\_\_  
\_\_\_\_\_  
\_\_\_\_\_  
e:mail -  
faluckpatel@yahoo.com  
(M) +44 (0) 7871 466 254

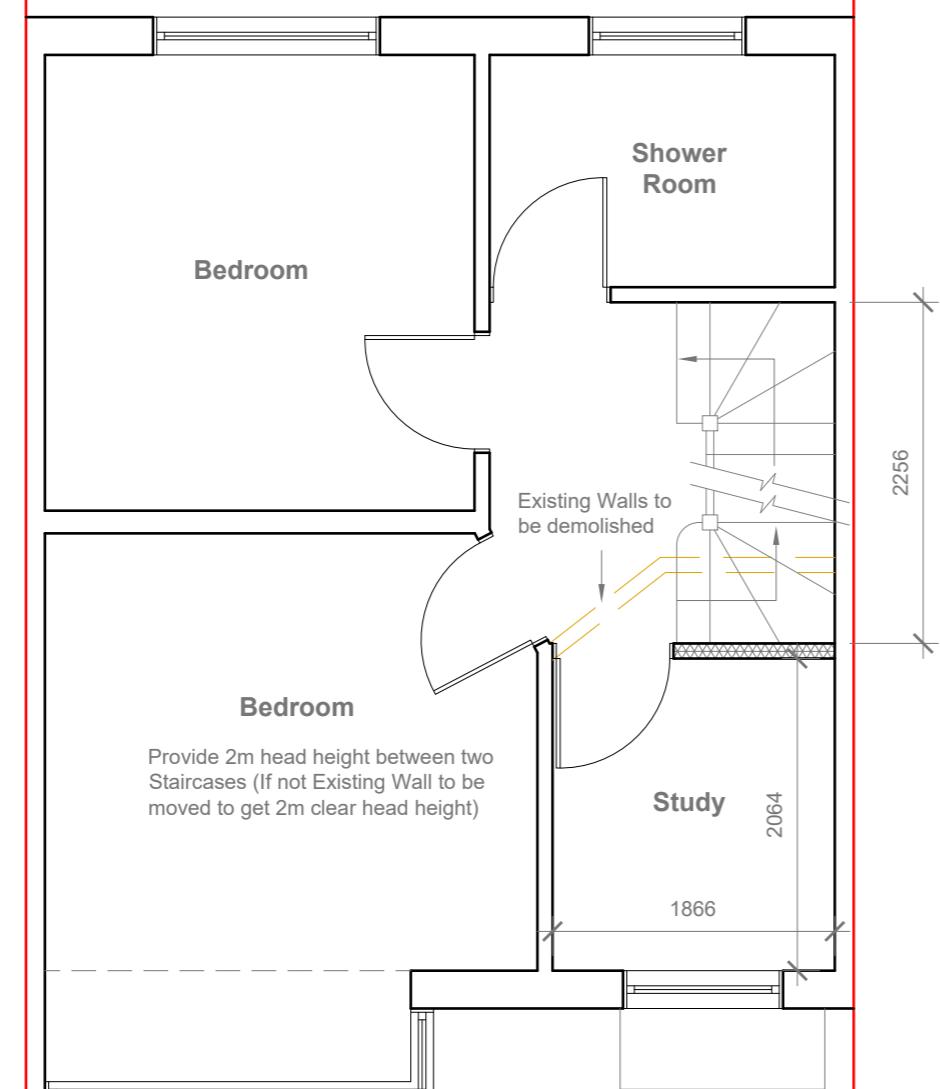

## Proposed First Floor Plan

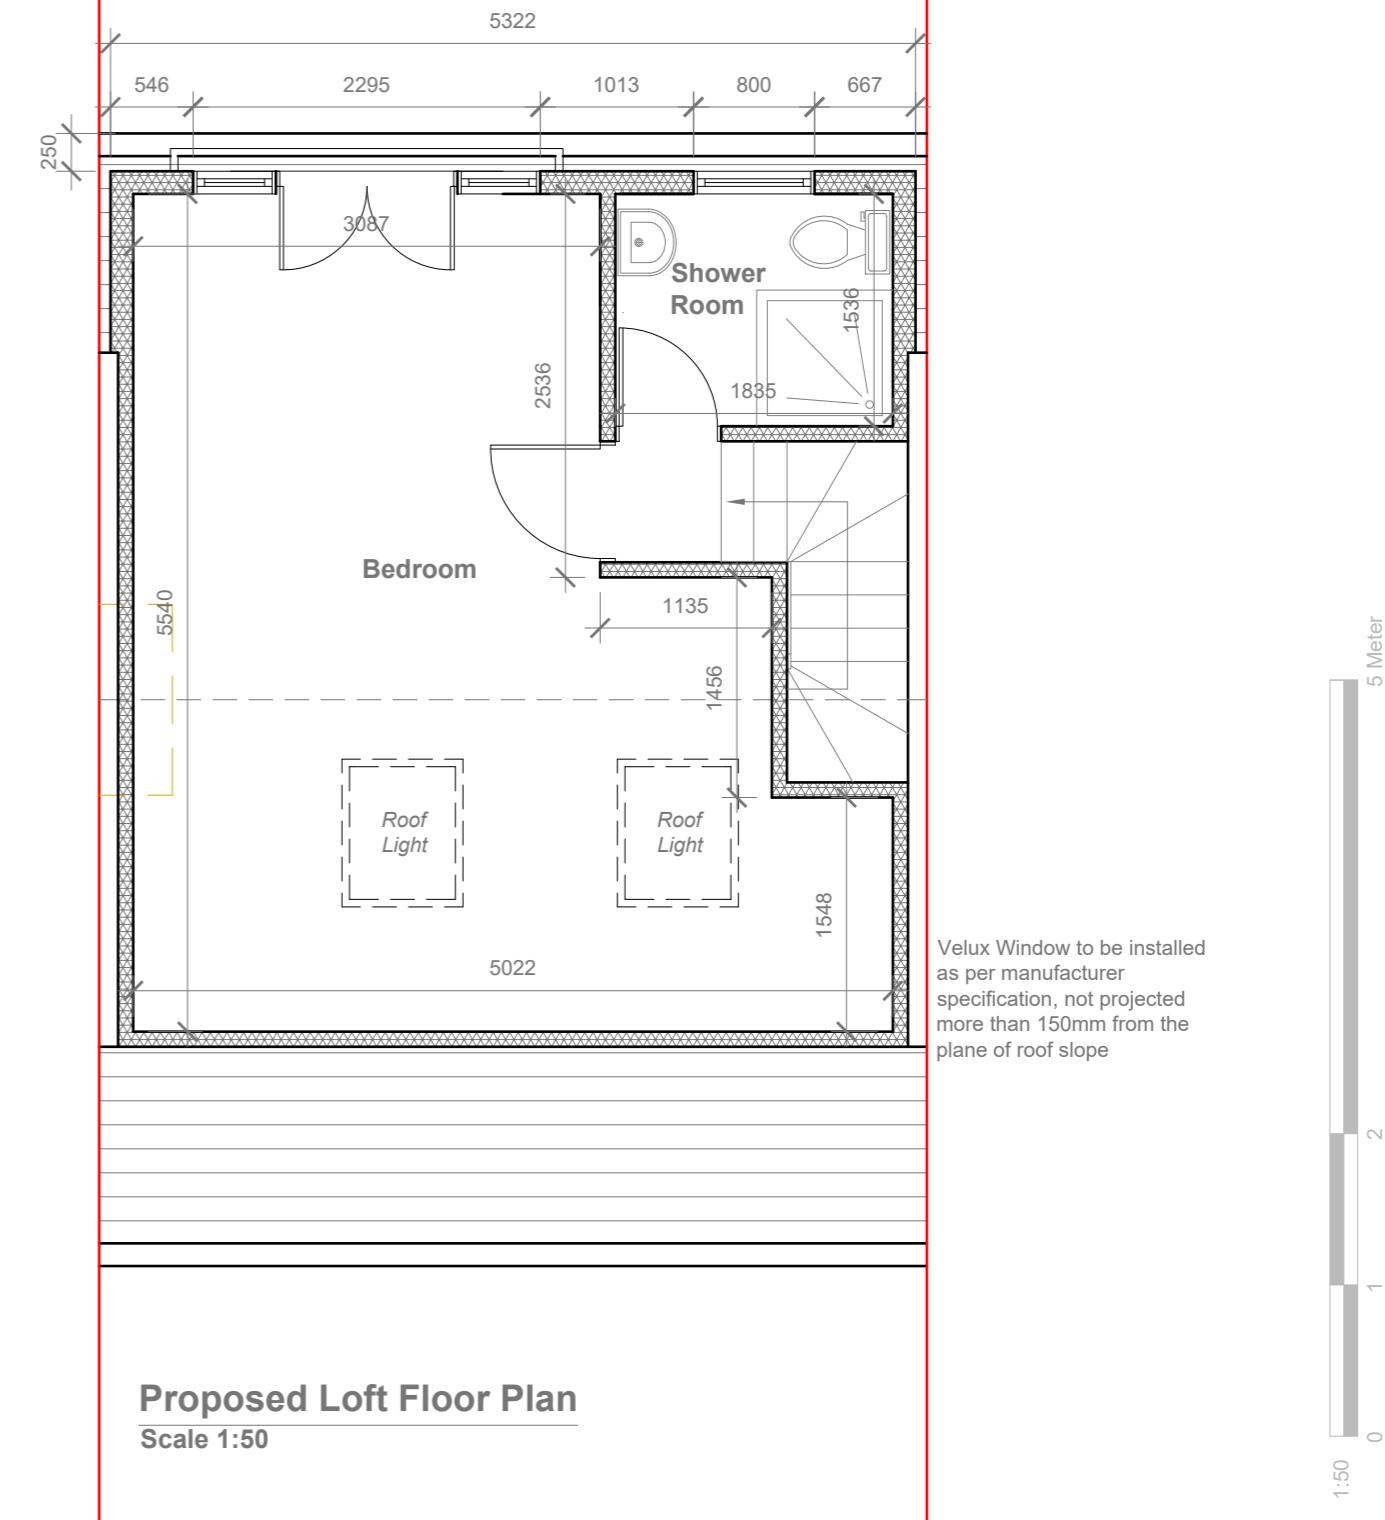

GENERAL NOTES:

1. ALL DIMENSIONS ARE IN MILLIMETER.
2. VERIFY ALL DIMENSIONS AND CONDITIONS BEFORE BUILDING OR STARTING CONSTRUCTION. NOTIFY THE DESIGNER IMMEDIATELY OF ANY DISCREPANCY OR VARIATION.
3. ALL WORK TO COMPLY WITH CURRENT BUILDING REGULATIONS AND CODES OF PRACTICE

Title


## Proposed Plans

Site Address  
68 Princes P  
Lane, Hayes,  
Middlesex,  
UB3 1JX


Scale: 1:50 @A3  
Date: 13/05/2025  
Drawing No.:  
2024/027 -02PD  
Drawn By:

# Faluck Patel

Velux Window to be installed as per manufacturer specification, not projected more than 150mm from the plane of roof slope

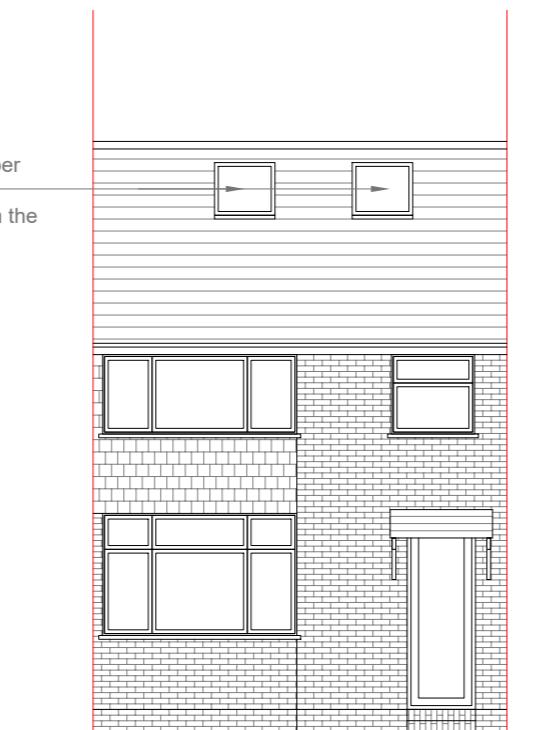


**Proposed Front Elevation**  
Scale 1:100

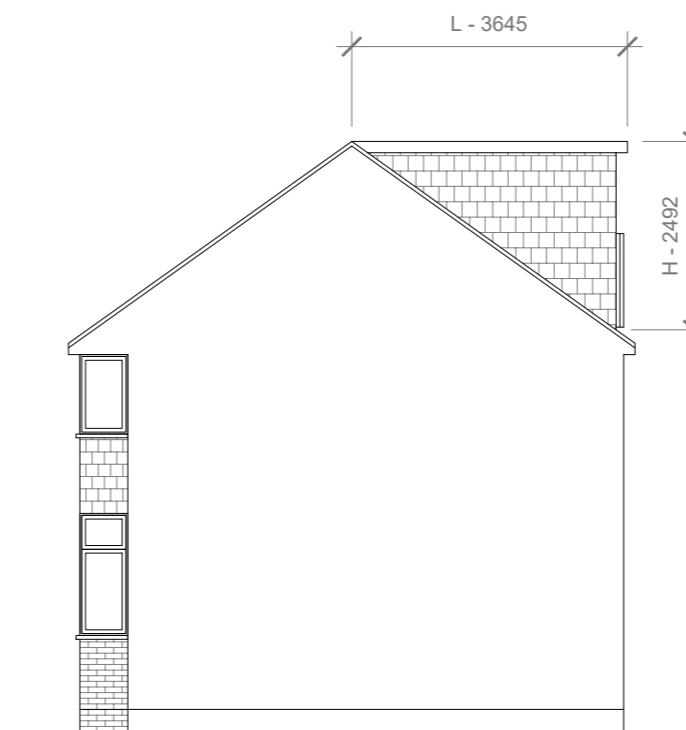


#### REAR DORMER VOLUME

$W \times H \times L / 2$   
5.422 X 2.492 X 3.645 / 2  
49.25 / 2  
 $V = 24.63 \text{ CU.MT.} < 40 \text{ CU.MT.}$

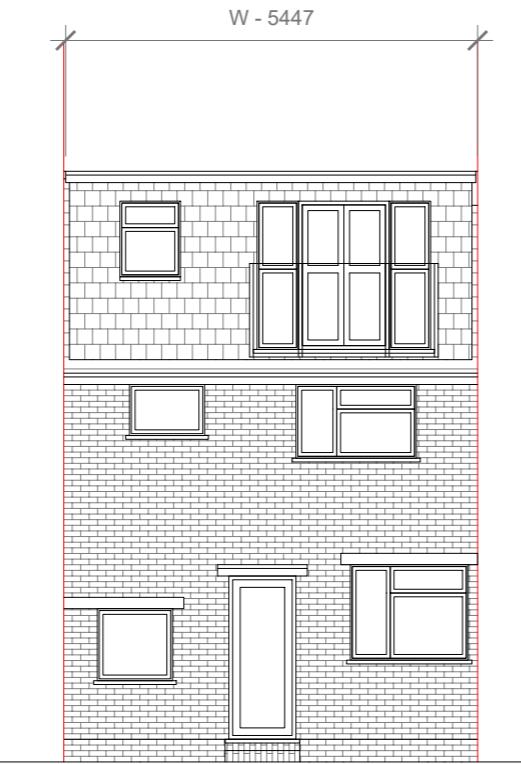

**Proposed Rear Elevation**  
Scale 1:100

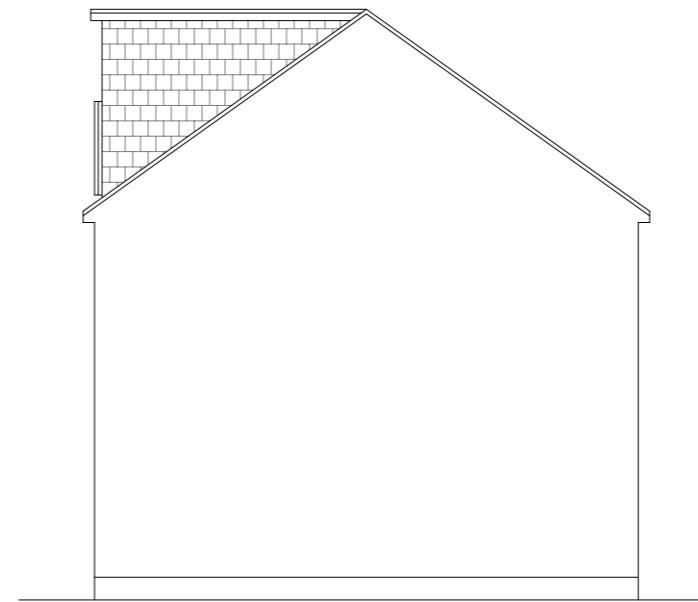

**Proposed Side Elevation**  
Scale 1:100

10 Meter  
5  
5  
2  
1  
0  
1:100

GENERAL NOTES:  
1. ALL DIMENSIONS ARE IN MILLIMETER.  
2. VERIFY ALL DIMENSIONS AND CONDITIONS BEFORE BUILDING OR STARTING CONSTRUCTION. NOTIFY THE DESIGNER IMMEDIATELY OF ANY DISCREPANCY OR VARIATION.  
3. ALL WORK TO COMPLY WITH CURRENT BUILDING REGULATIONS AND CODES OF PRACTICE

Title: \_\_\_\_\_

## Proposed Elevations

Site Address	Scale: 1:100 @A3	Revision Date:
68 Princes Park Lane, Hayes, Middlesex, UB3 1JX	Date: 13/05/2025	_____
	Drawing No.: 2024/027 -03PD	_____
	Drawn By: JG	e:mail - faluckpatel@yahoo.com (M) +44 (0) 7871 466 254

**Faluck Patel**