



GROUND FLOOR PLAN

SCALE 1:100

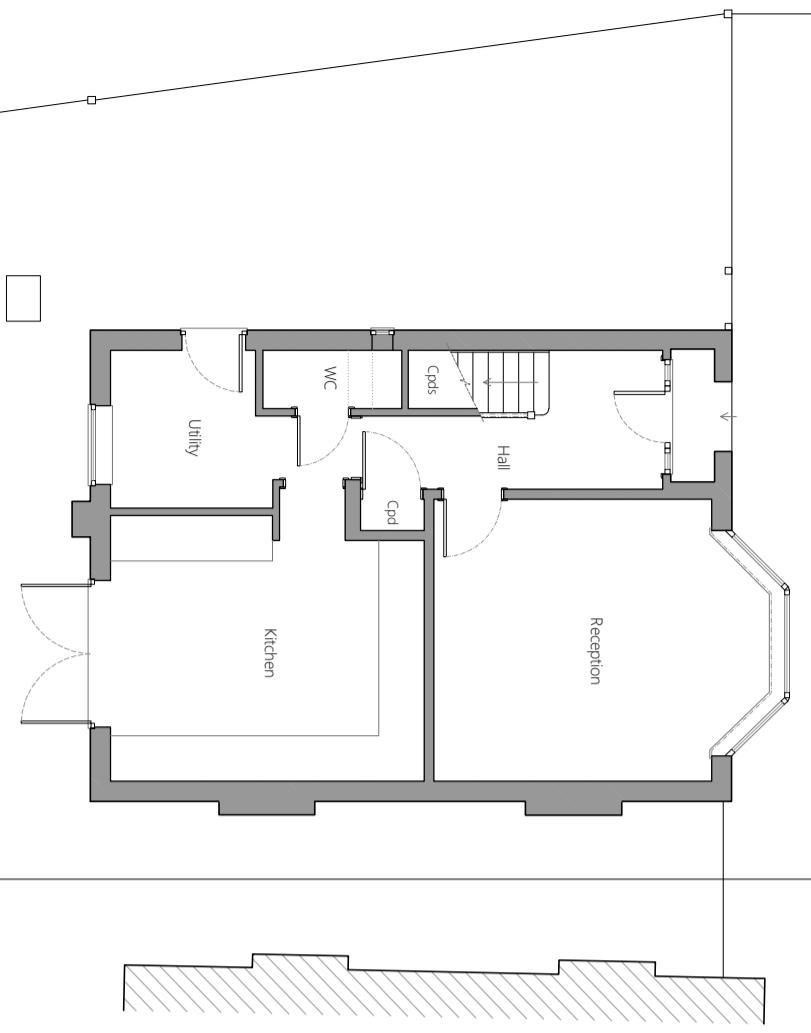


FRONT ELEVATION

SCALE 1:100

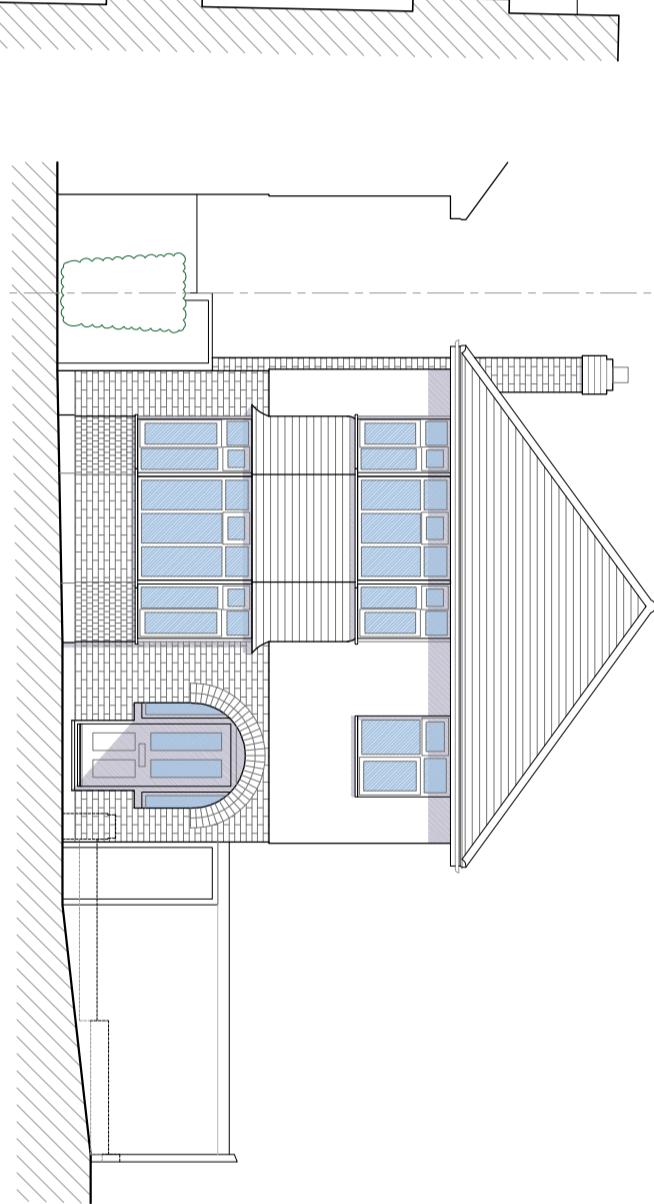


FLANK ELEVATION

SCALE 1:100

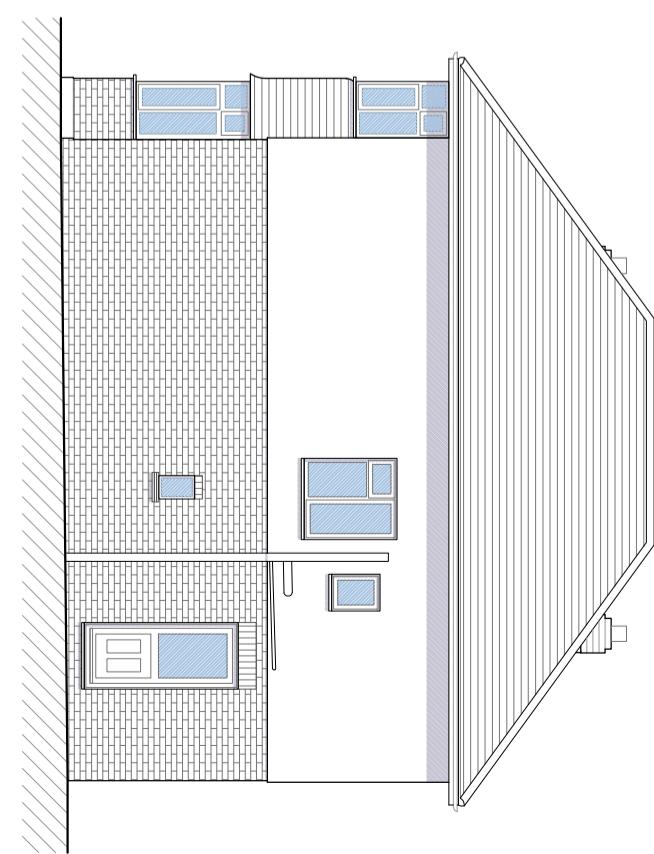


FIRST FLOOR PLAN

SCALE 1:100

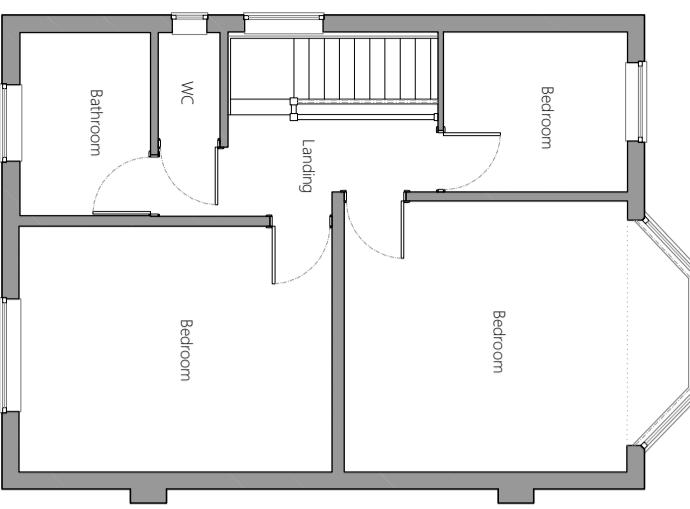


ROOF PLAN

SCALE 1:200

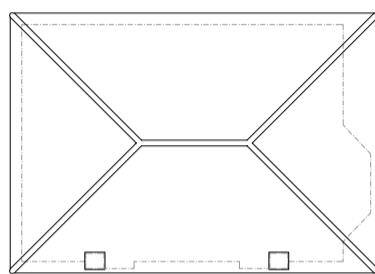


REAR ELEVATION

SCALE 1:100

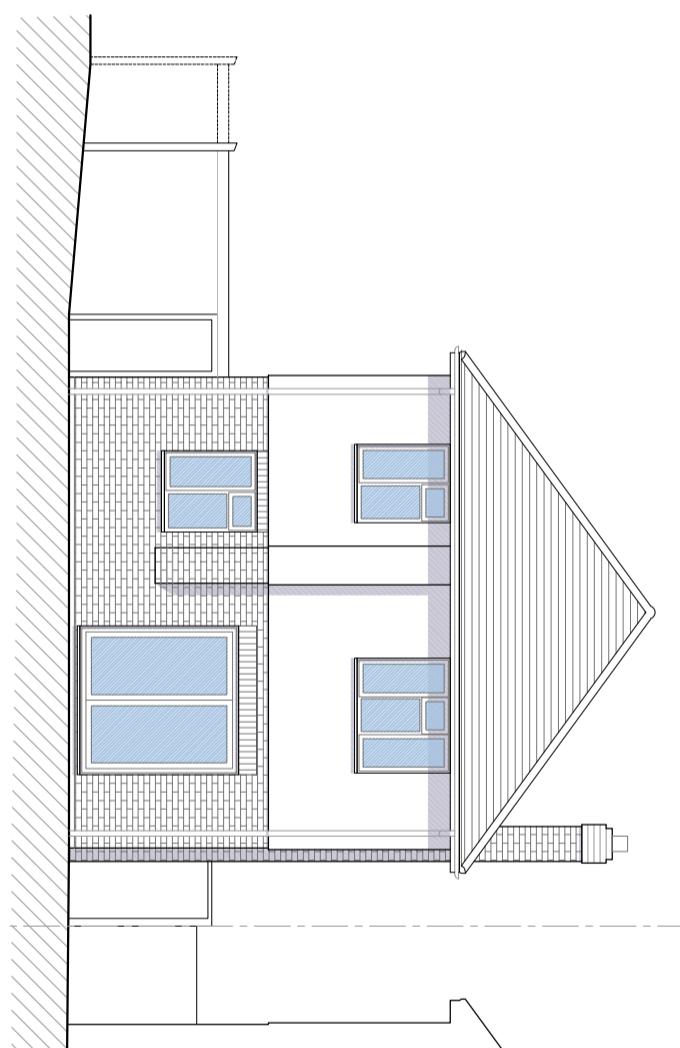

FLANK ELEVATION

SCALE 1:100

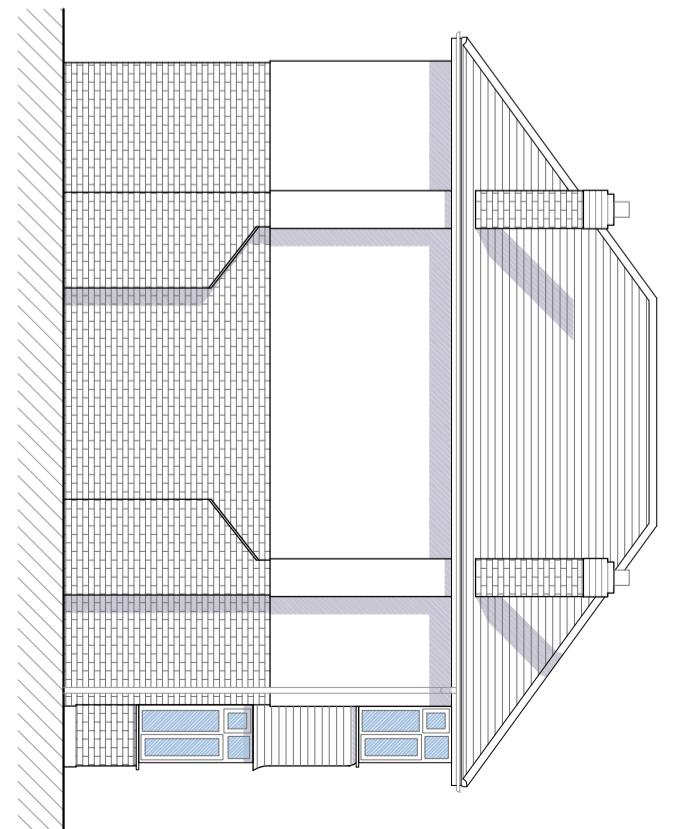

Rev Date Amendment

Ktech technical drawings

General Notes:
Do not scale: use figured dims only. Unless otherwise noted all dimensions are given in millimetres. All dimensions to be verified by the Contractor before work commences. If any discrepancies are found, Ktech is to be notified immediately for amendments. All work to be carried out in strict accordance to relevant & current British Standards, Codes of Practice, CDM Regulations & Building Regulations. Where structural alterations take place, care must be taken by the Contractor to afford required restraint to all affected areas during & after the building work. Where new loads are imposed on existing lintels they must be checked by the Builder for adequacy & to L.A. & S.E. approval & replaced if necessary. Where applicable this drawing must be read in conjunction with Structural Calculations & other Consultants drawings. If drawings conflict with Structural Calculations & other drawings, the Structural Calculations must take precedence. The service provided by Ktech is a drawing service for Planning and Building Regulations submission only. The company accepts no liability for any site works, defects or future defects. Ktech drawings must not be reproduced wholly or in part without prior permission from the company.

© Copyright Ktech technical drawings

Drawing No: 23-29_PL02 Rev: -
Drawing status: For Planning Approval
Drawing title: Double storey side extension - Existing plans & elevations
Drawing scale: 1:100/200@A3
Drawing date: 14/12/2023
Drawing revision: 14/12/2023

Berkhamsted House, 12 High Street, Berkhamsted, Herts, HP4 2DU
m: 07711525919 e: ktechdrawings@yahoo.com

Project title: 99 Queen's Walk, Ruislip HA4 0NN