

NOTES

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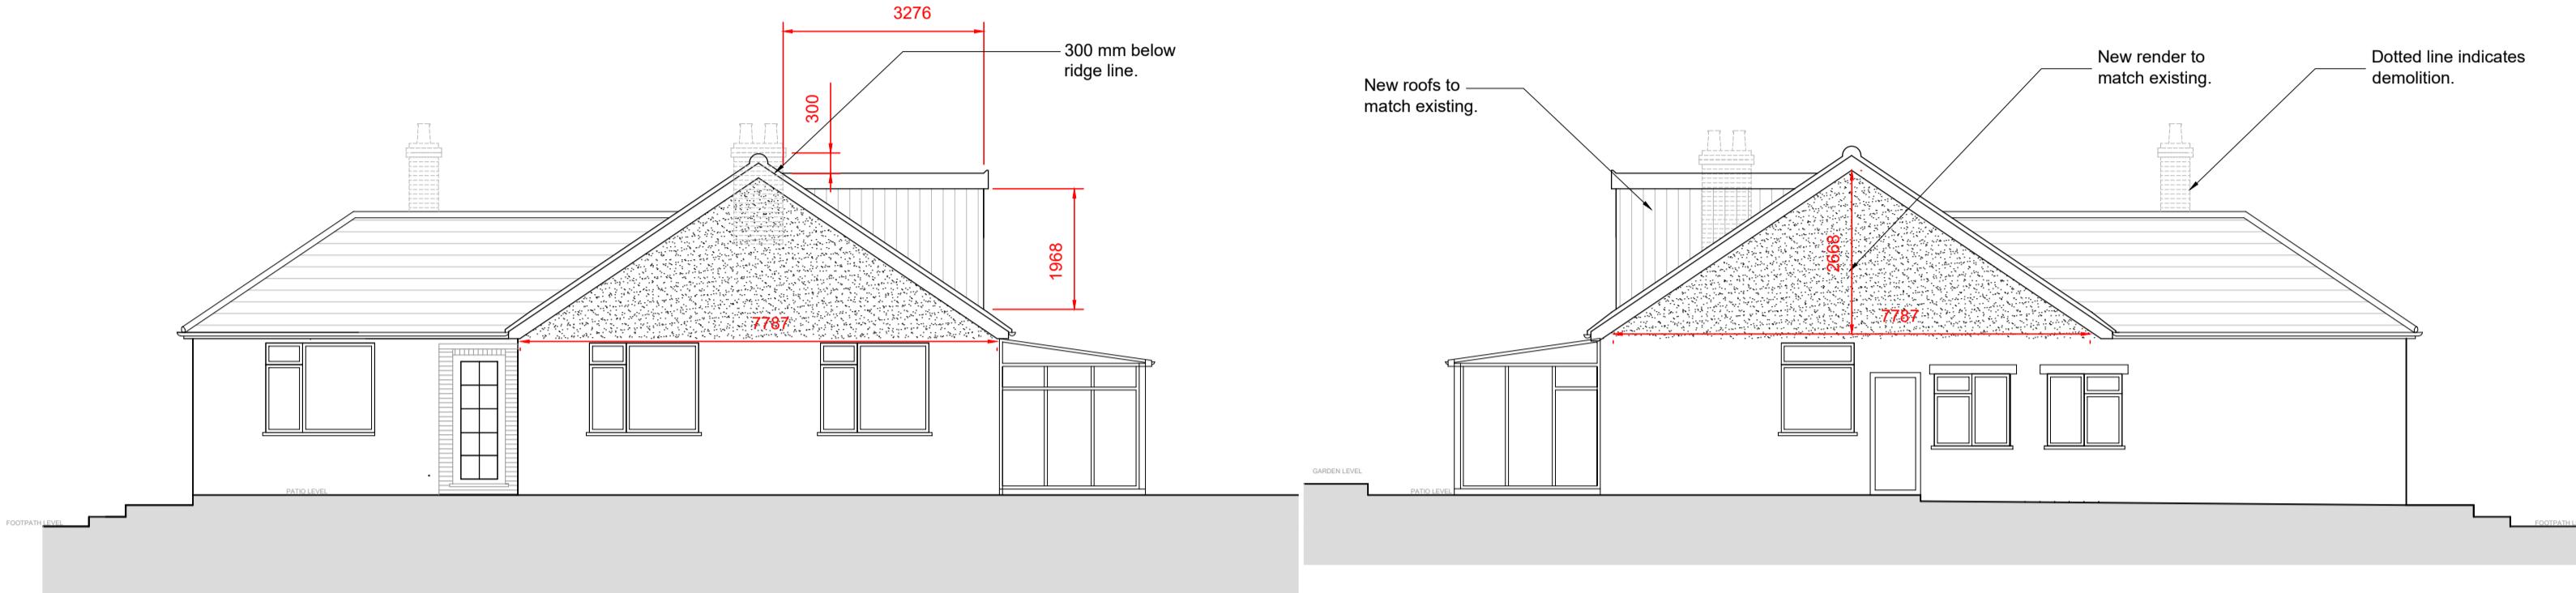
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V1 - Volume of gable =	$W \times H \times L/6$ $7.8 \times 2.7 \times 4/6 = 14 \text{ cm}^3$
V2 - Volume of gable =	$W \times H \times L/6$ $7.8 \times 2.7 \times 4/6 = 14 \text{ cm}^3$
V3 - Volume of rear dormer =	$W \times H \times L/2$ $6.5 \times 2.0 \times 3.3/2 = 21.5 \text{ cm}^3$



PROPOSED NORTH ELEVATION

SCALE 1 : 10




PROPOSED WEST ELEVATION

SCALE 1 : 100



PROPOSED EAST ELEVATION

SCALE 1 : 100

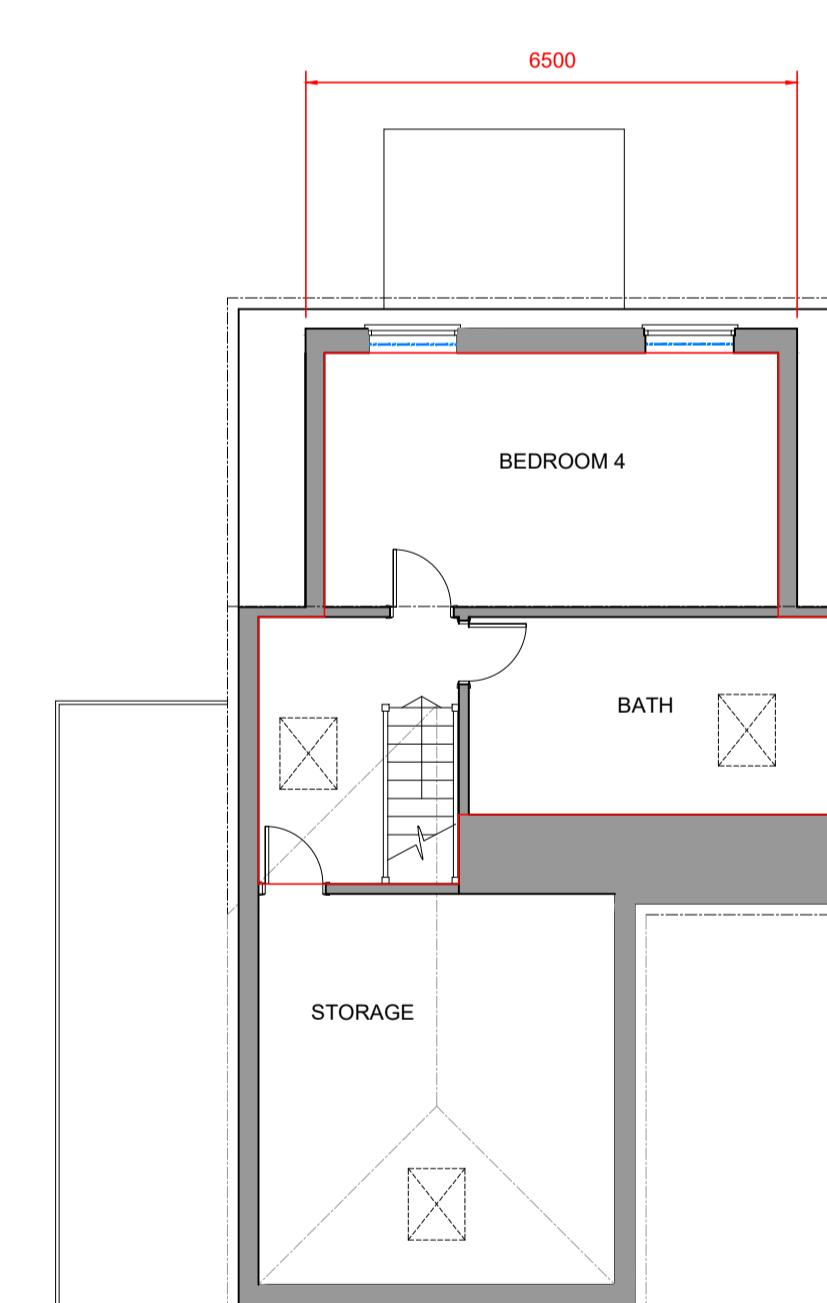

PROPOSED GROUND FLOOR PLAN

SCALE 1 : 10



SCALE 1 : 100

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Project: **LOFT CONVERSION.**

Location:
3 woodville gardens ruislip, HA4 7NB

Drawing Title:
PROPOSED PLANS AND ELEVATIONS

Date: JAN 2024 Sheet Size: A1 Drawn: SK

Drawing No:

Revision:

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