

NOTES


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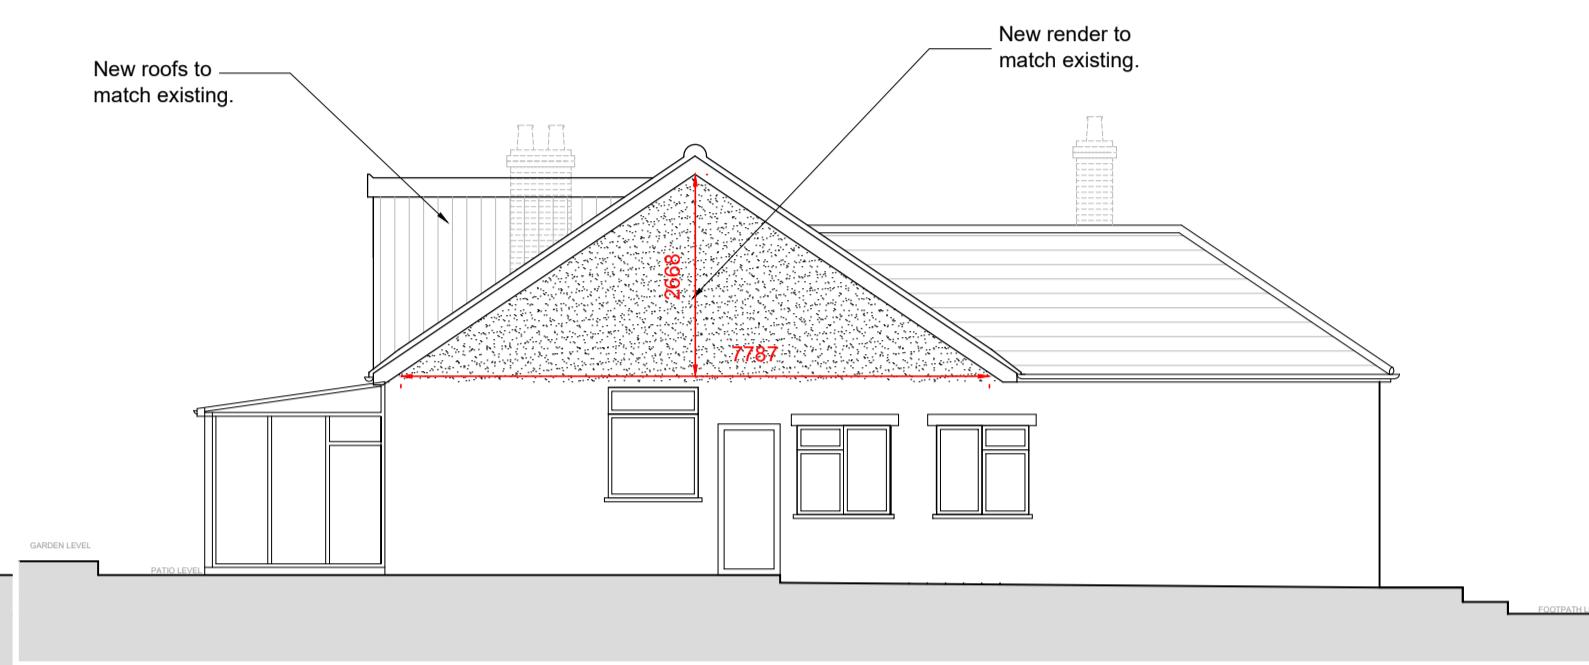
PROPOSED NORTH ELEVATION

SCALE 1 : 100




PROPOSED WEST ELEVATION

SCALE 1 : 100

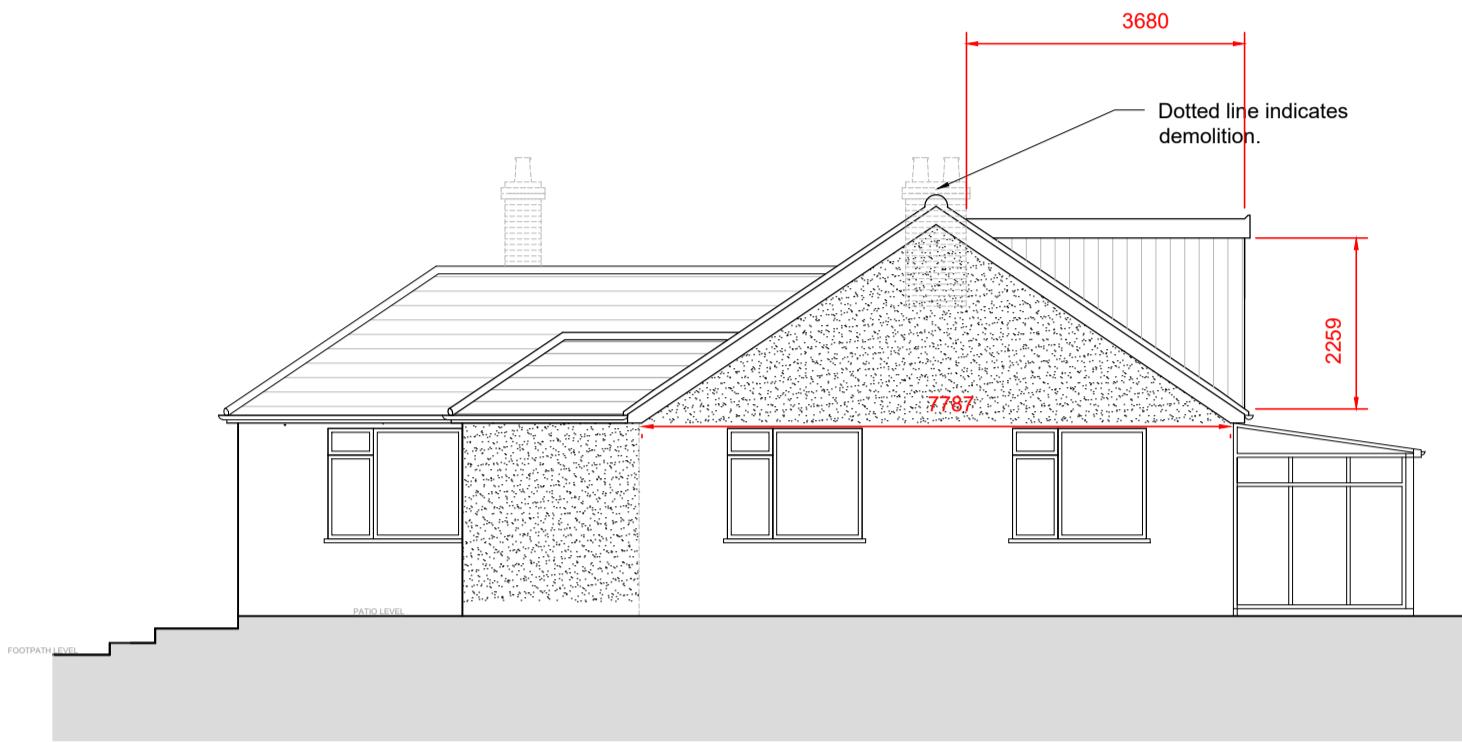


PROPOSED EAST ELEVATION

SCALE 1 : 100

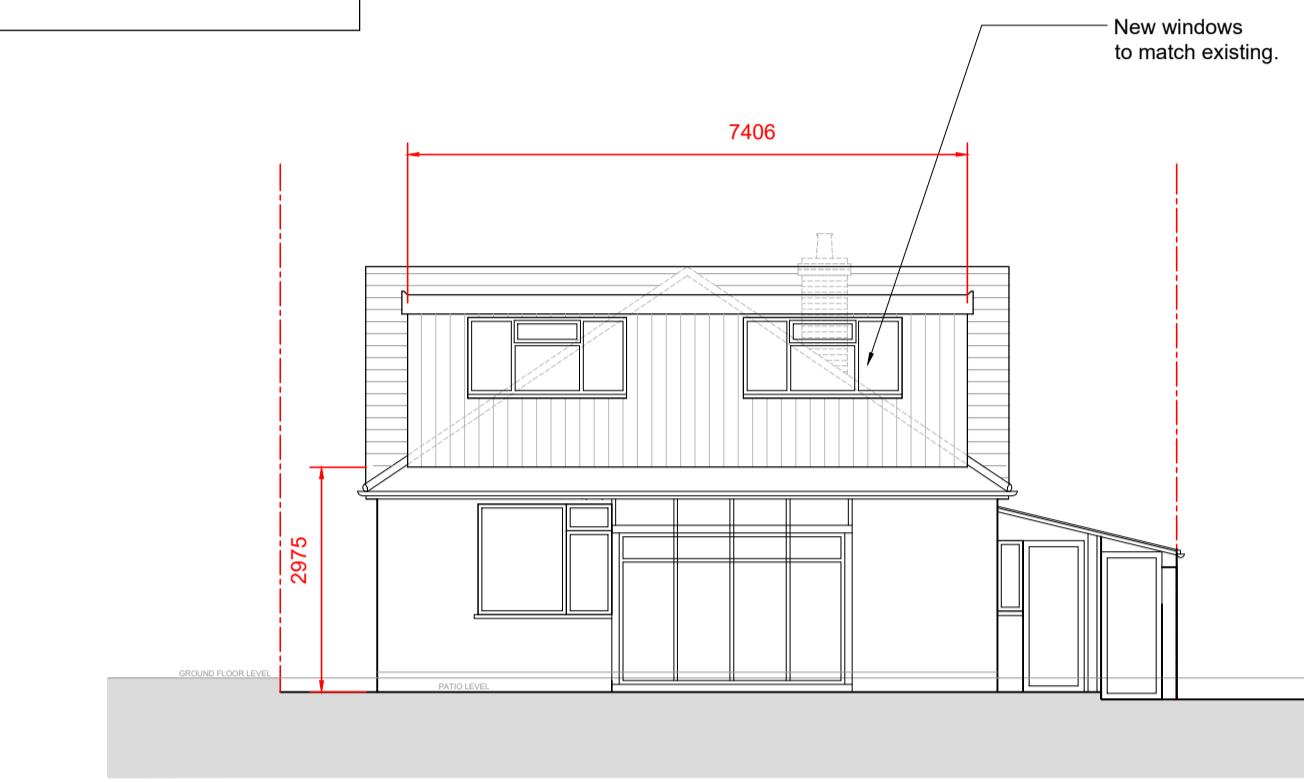


PROPOSED SOUTH ELEVATION

SCALE 1 : 100

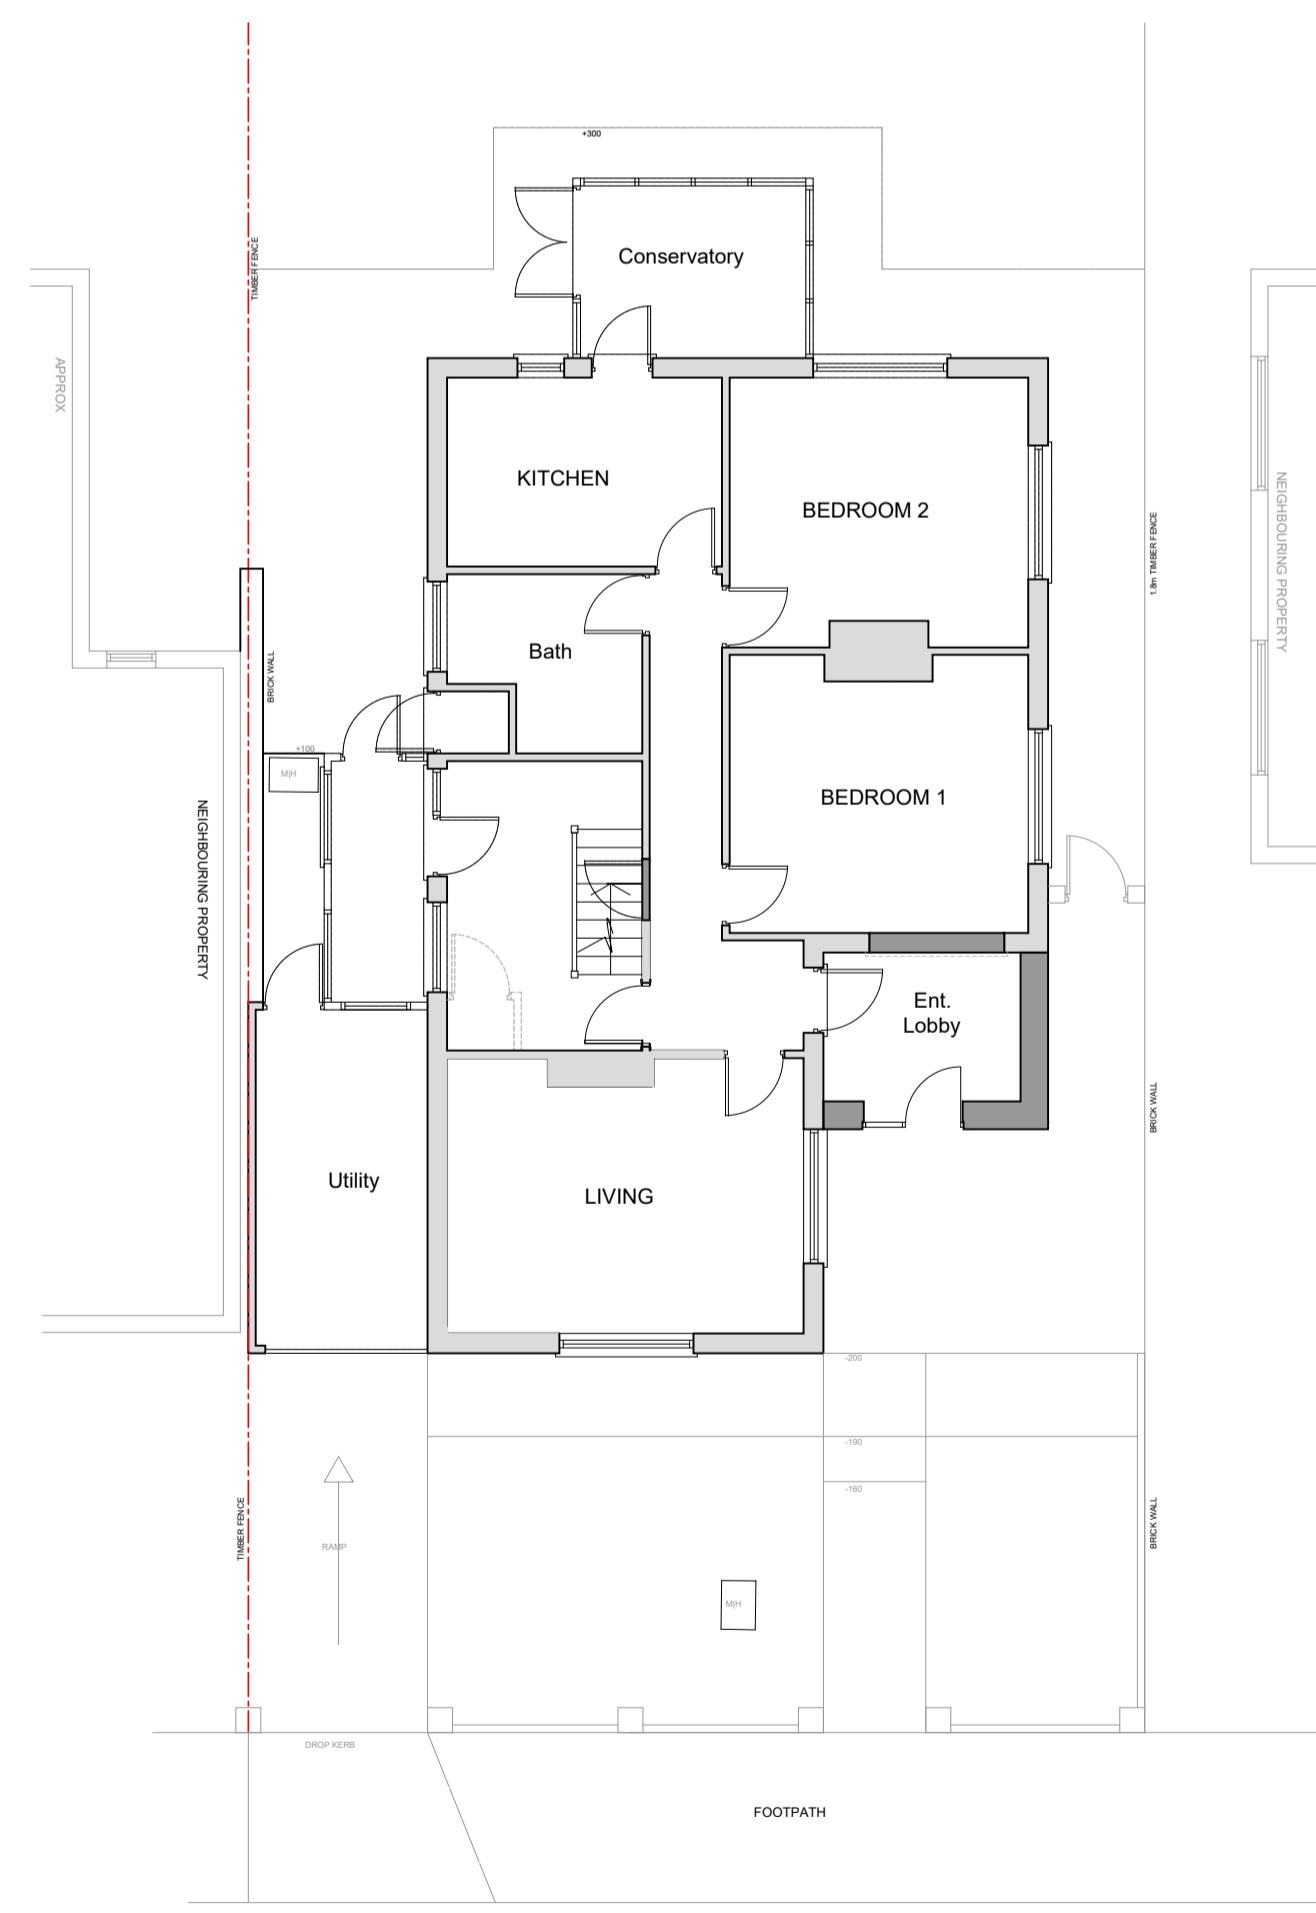

PROPOSED GROUND FLOOR PLAN

SCALE 1 : 100

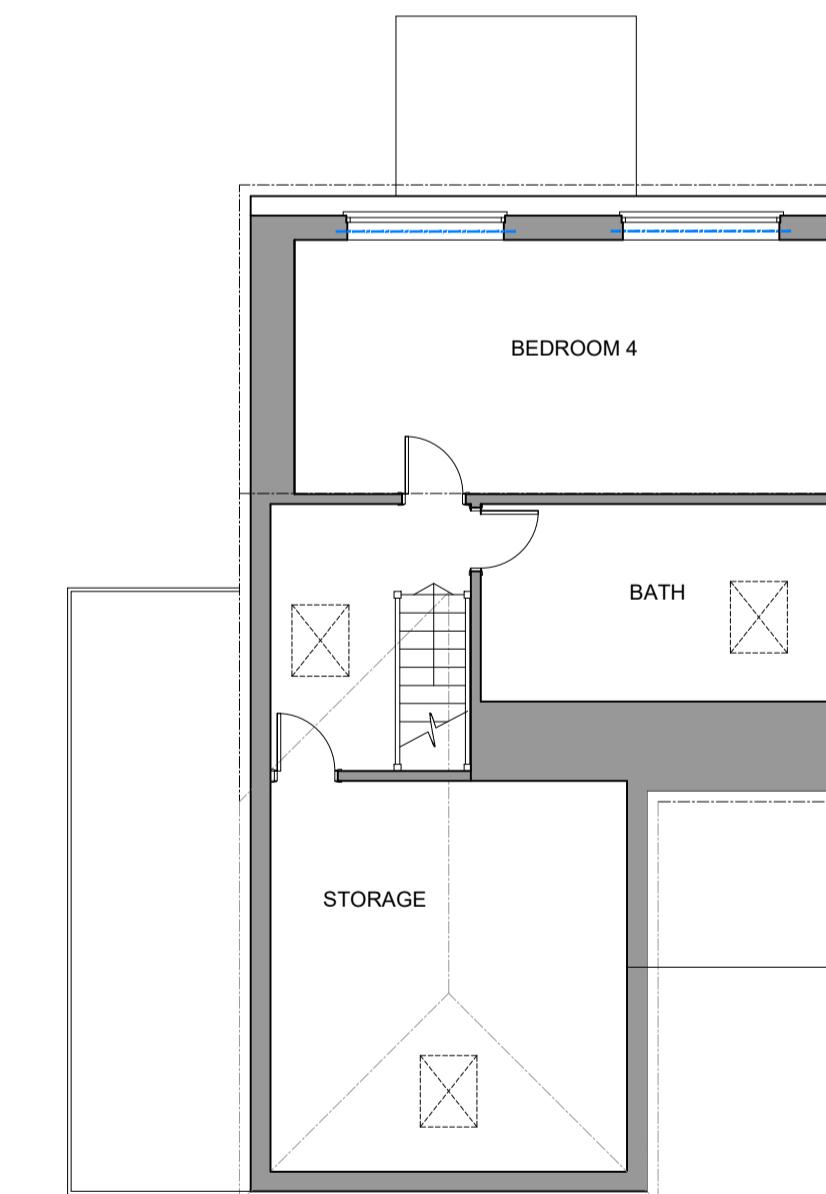

PROPOSED LOFT PLAN

SCALE 1 : 100

V1 - Volume of gable = $W \times H \times L/6$
 $7.8 \times 2.7 \times 4/6 = 14 \text{ cm}^3$
 V2 - Volume of gable = $W \times H \times L/6$
 $7.8 \times 2.7 \times 4/6 = 14 \text{ cm}^3$
 V3 - Volume of rear dormer = $W \times H \times L/2$
 $7.4 \times 2.3 \times 3.7/2 = 31.5 \text{ cm}^3$
 Total Volume = $V1 + V2 + V3 = 14 + 14 + 31.5 = 59.5 \text{ cm}^3$

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Client:
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Project:
 LOFT CONVERSION.

Location:
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Drawing Title:
 PROPOSED PLANS AND ELEVATIONS

Date: DEC 2023 Sheet Size: A1 Drawn: SK

Drawing No: P1432-03 Revision: ■