

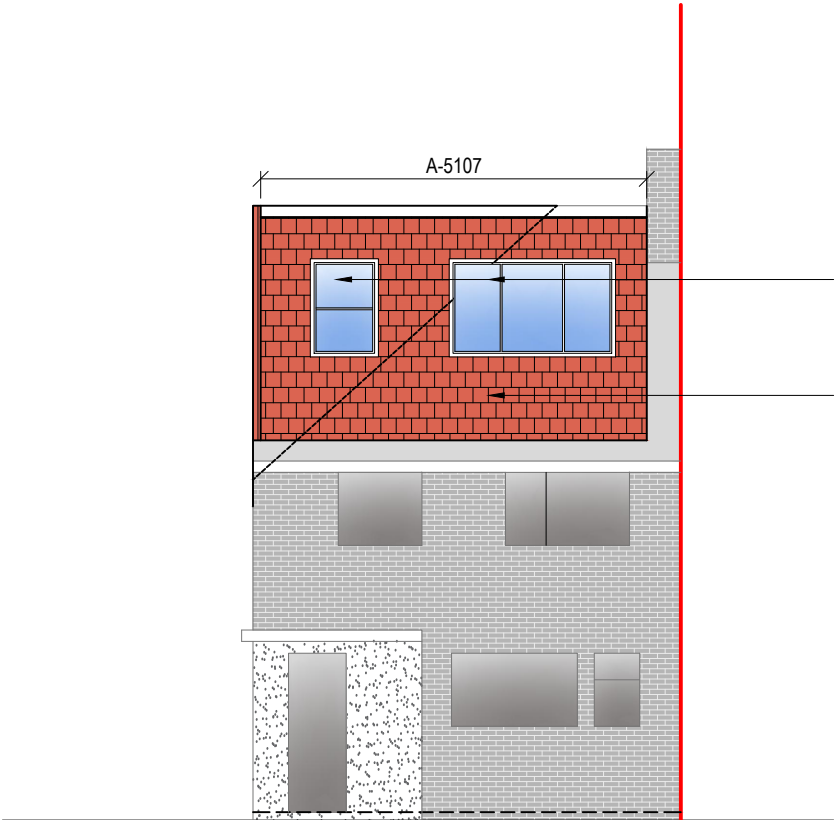



Front Elevation

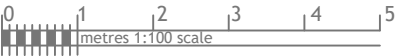

Rear Elevation

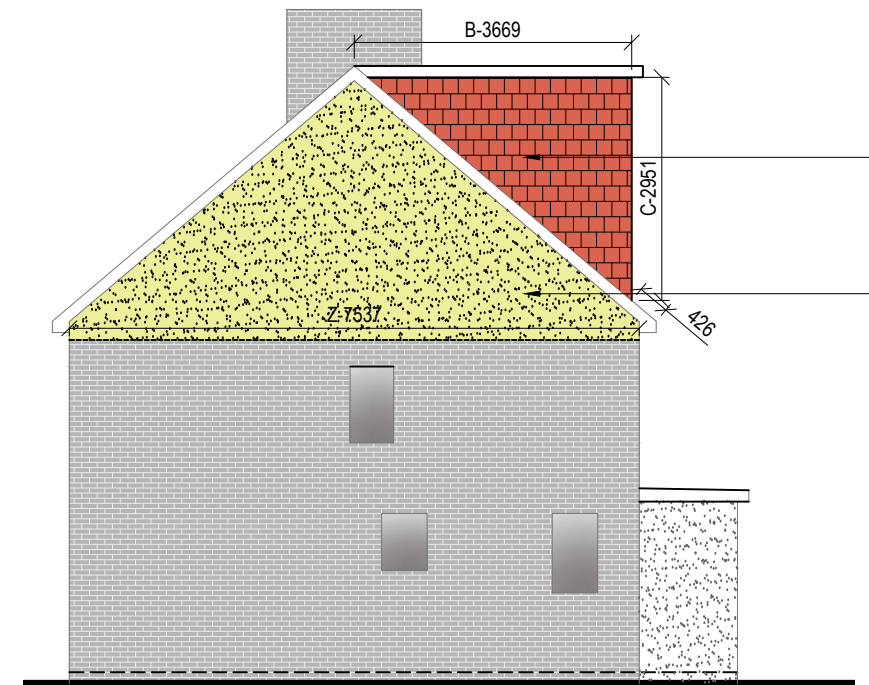

Side Elevation

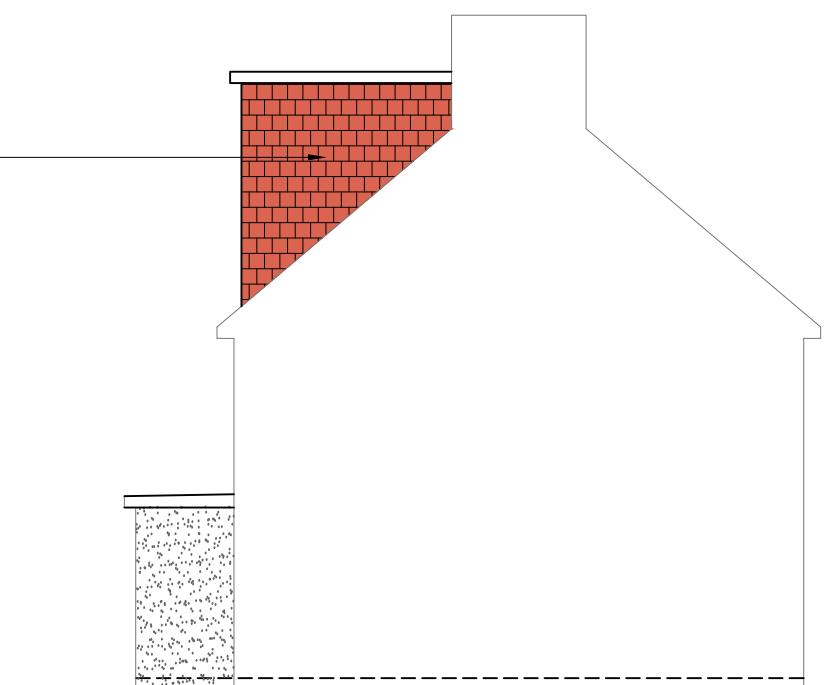

Side Elevation



VOLUME CALCULATION :-

1. HIP TO GABLE :-

$X-4.044 \times Y-3.623 \times Z-7.537 \times \frac{1}{6} = 18.40 \text{ M3}$

2. DORMER :-


$A-5.107 \times B-3.669 \times C-2.951 \times \frac{1}{2} = 27.64 \text{ M3}$

TOTAL :- $18.40 + 27.64 = 46.04 \text{ M3}$

NOTE:

ANY WINDOW INSERTED ON WALL OR ROOF SLOPE FORMING A SIDE ELEVATION OF THE DWELLING SHALL BE:

1. OBSECURE P GLAZED
2. NON- OPENING UNLESS THE PARTS OF THE WINDOW WHICH CAN BE OPENED ARE MORE THAN 1.7 METERS ABOVE THE FLOOR OF THE ROOM IN WHICH THE WINDOW IS INSTALLED.
3. ROOF WINDOW WILL NOT PROTRUDE MORE THAN 150MM

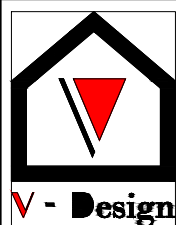

Dimensions to be verified on site
DO NOT SCALE FROM THIS DRAWING.
Any areas indicated on this drawing are for guidance only.
No responsibility is taken for their accuracy.

This drawing is the property of **V-DESIGN CAD Services Ltd** Copyright is reserved by them and the drawing is issued on the condition that it is not copied, reproduced, retained or disclosed to any unauthorized person, either wholly or in part without the consent in writing of **V-DESIGN CAD Services Ltd**

Email: vishal.p@vdesigncad.co.uk Mobile: 07971083395

Site Address:

15, Church Close,
Uxbridge,
UB8 2XG

Title:

Proposed Elevations


Scale: 1:100 Paper Size: A3

Drawn By: VP


Job Ref: 23130

Date: Oct 2023


Drawing No. LW - 04

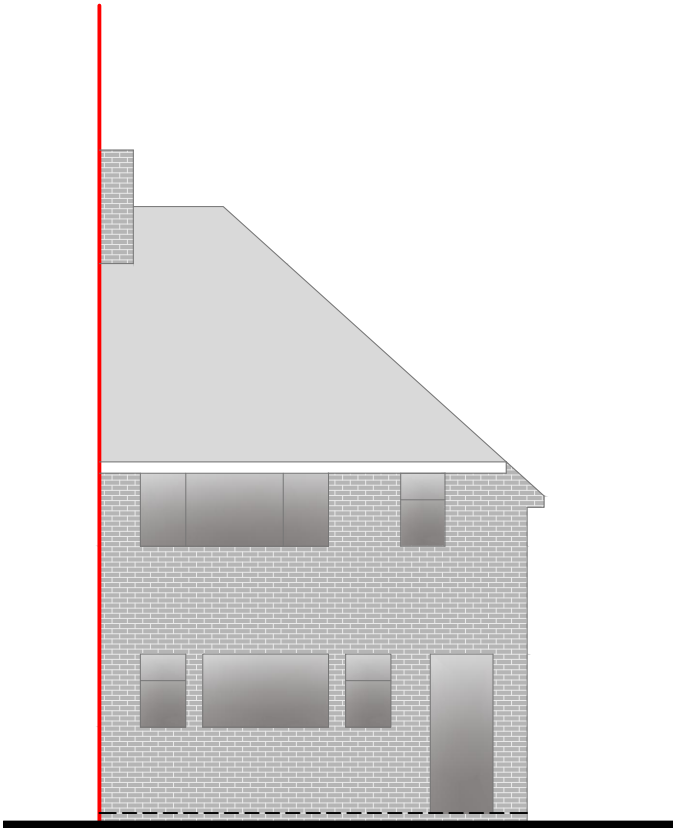


Front Elevation

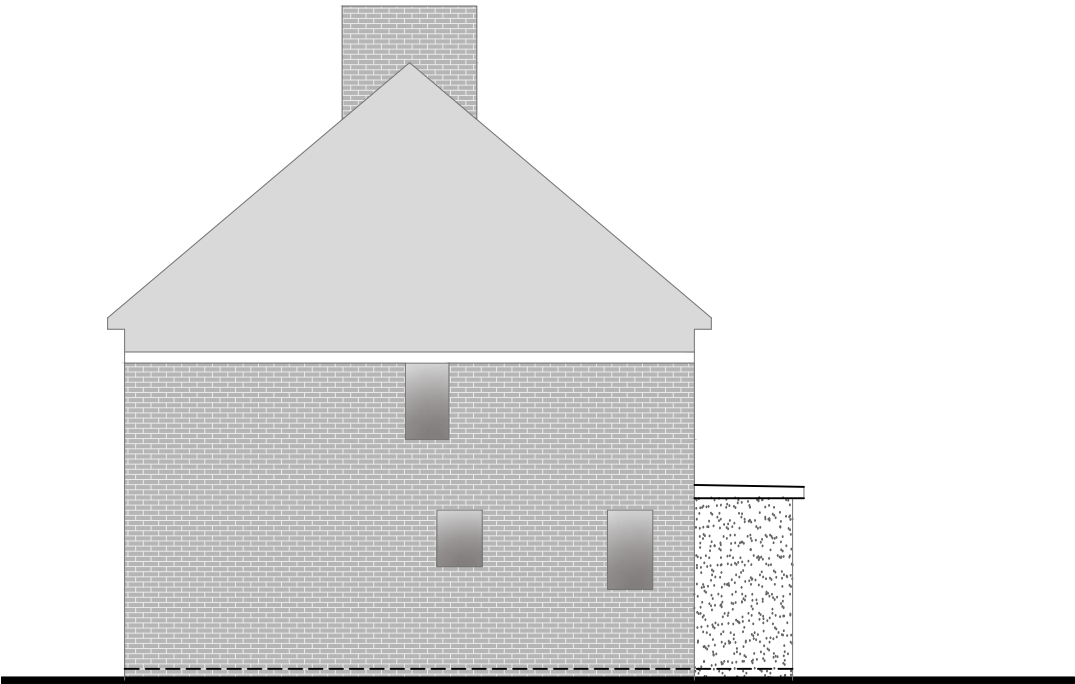

Side Elevation

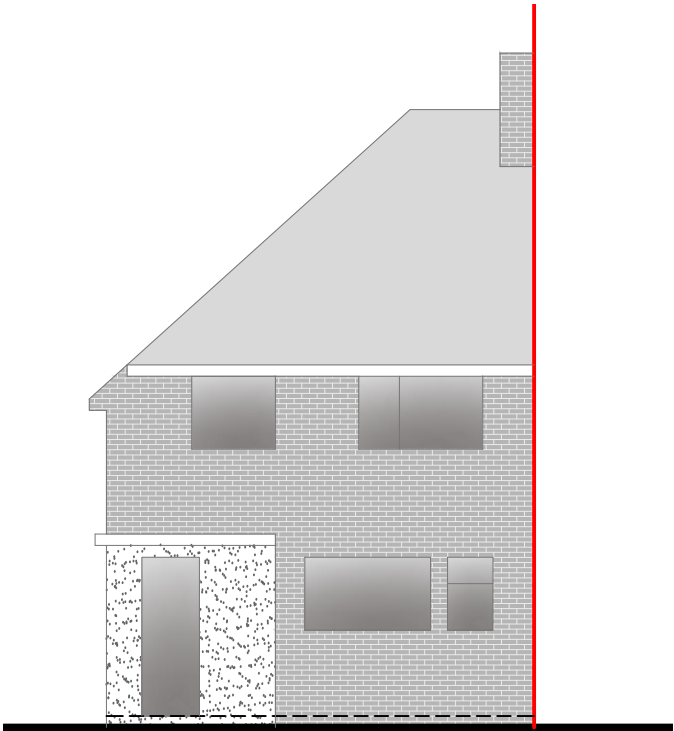


Rear Elevation

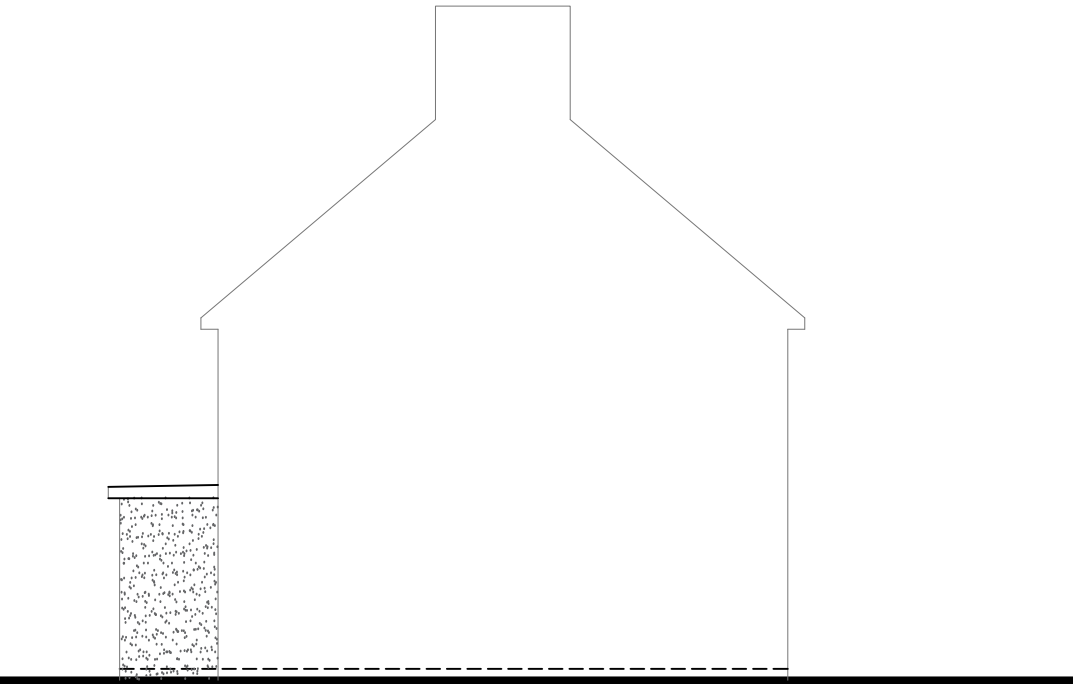

Side Elevation



Rev Date Comments

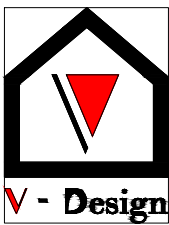


Dimensions to be verified on site
DO NOT SCALE FROM THIS DRAWING.
Any areas indicated on this drawing are for guidance only.
No responsibility is taken for their accuracy.


This drawing is the property of **V-DESIGN CAD Services Ltd** Copyright is reserved by them and the drawing is issued on the condition that it is not copied, reproduced, retained or disclosed to any unauthorized person, either wholly or in part without the consent in writing of **V-DESIGN CAD Services Ltd**

Email: vishal.p@vdesigncad.co.uk Mobile: 07971083395


Site Address:		Title:		Drawn By: VP	
15, Church Close, Uxbridge, UB8 2XG		Existing Elevations		Job Ref: 23130	
		Scale:	1:100	Paper Size:	A3
				Date:	Oct 2023
				Drawing No.	LW - 03

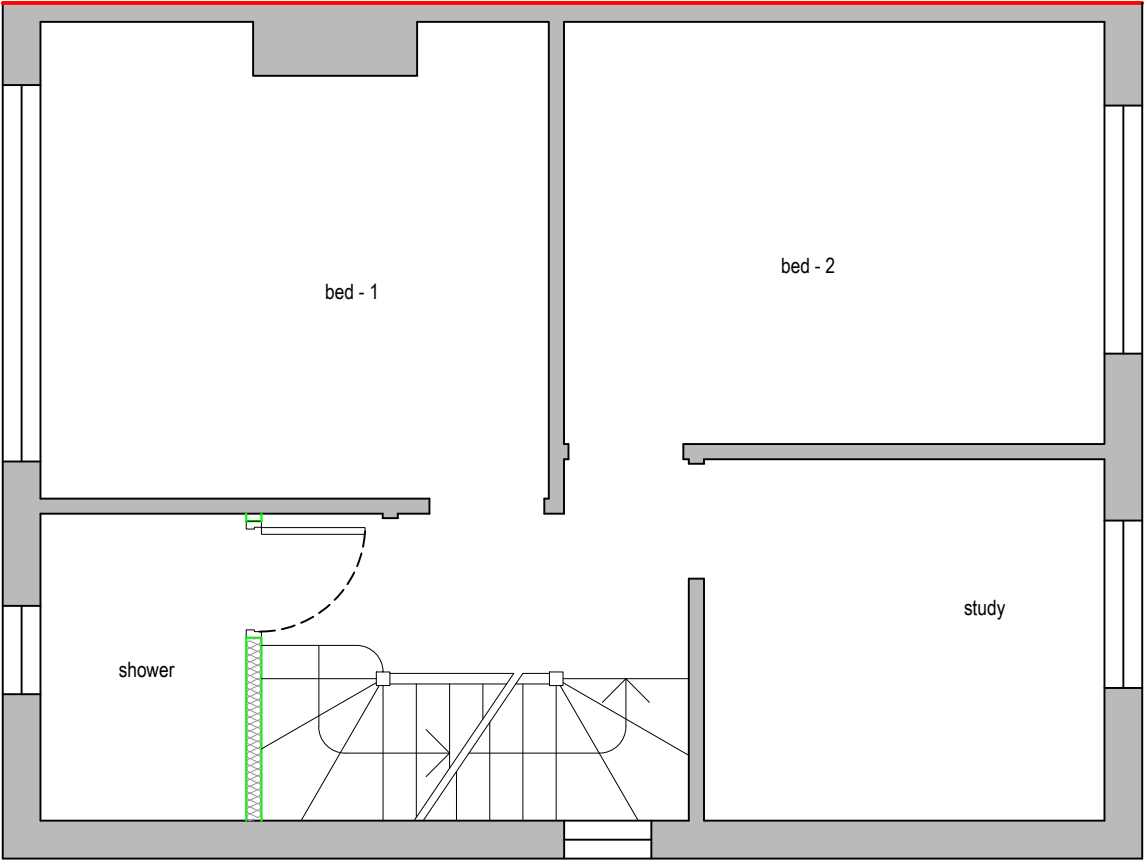

Proposed First Floor Plan

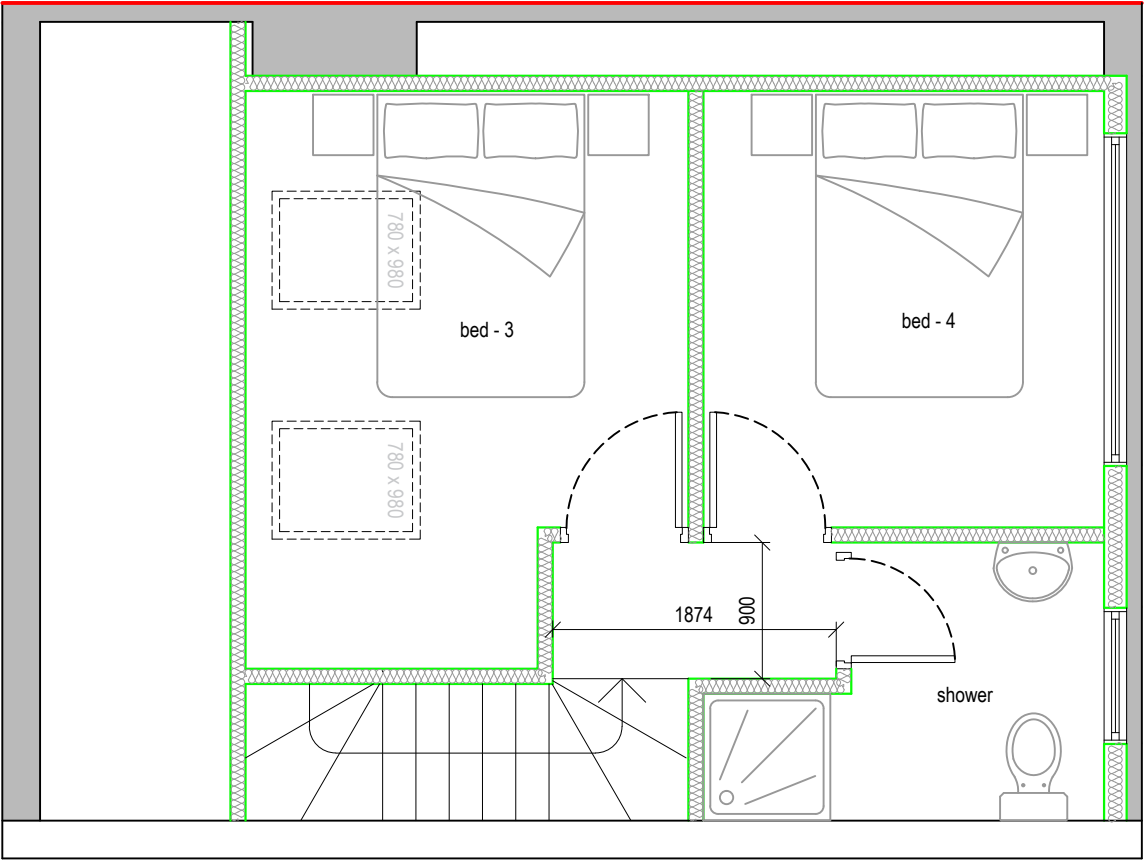

Proposed Loft Floor Plan

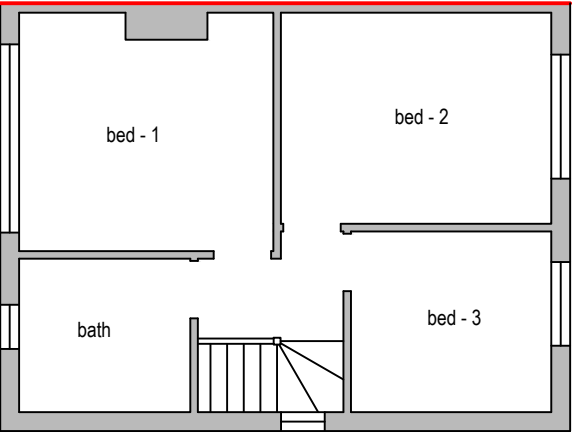

Existing First Floor Plan



Dimensions to be verified on site
DO NOT SCALE FROM THIS DRAWING.
Any areas indicated on this drawing are for guidance only.
No responsibility is taken for their accuracy.

This drawing is the property of **V-DESIGN CAD Services Ltd**. Copyright is reserved by them and the drawing is issued on the condition that it is not copied, reproduced, retained or disclosed to any unauthorized person, either wholly or in part without the consent in writing of **V-DESIGN CAD Services Ltd**.

Email: vishal.p@vdesigncad.co.uk Mobile: 07971083395

Site Address:

15, Church Close,
Uxbridge,
UB8 2XG

Title:

Existing First Floor Plan

Proposed First & Loft Floor Plans

Scale:

1:100, 1:50

Paper Size:

A3

Rev Date Comments

Drawn By: VP

Job Ref: 23130

Date: Oct 2023


Drawing No. LW - 02



Block Plan



Site Location

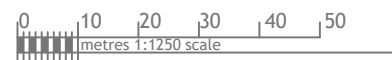

Rev Date Comments



Dimensions to be verified on site
DO NOT SCALE FROM THIS DRAWING.
Any areas indicated on this drawing are for guidance only.
No responsibility is taken for their accuracy.

This drawing is the property of **V-DESIGN CAD Services Ltd** Copyright is reserved by them and the drawing is issued on the condition that it is not copied, reproduced, retained or disclosed to any unauthorized person, either wholly or in part without the consent in writing of **V-DESIGN CAD Services Ltd**

Email: vishal.p@vdesigncad.co.uk Mobile: 07971083395

Site Address:

15, Church Close,
Uxbridge,
UB8 2XG

Title:


Block and Location Plans

Scale:

1:500, 1:1250

Paper Size:

A3

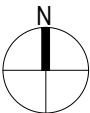

Drawn By: VP

Job Ref: 23130

Date: Oct 2023

Drawing No. LW - 01