



**Existing Ground Floor Plan**  
Scale 1:100



**Existing First Floor Plan**  
Scale 1:100

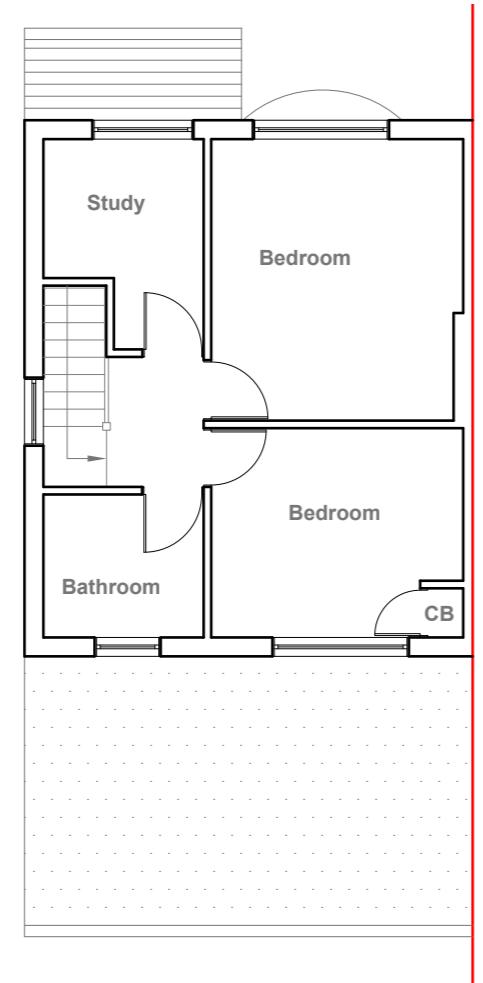


**Existing Front Elevation**  
Scale 1:100

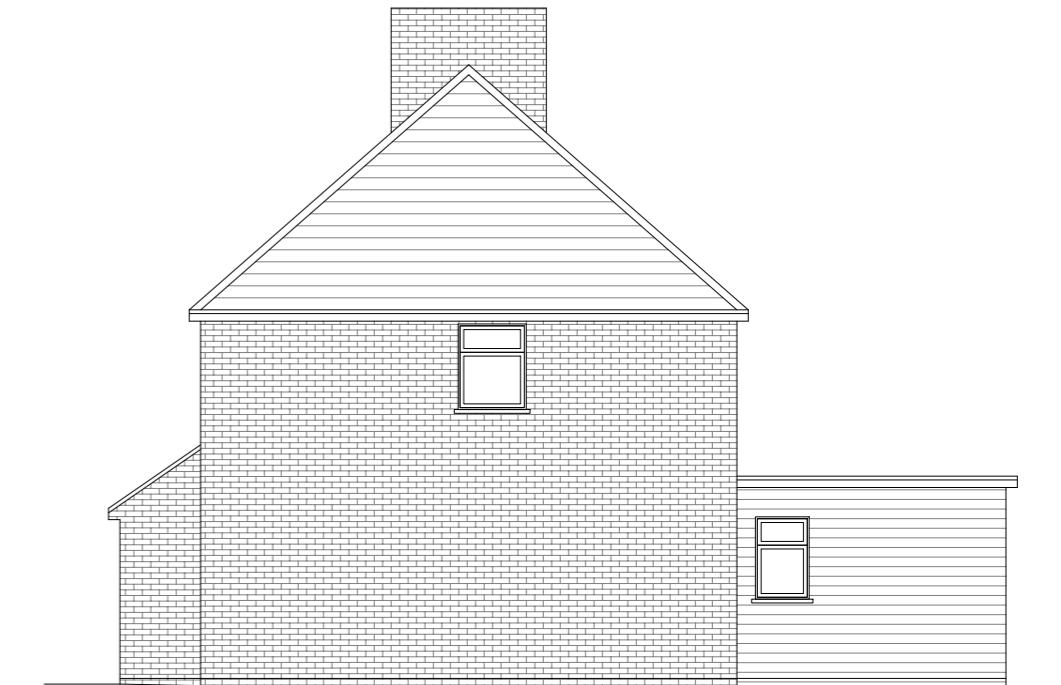

**Existing Side Elevation**  
Scale 1:100



**Existing Rear Elevation**  
Scale 1:100

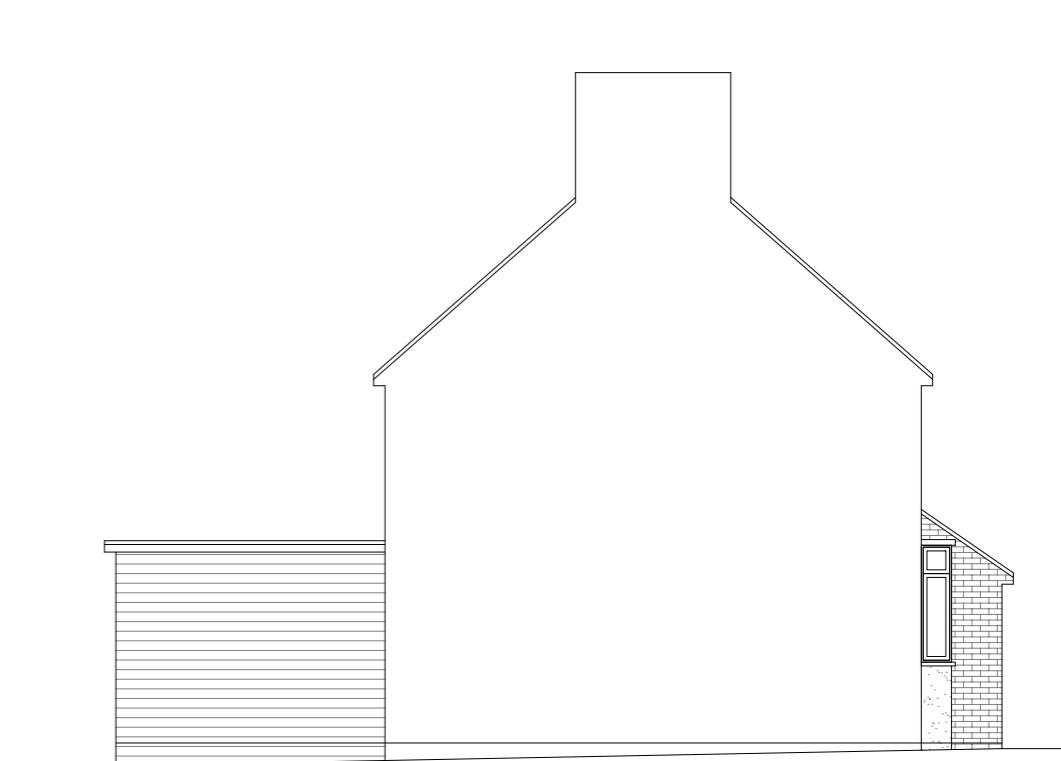

**Existing Side Elevation**  
Scale 1:100

GENERAL NOTES:  
 1. ALL DIMENSIONS ARE IN MILLIMETER.  
 2. VERIFY ALL DIMENSIONS AND CONDITIONS BEFORE BUILDING OR  
 STARTING CONSTRUCTION. NOTIFY THE DESIGNER IMMEDIATELY OF ANY  
 DISCREPANCY OR VARIATION.  
 3. ALL WORK TO COMPLY WITH CURRENT BUILDING REGULATIONS  
 AND CODES OF PRACTICE

Title:

## Existing Floor Plans & Elevations


1:100 0 1 2 5 10 Meter

Site Address  
18 Lancaster Walk,  
Hayes. Middx.  
UB3 2QL

Scale: 1:100 @A3  
Date: 02/11/2024  
Drawing No.:  
2024/193 -01  
Drawn By:  
RO


Revision Date:  
\_\_\_\_\_  
\_\_\_\_\_  
\_\_\_\_\_  
e:mail -  
faluckpatel@yahoo.com  
(M) +44 (0) 7871 466 254

**Faluck Patel**

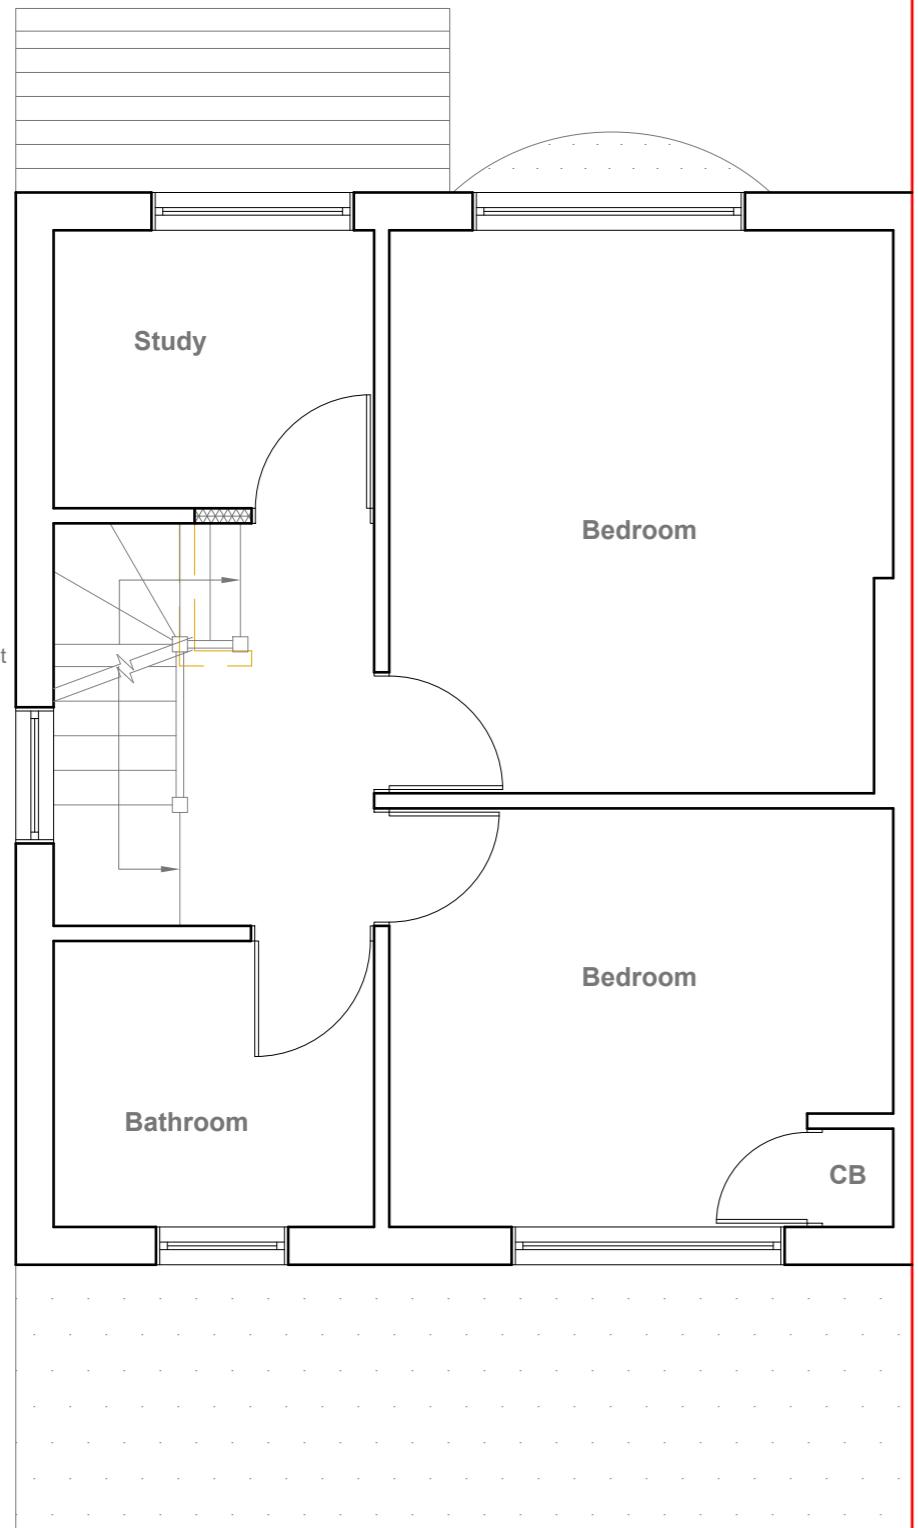

**Proposed First Floor Plan**

Scale 1:50

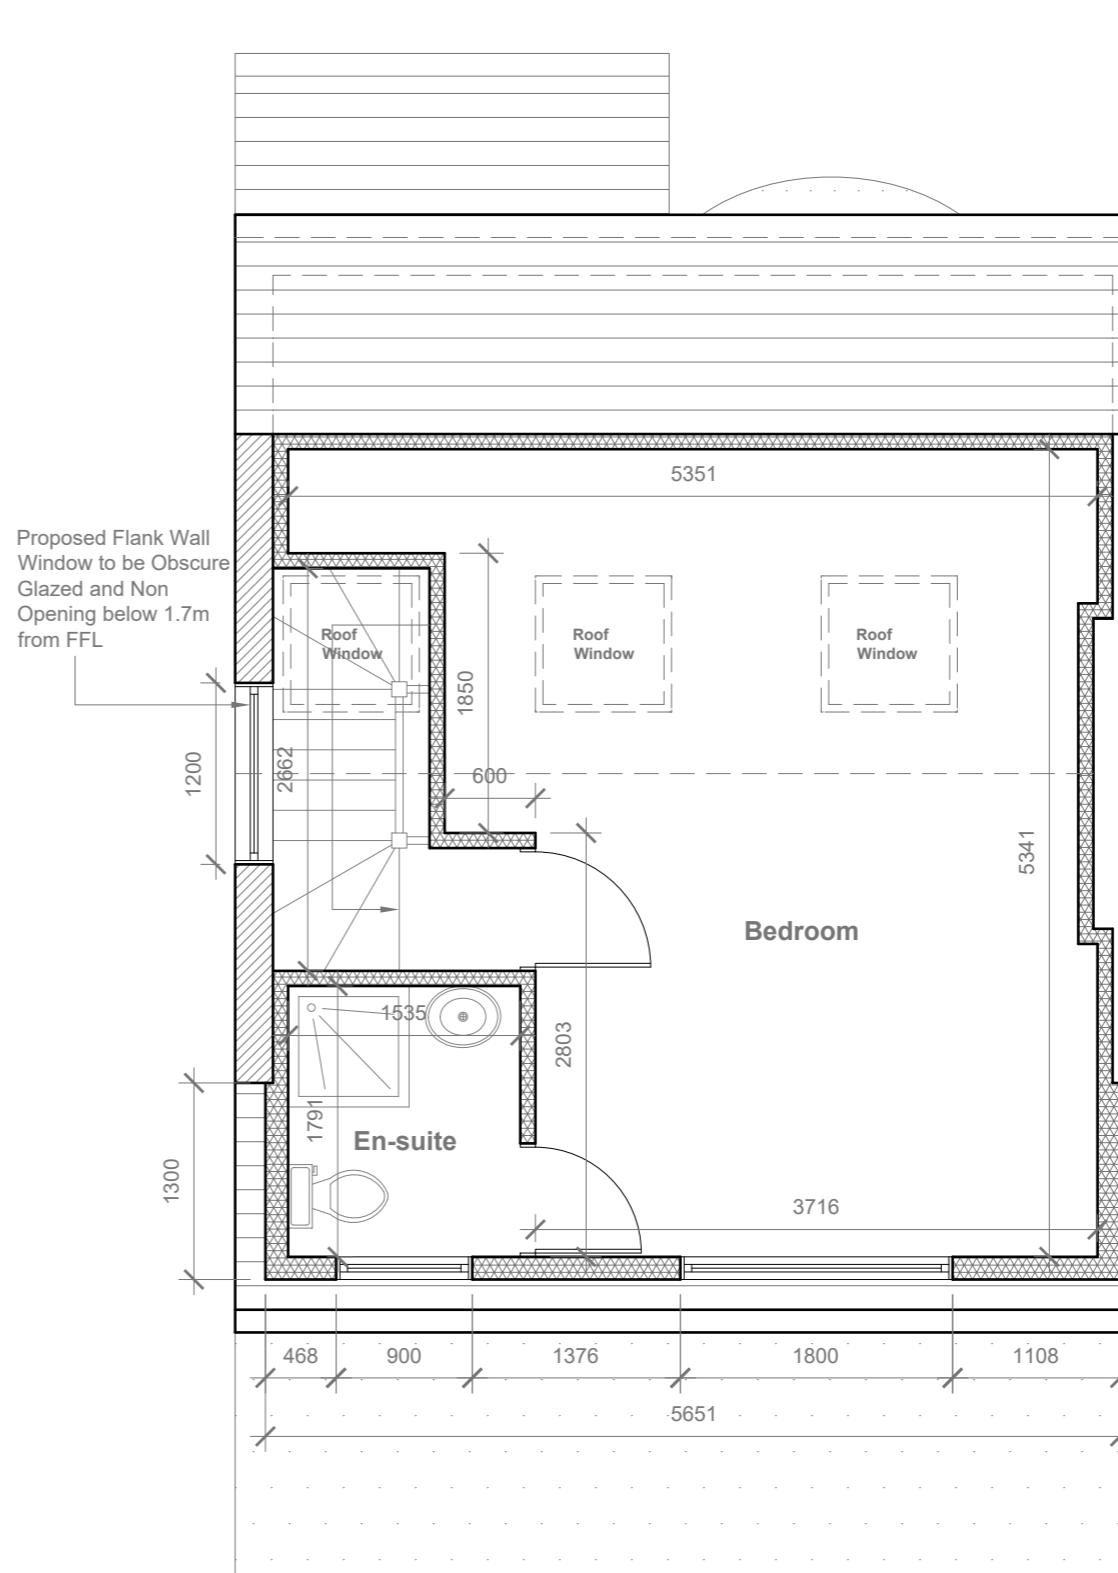

**Proposed Loft Floor Plan**

Scale 1:50

**GENERAL NOTES:**

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2. VERIFY ALL DIMENSIONS AND CONDITIONS BEFORE BUILDING OR STARTING CONSTRUCTION. NOTIFY THE DESIGNER IMMEDIATELY OF ANY DISCREPANCY OR VARIATION.
3. ALL WORK TO COMPLY WITH CURRENT BUILDING REGULATIONS AND CODES OF PRACTICE

**Title:**

## Proposed First Floor & Loft Plans

**Site Address**

18 Lancaster Walk,  
Hayes. Middx.  
UB3 2QL


**Scale: 1:50 @A3**  
Date: 02/11/2024

**Revision Date:**  
Drawing No.: 2024/193 -02


Drawn By:  
e:mail - faluckpatel@yahoo.com  
(M) +44 (0) 7871 466 254  
RO




**Proposed Front Elevation**  
Scale 1:100

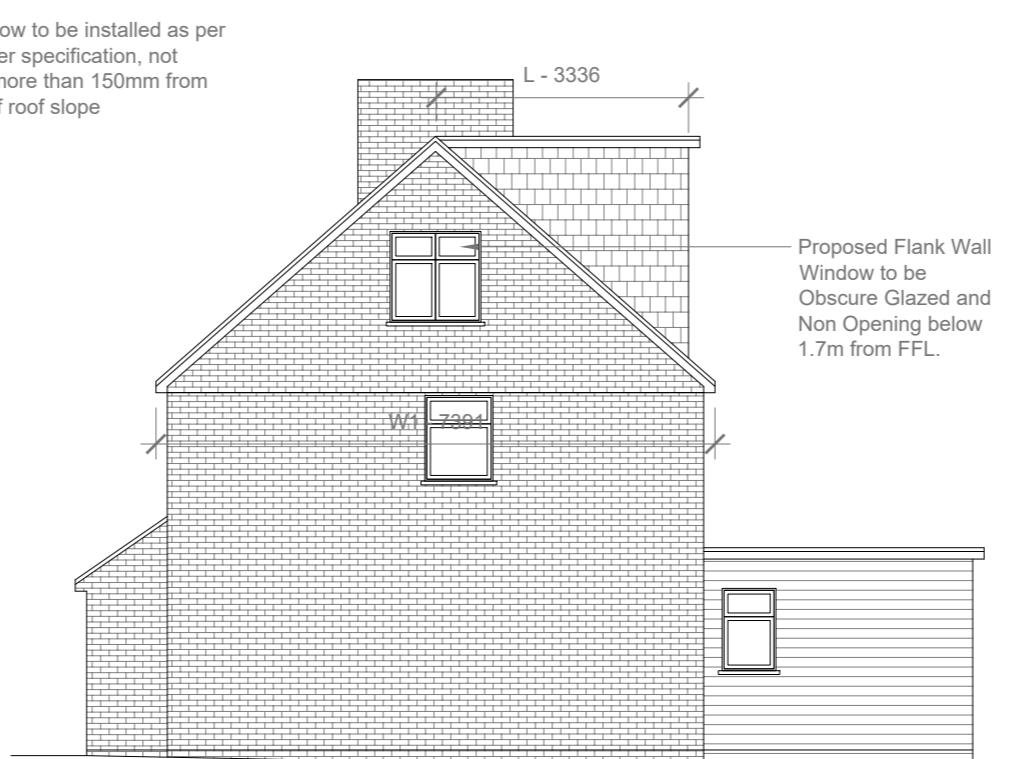

**Proposed Side Elevation**  
Scale 1:100

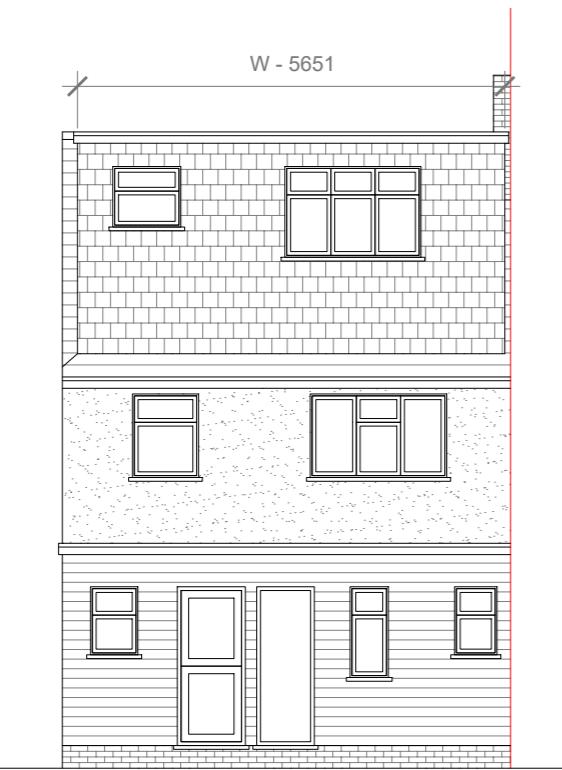

**Proposed Rear Elevation**  
Scale 1:100

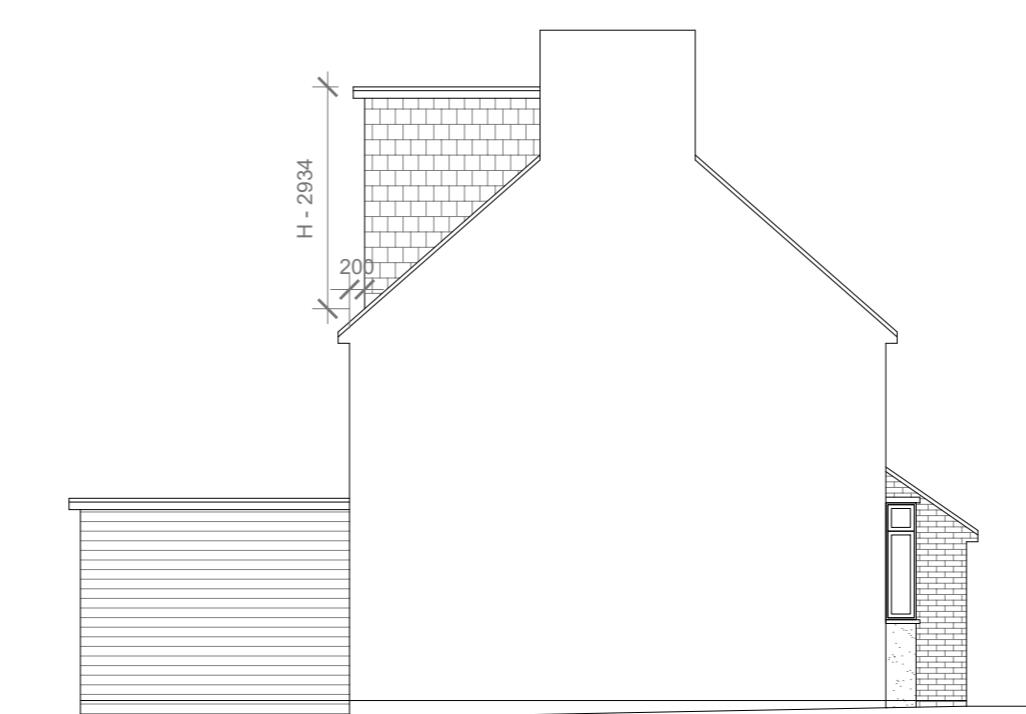

**Proposed Side Elevation**  
Scale 1:100

REAR DORMER VOLUME =

V1 =

W X H X L / 2  
5.651 X 2.934 X 3.336 / 2  
55.31 / 2  
27.65 CU.MT.

HIP TO GABLE ROOF VOLUME =

V2 =

W1 X H1 X L1 / 6  
7.391 X 3.391 X 3.545 / 6  
88.84 / 6  
14.80 CU.MT.

TOTAL ROOF VOLUME =

V1 + V2  
27.65 + 14.80  
42.45 CU.MT. < 50.00 CU.MT



GENERAL NOTES:  
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STARTING CONSTRUCTION. NOTIFY THE DESIGNER IMMEDIATELY OF ANY  
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3. ALL WORK TO COMPLY WITH CURRENT BUILDING REGULATIONS  
AND CODES OF PRACTICE

Title:

## Proposed Elevations

Site Address

18 Lancaster Walk,  
Hayes. Middx.  
UB3 2QL

Scale: 1:100 @A3

Date: 02/11/2024  
Drawing No.: 2024/193 -03

Revision Date:

Drawn By:  
RO

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**Faluck Patel**