




Proposed ground floor plan

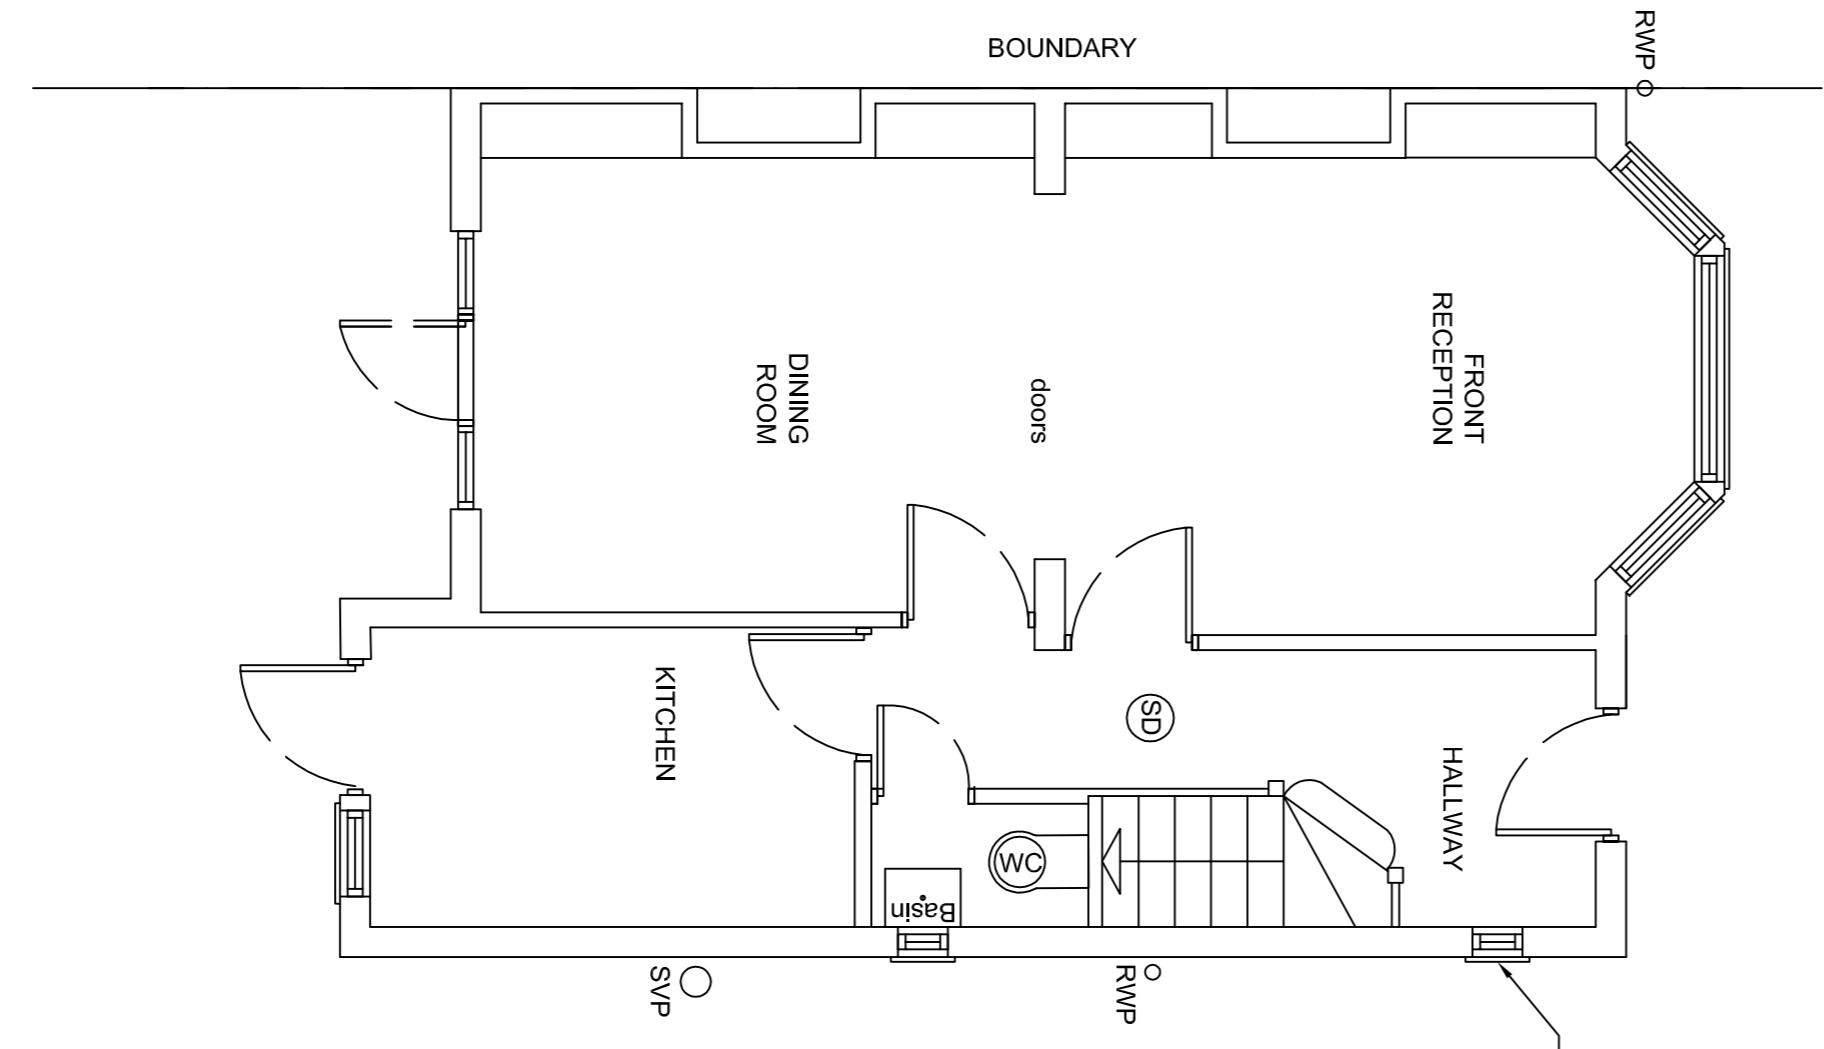


Proposed first floor plan

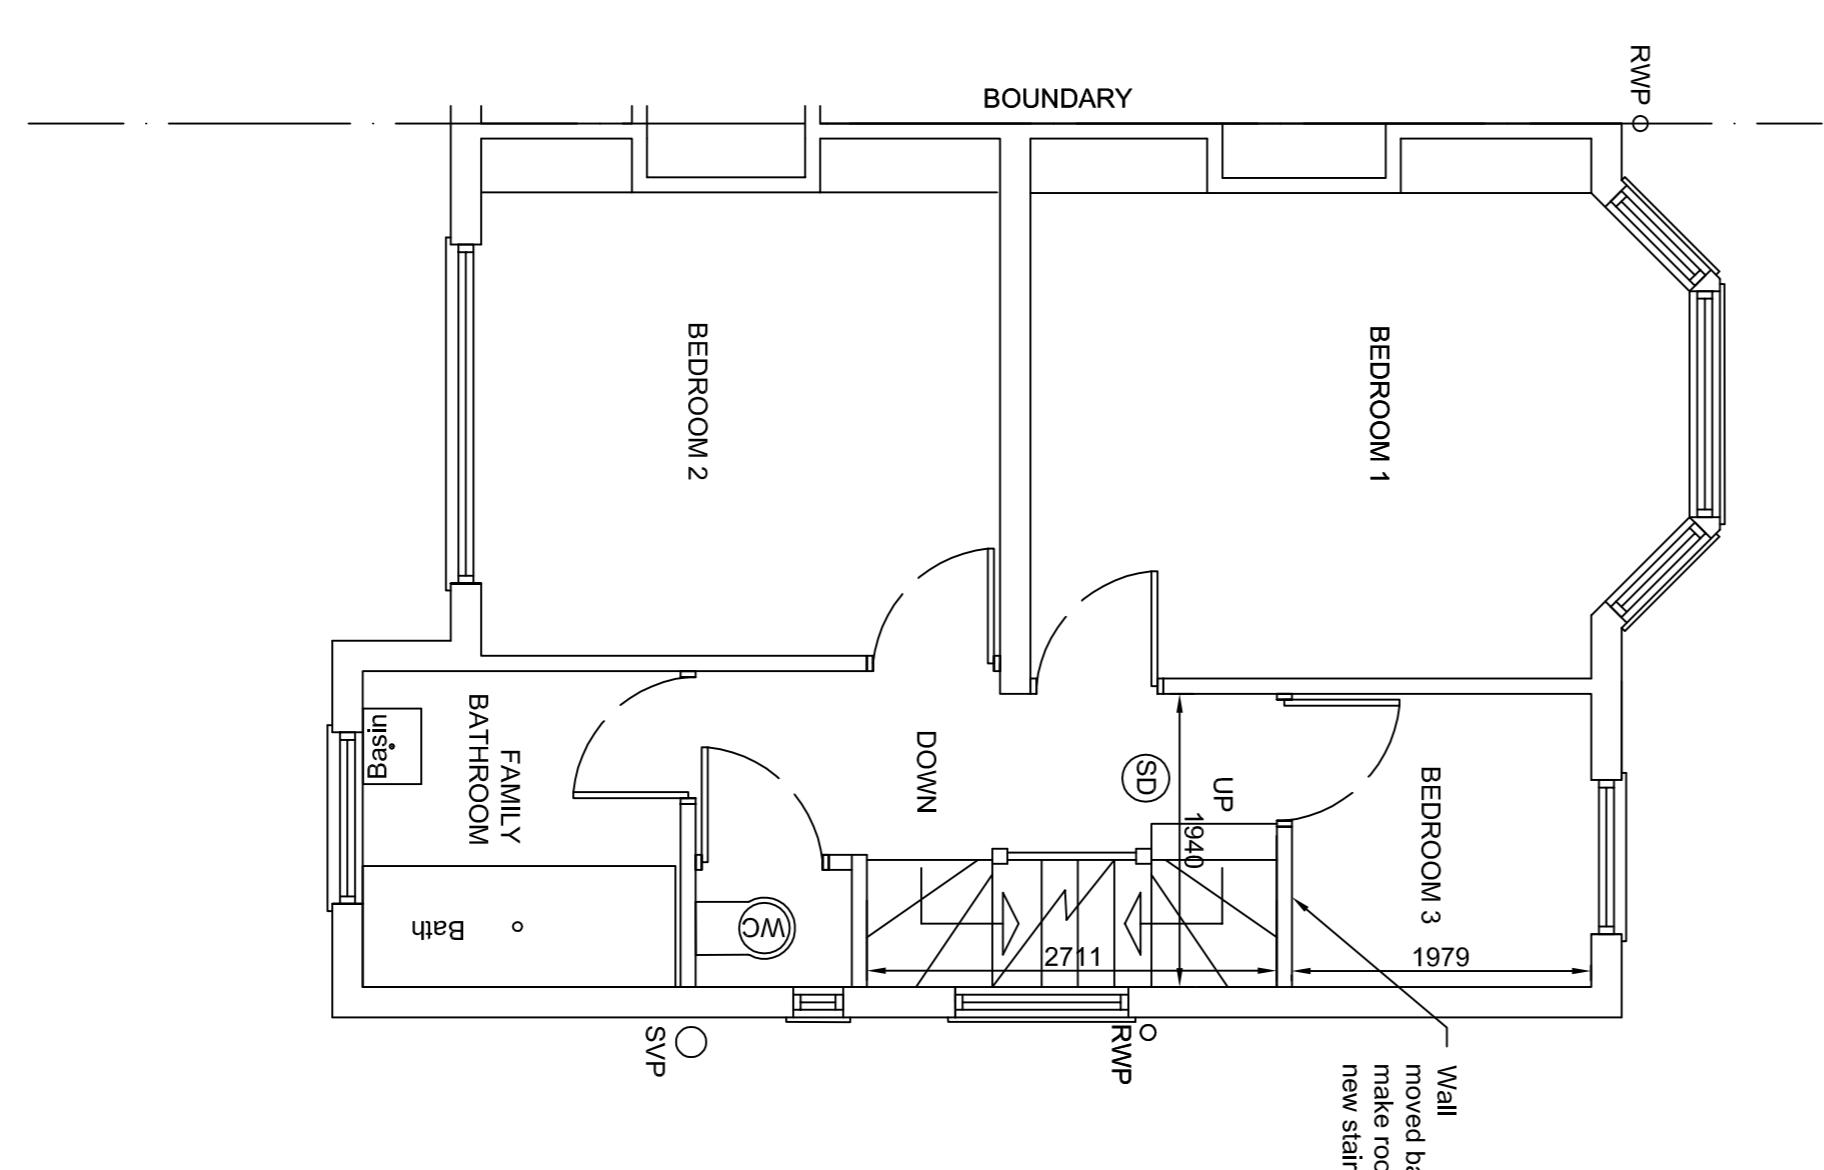


Proposed loft plan

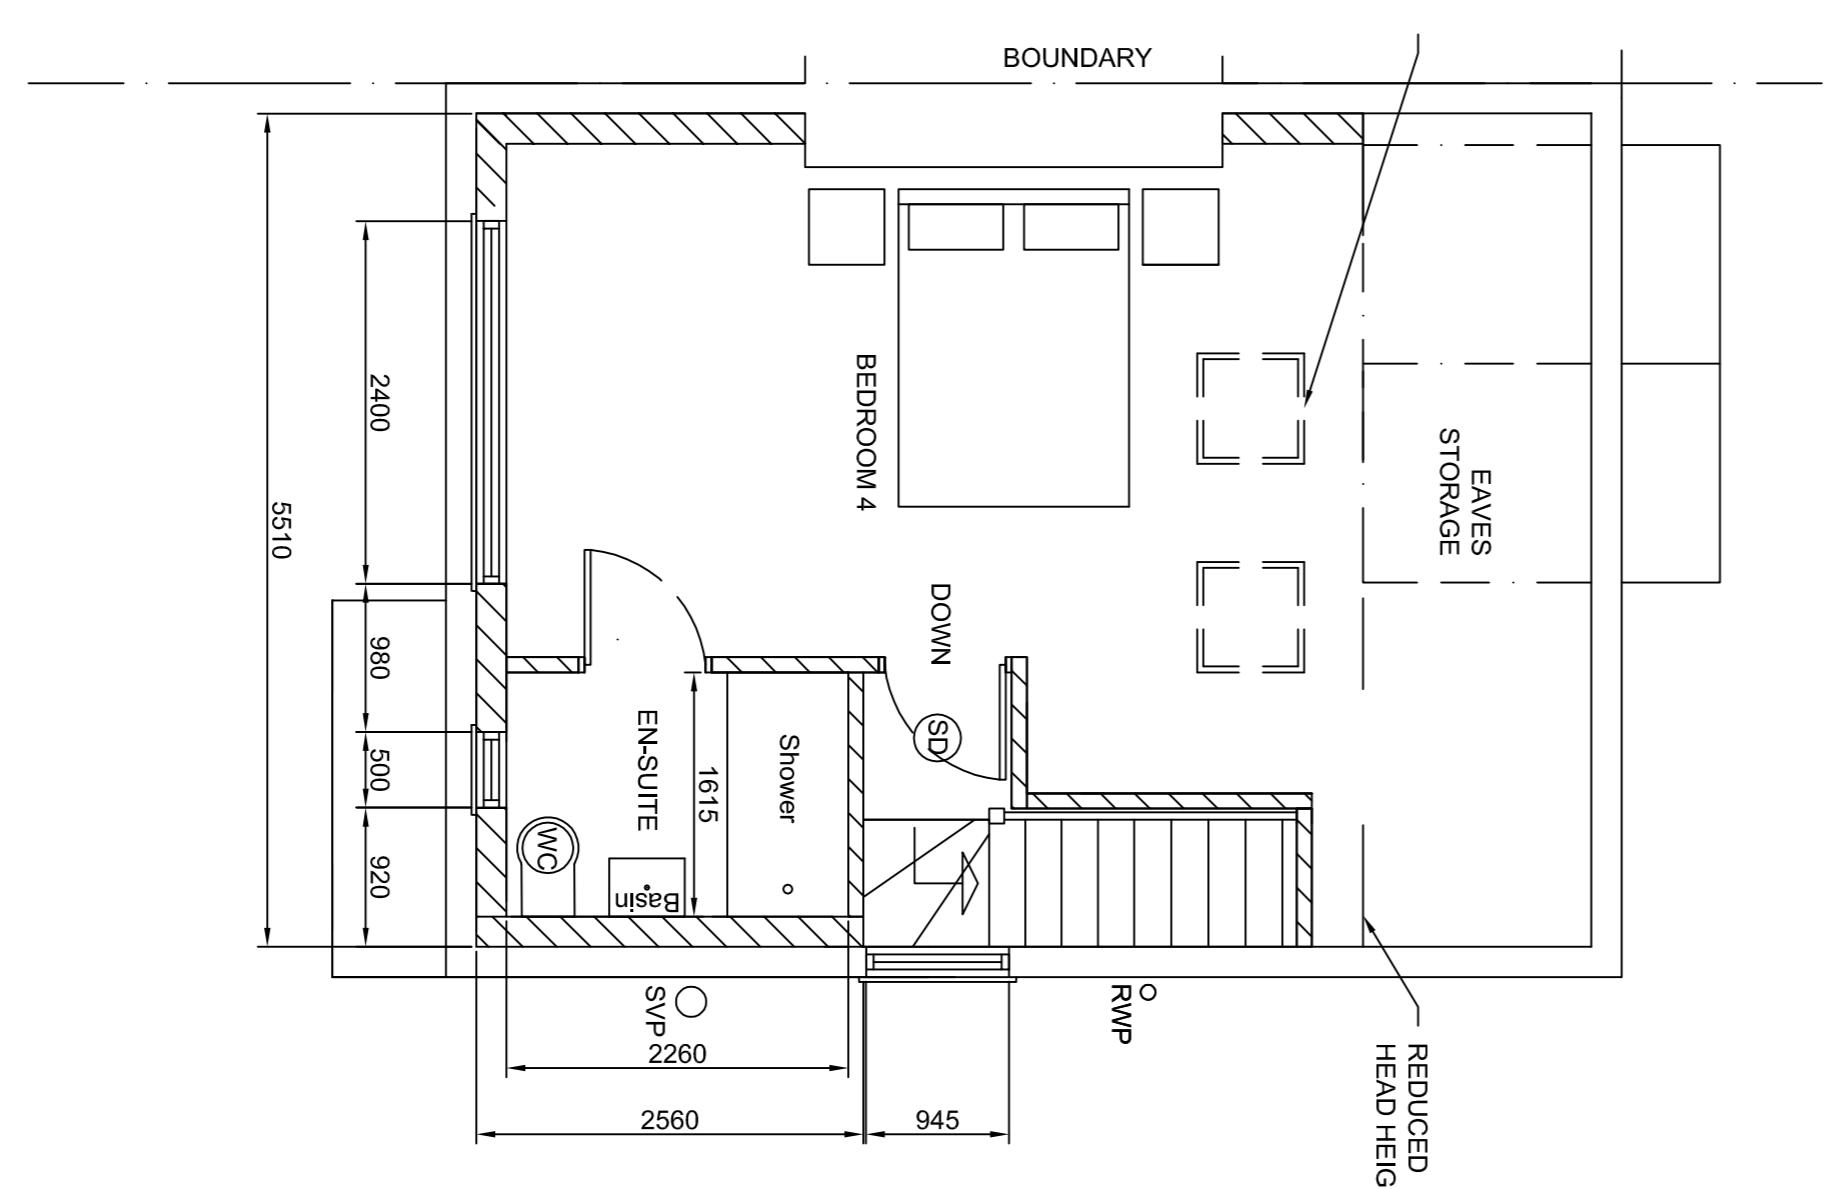


Proposed roof plan

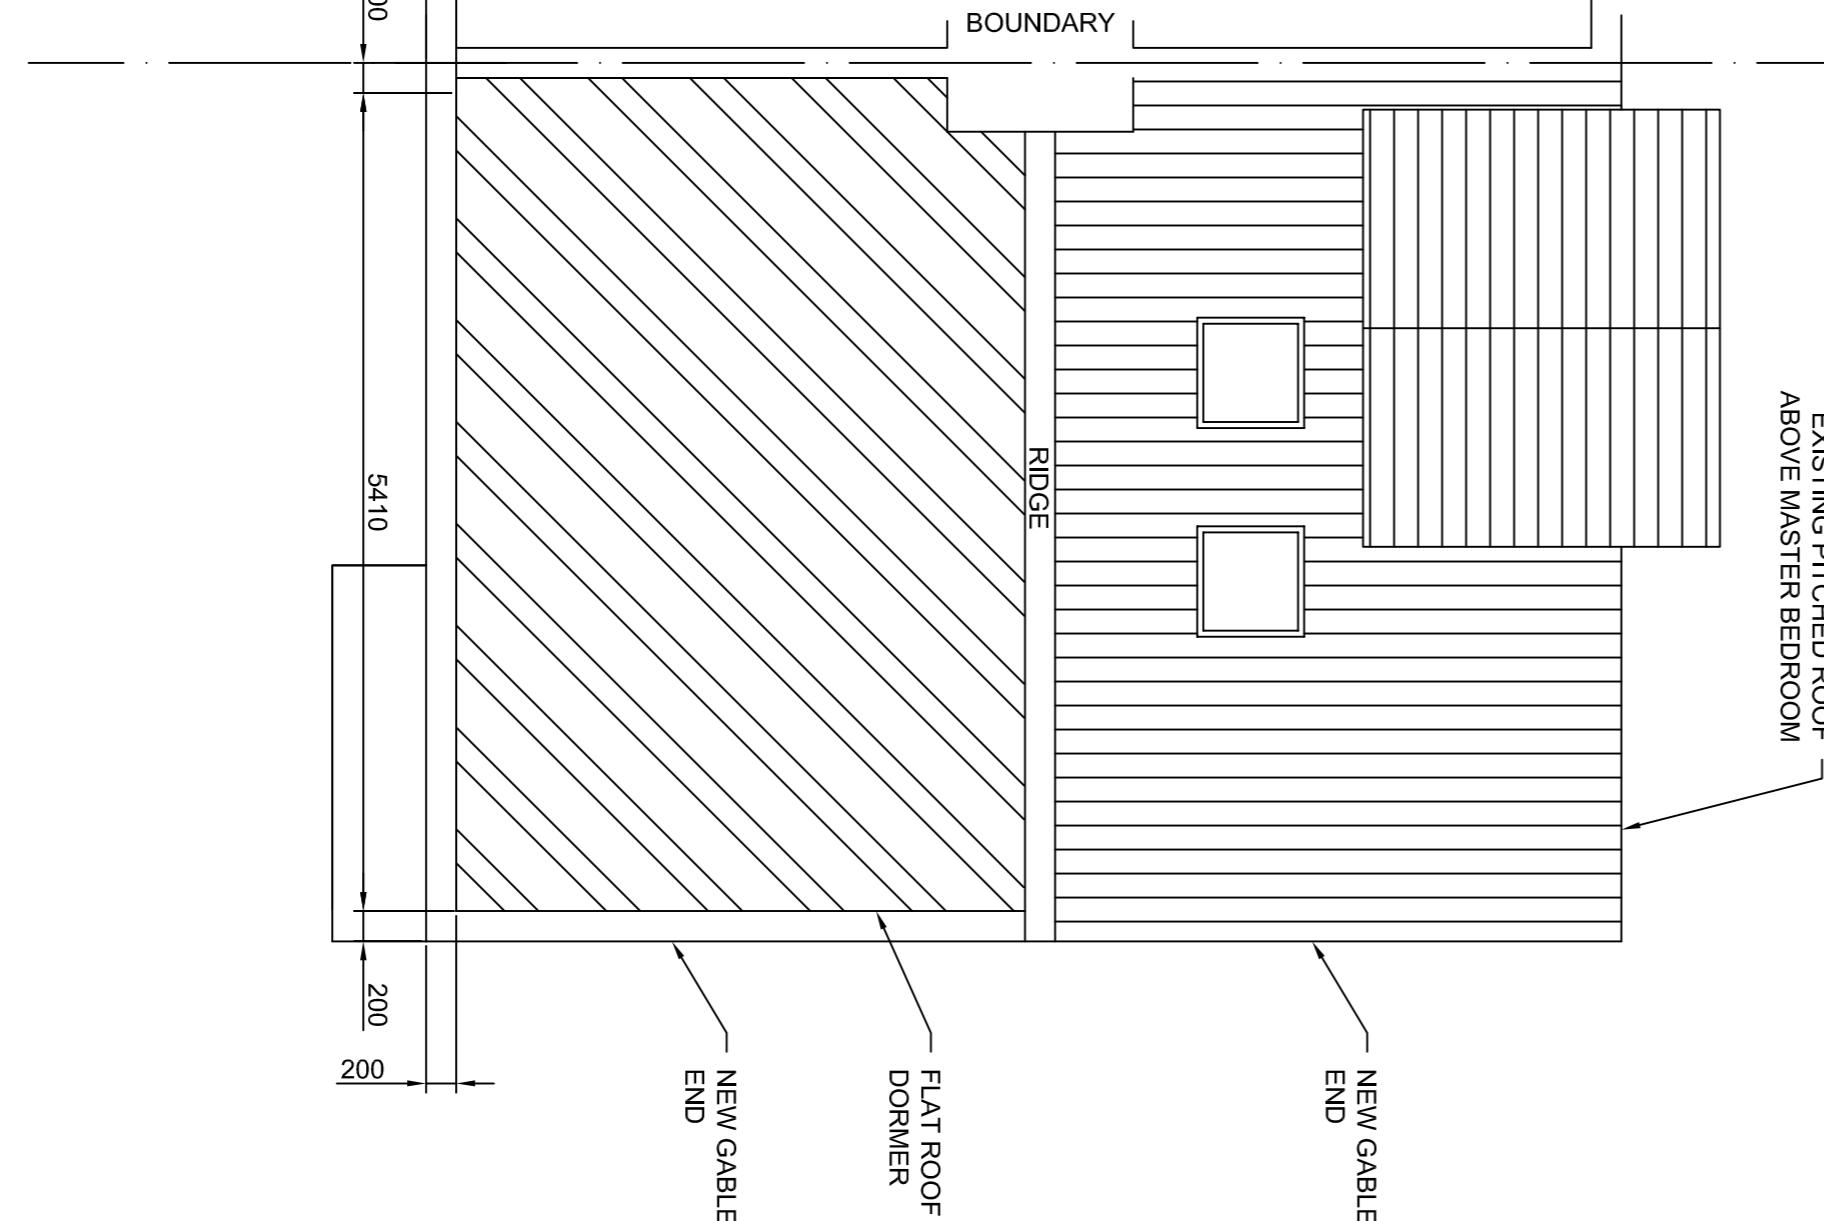


Proposed Front Elevation

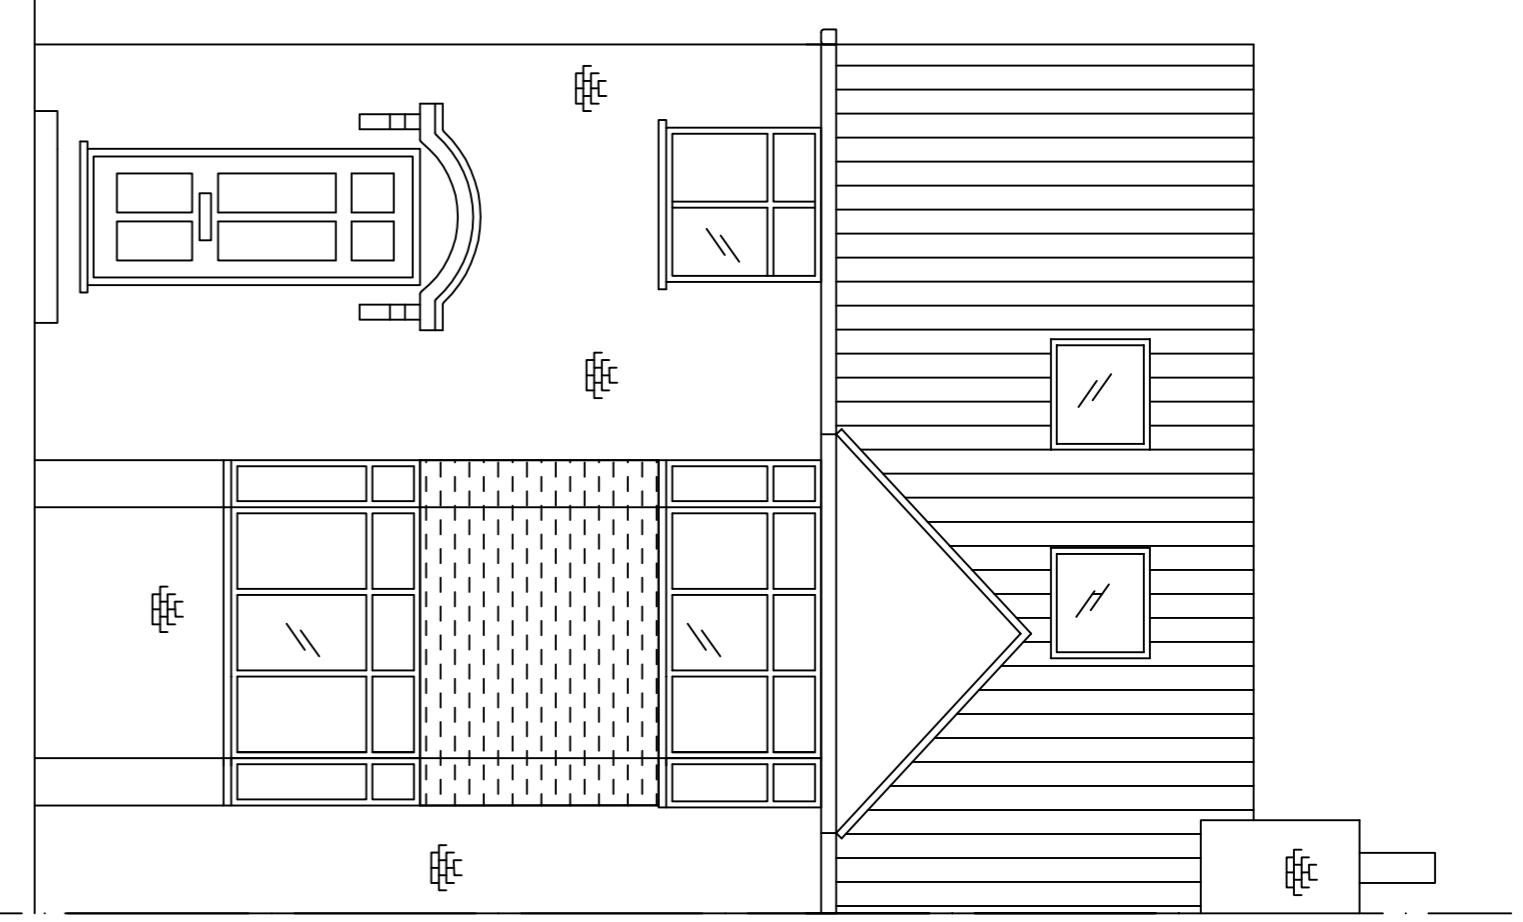

Proposed Rear Elevation

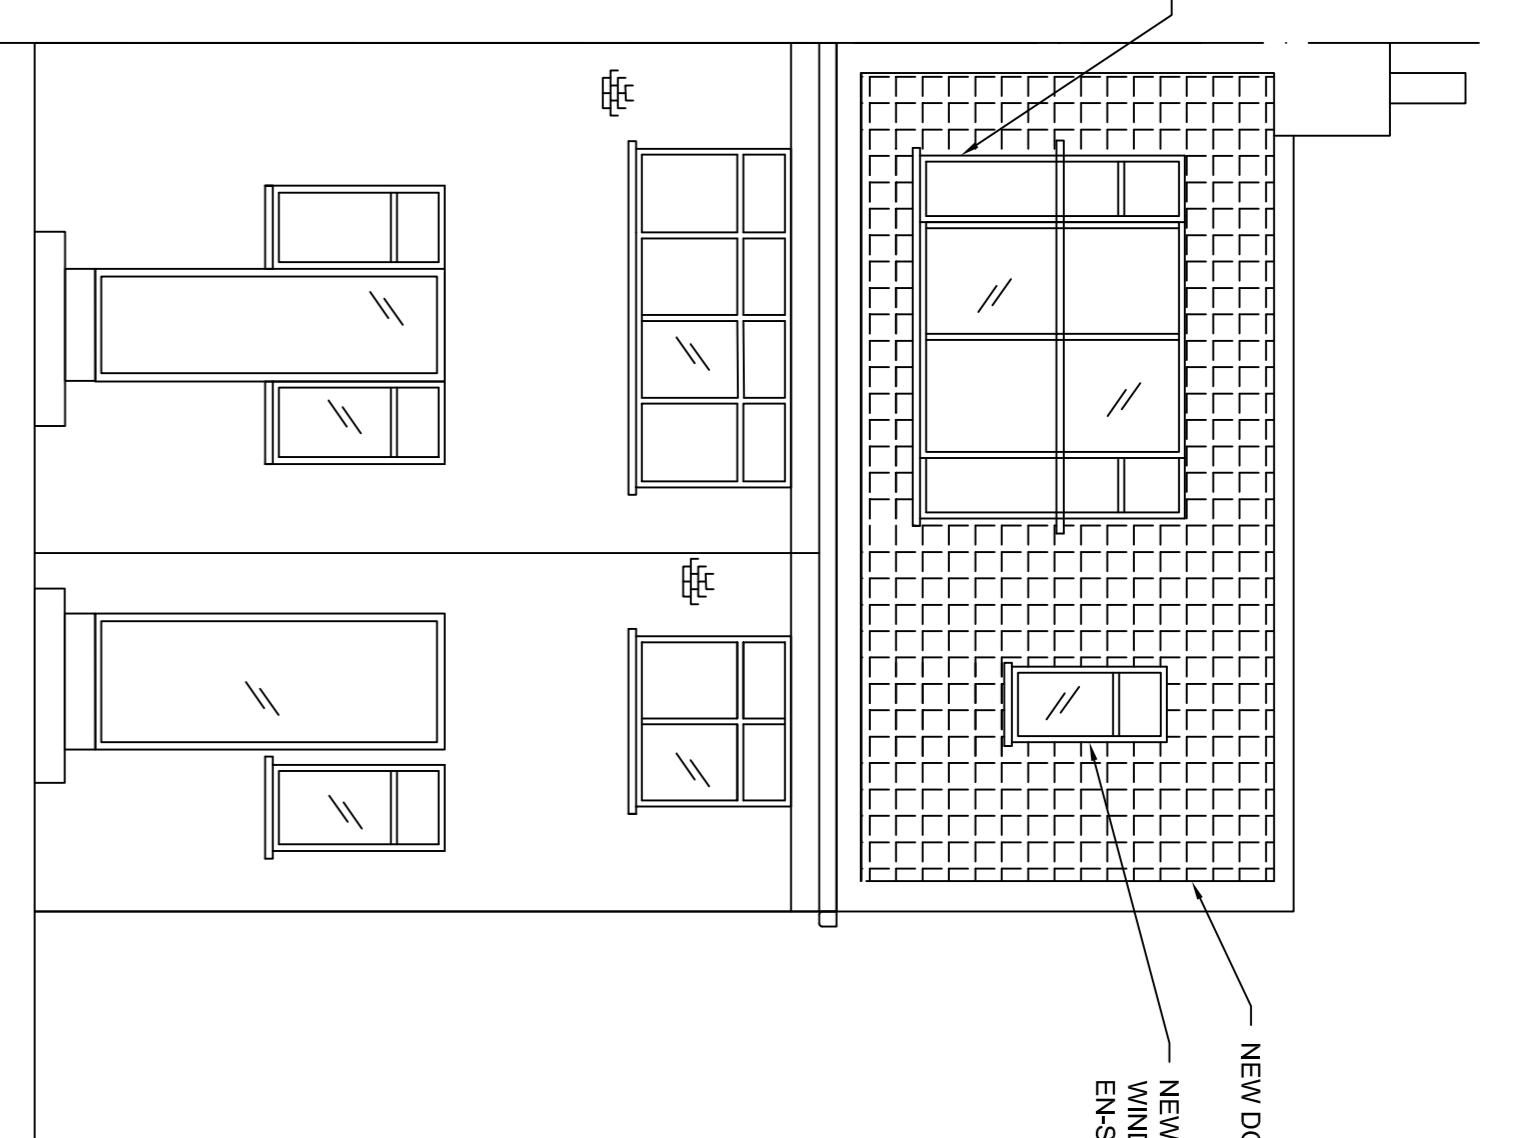

Proposed Side Elevation

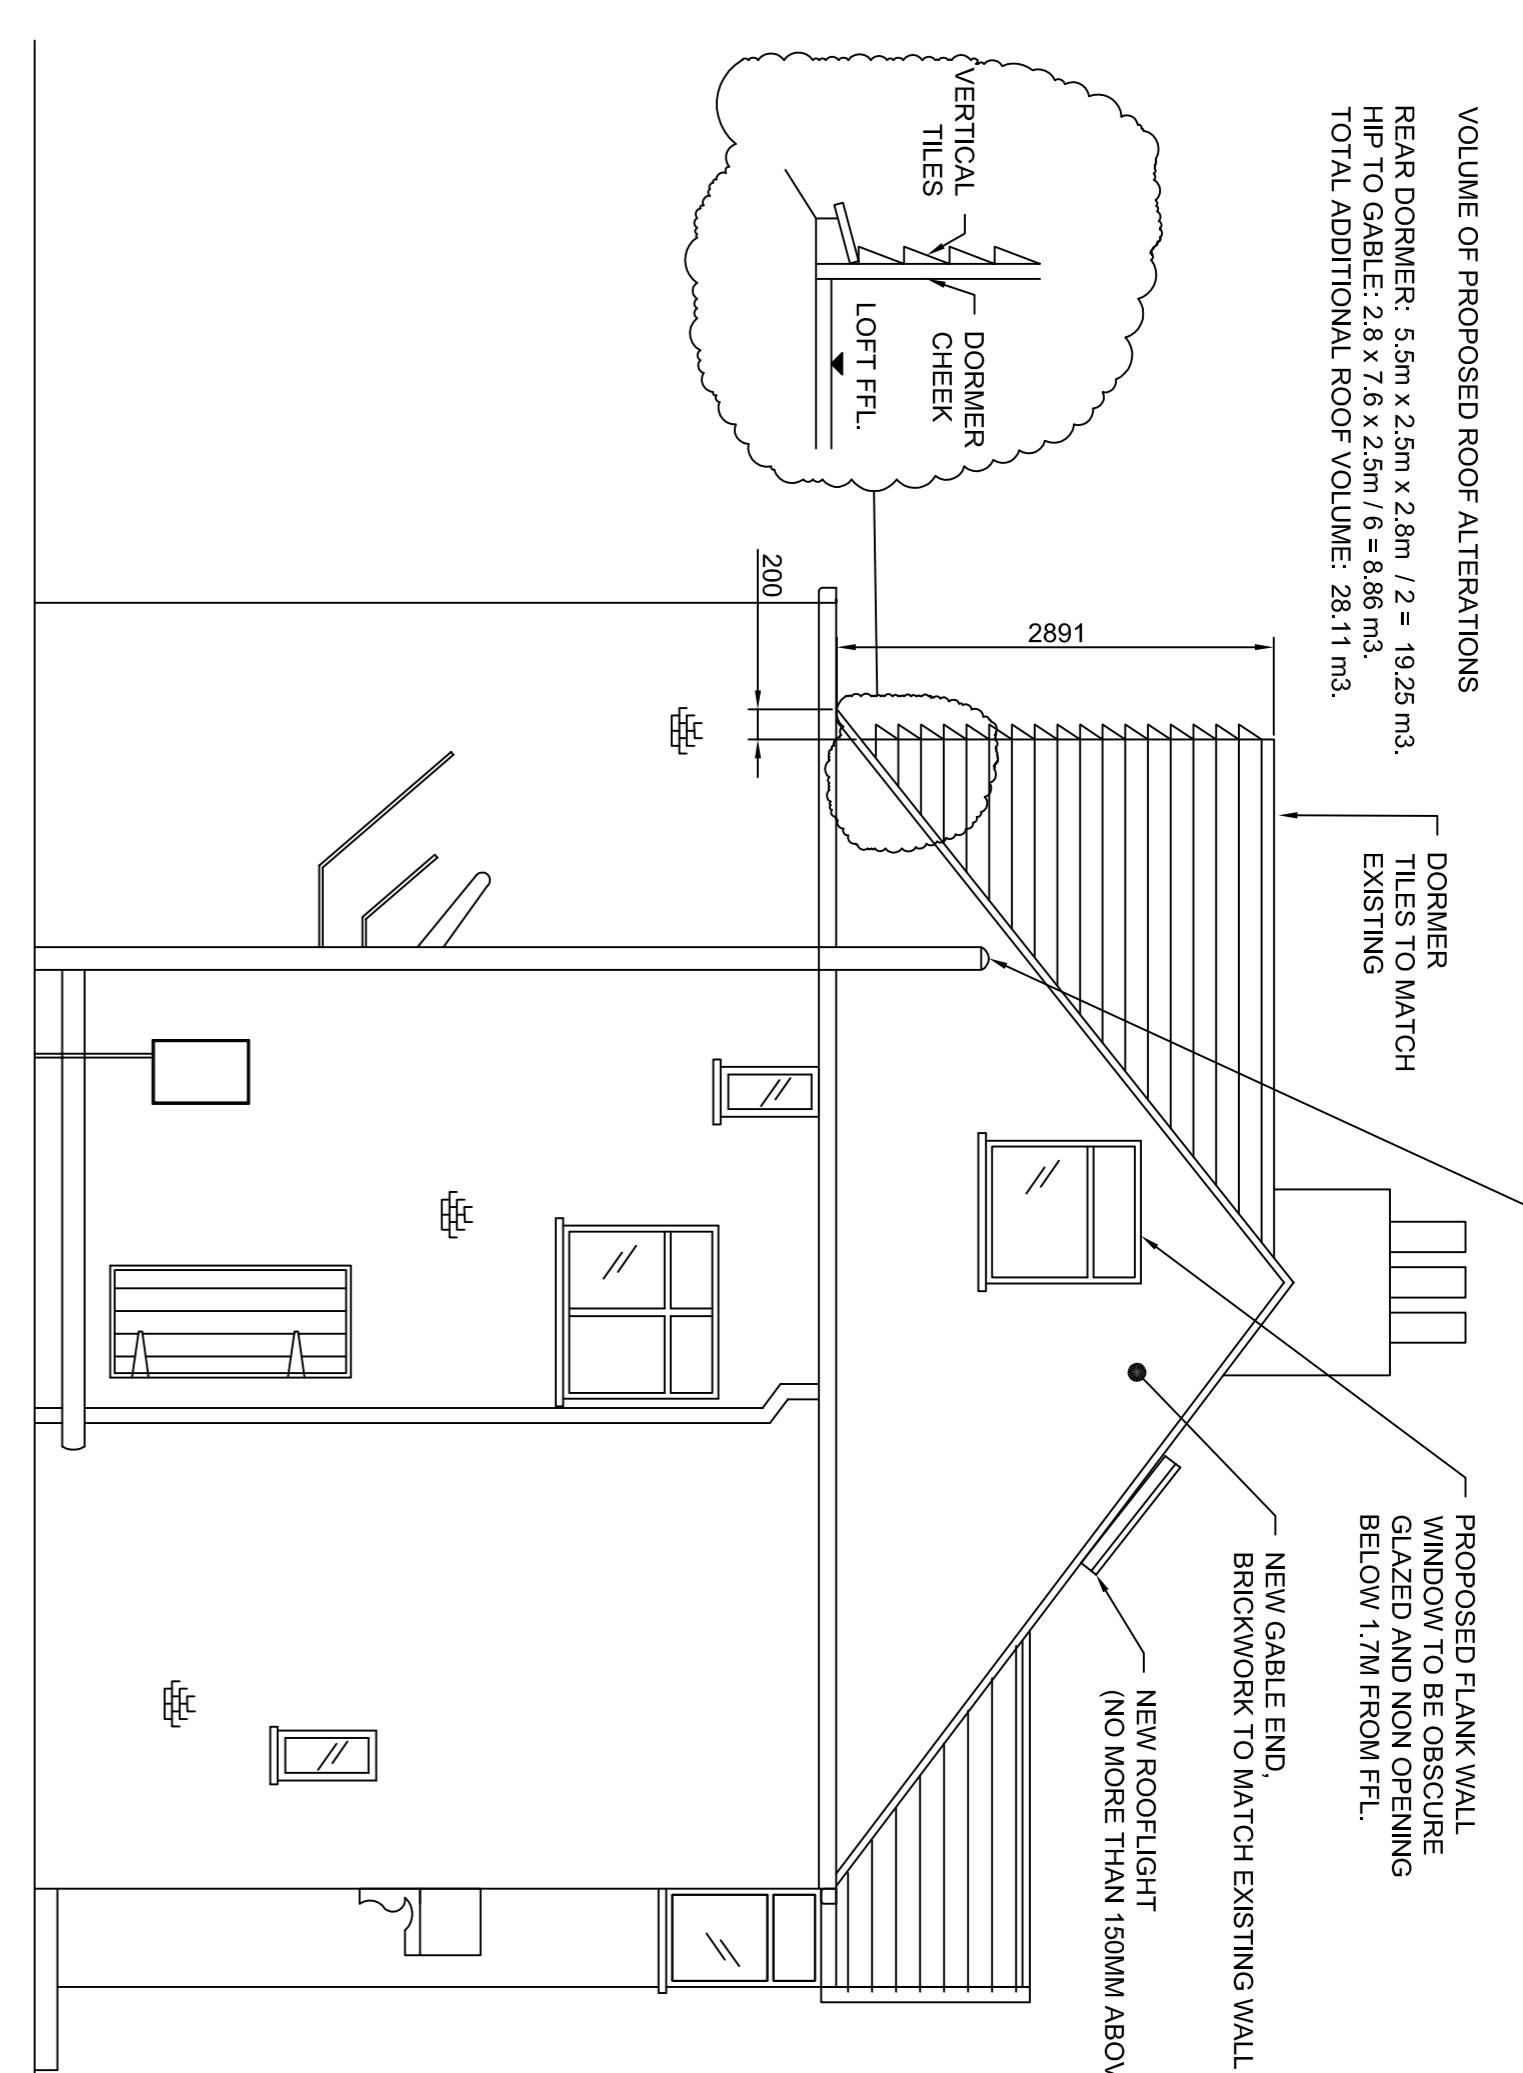

VOLUME OF PROPOSED ROOF ALTERATIONS
REAR DORMER: 5.5m x 2.5m x 2.8m = 19.25m³.
HIP TO GABLE: 2.8 x 7.0 x 2.5m = 8.95m³.
TOTAL ADDITIONAL ROOF VOLUME: 28.1m³.

Notes:
All dimensions should be checked with a site survey.
Drawings are subject to statutory authority approval and are to be used for the purpose of planning. Structural calculations and drawings to be supplied by a structural engineer.

Drawing Title:
PROPOSED PLANS

SCALE: 1:50 @ A1

Drawn by: Margaret Leo

Drawing no: 101

Date: JULY 2023

Client :
MR & MRS DOHERTY
22 ELMBRIDGE DRIVE
RUISLIP
HA4 7UT

5
4
3
2
1
0
METRES