

Existing Ground Floor Plan

Scale 1:100



Existing Front Elevation

Scale 1:100




Existing Side Elevation

Scale 1:100



Existing Rear Elevation

Scale 1:100

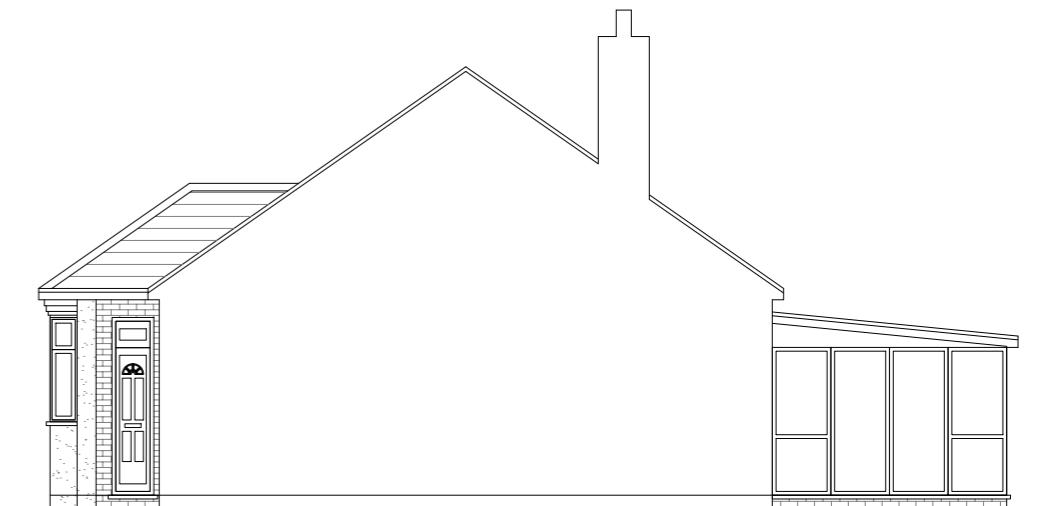

Existing Side Elevation

Scale 1:100



GENERAL NOTES:

1. ALL DIMENSIONS ARE IN MILLIMETER.
2. VERIFY ALL DIMENSIONS AND CONDITIONS BEFORE BUILDING OR STARTING CONSTRUCTION. NOTIFY THE DESIGNER IMMEDIATELY OF ANY DISCREPANCY OR VARIATION.
3. ALL WORK TO COMPLY WITH CURRENT BUILDING REGULATIONS AND CODES OF PRACTICE

Title:

Existing Ground Floor Plan & Elevations

Site Address
78 Herlyn Avenue,
Ruislip.
HA4 6HQ

Scale: 1:100 @A3
Date: 21/09/2022
Drawing No.: 2022/130 -01
Drawn By: RO

Revision Date:

e:mail - faluckpatel@yahoo.com
(M) +44 (0) 7871 466 254



Proposed Ground Floor Plan

Scale 1:50

GENERAL NOTES:

1. ALL DIMENSIONS ARE IN MILLIMETER.
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Title:

Proposed Ground Floor Plan

Site Address

78 Herlyn Avenue,
Ruislip.
HA4 6HQ

Scale: 1:50 @A3

Date: 21/09/2022
Drawing No.: 2022/130 -02

Revision Date:


Drawn By:
RO

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Faluck Patel

5 Meter
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GENERAL NOTES:

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3. ALL WORK TO COMPLY WITH CURRENT BUILDING REGULATIONS AND CODES OF PRACTICE

Title:

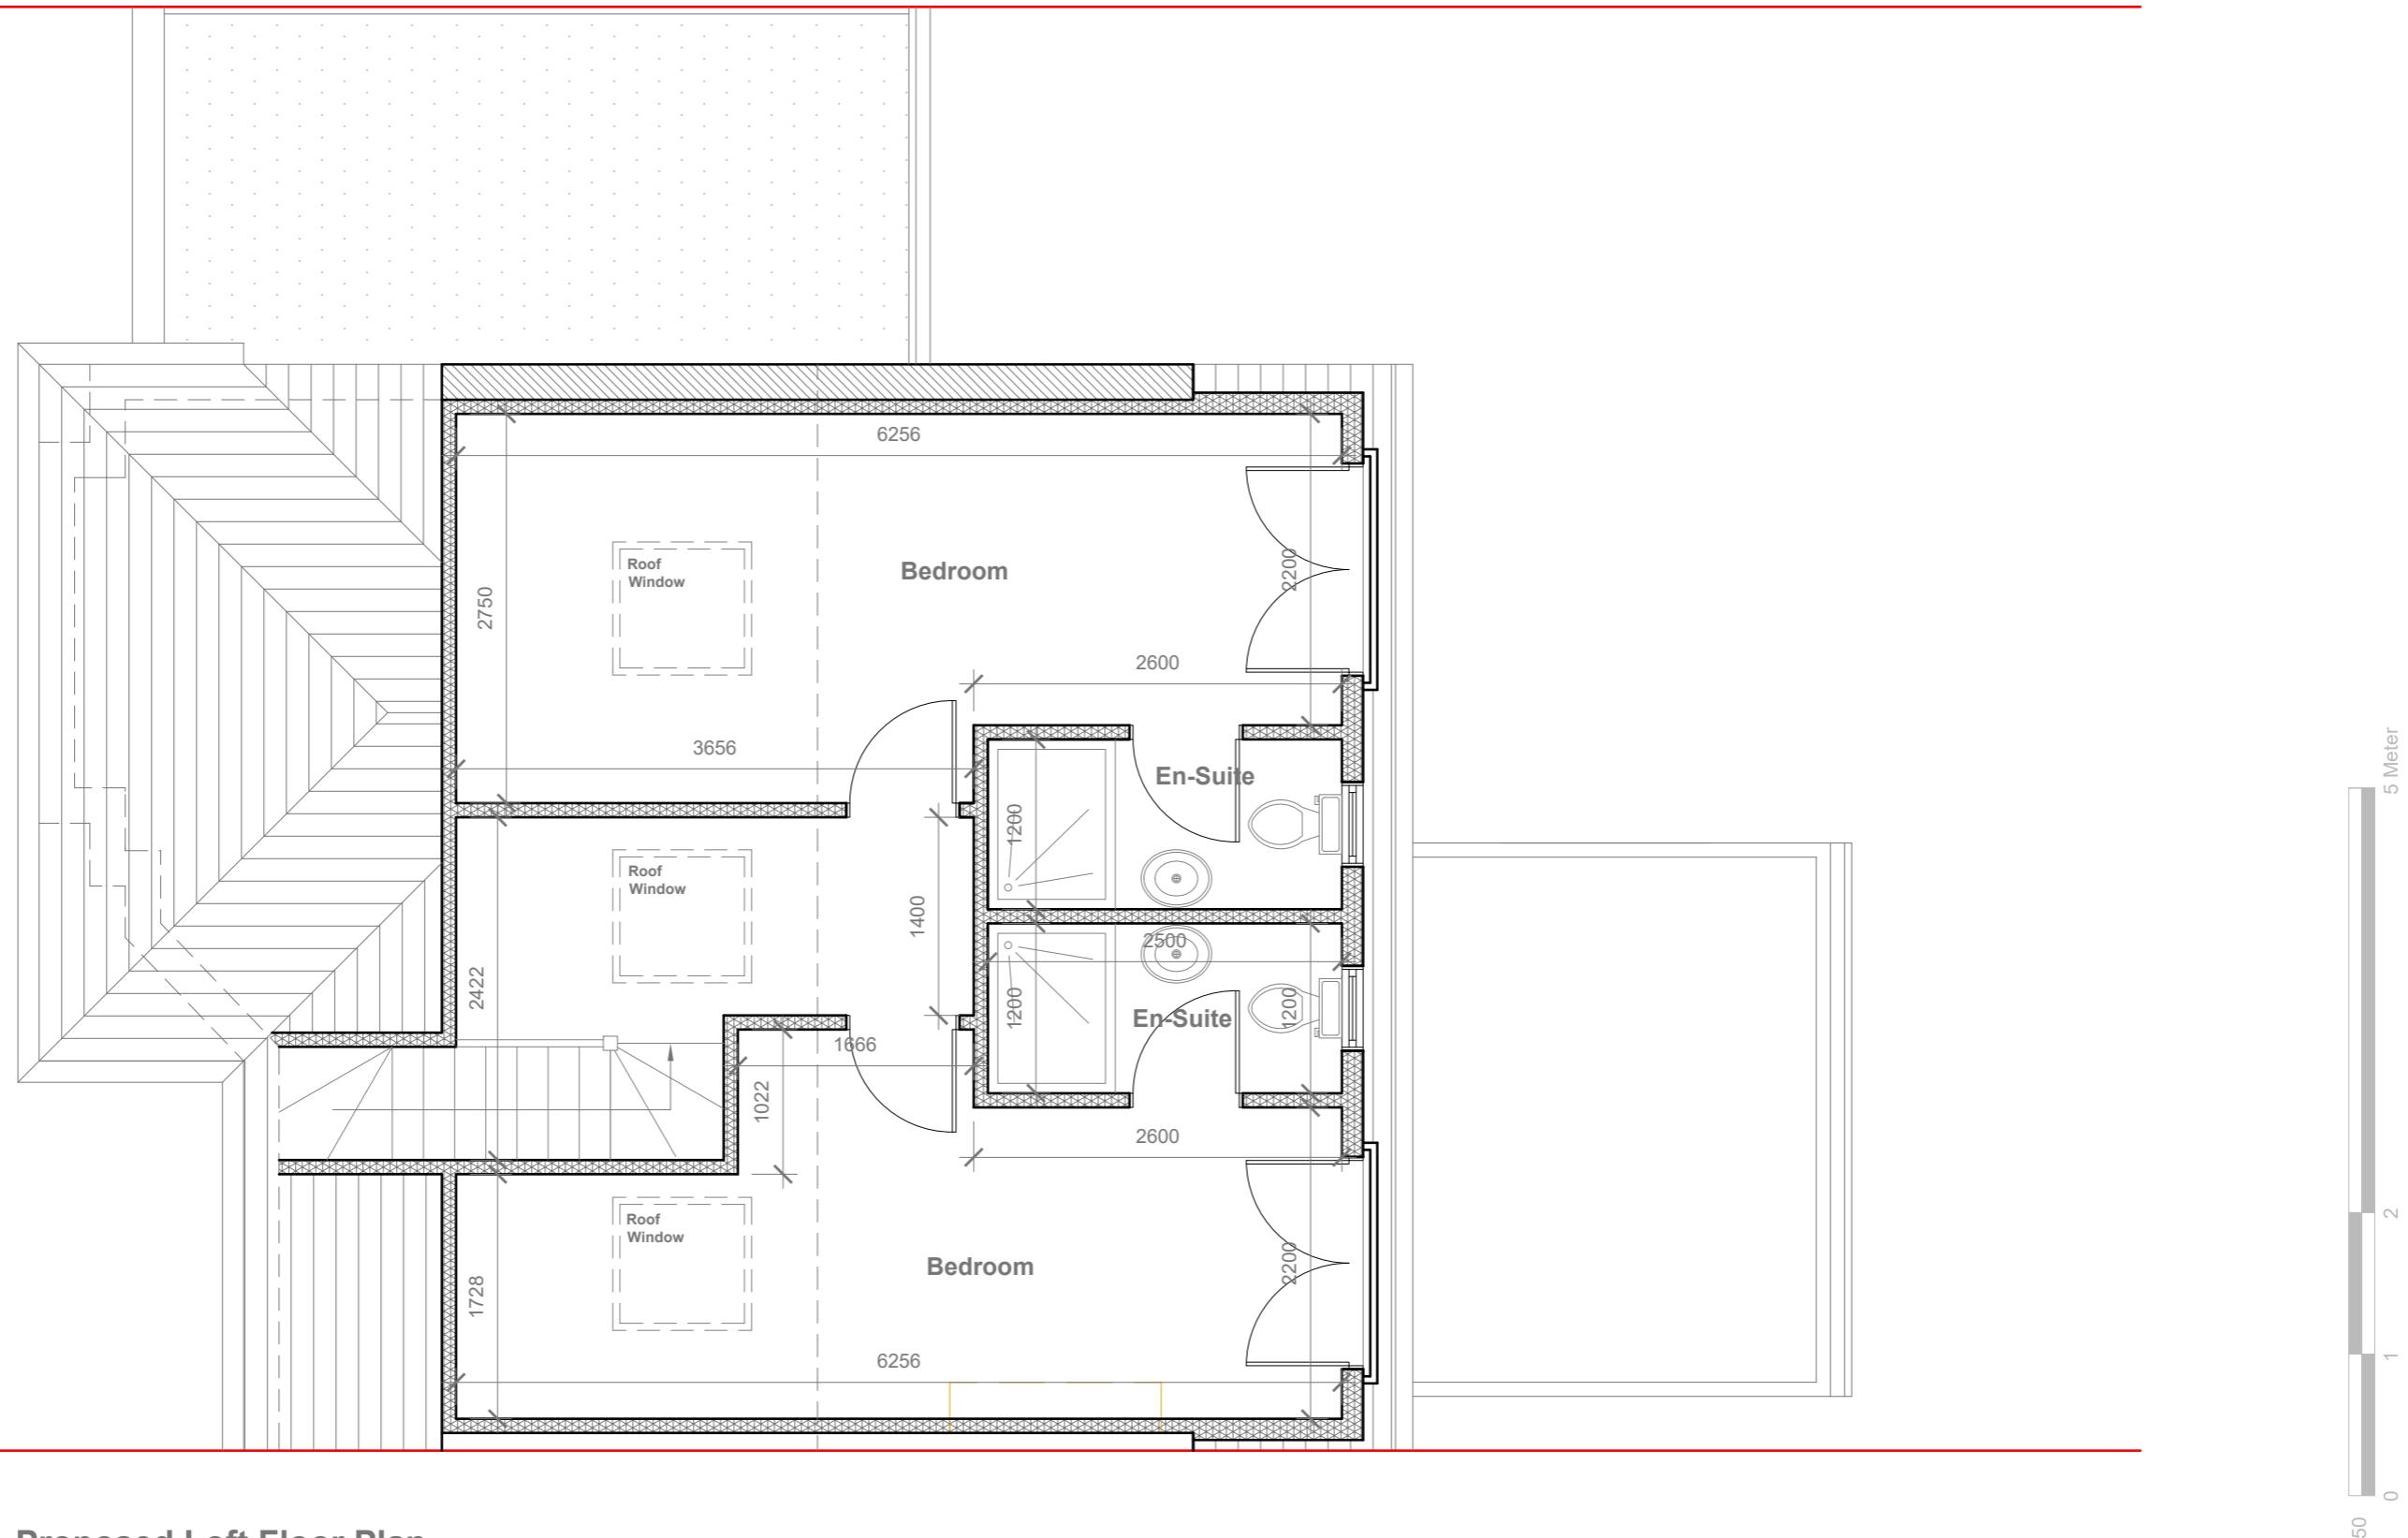Proposed Loft Floor Plan

Site Address

78 Herlyn Avenue,
Ruislip.
HA4 6HQ

Scale: 1:50 @A3

Date: 21/09/2022
Drawing No.: 2022/130 -03PD
Drawn By: RO

Revision Date:


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Proposed External Finish Materials to Match Existing External Finish Materials



Proposed Front Elevation

Scale 1:100

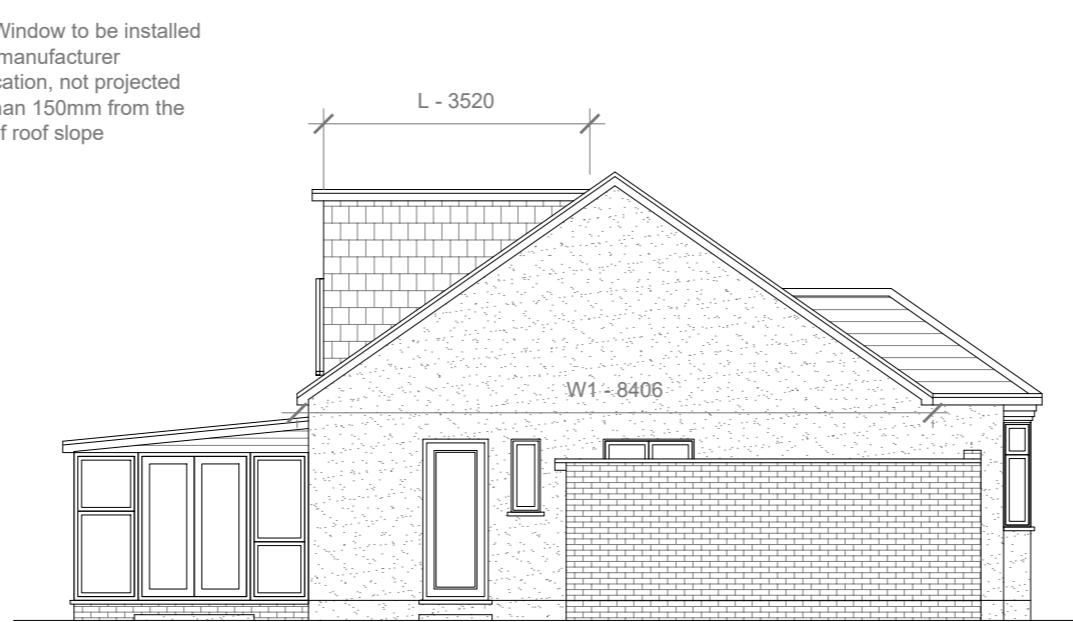


Proposed Side Elevation

Scale 1:100



Proposed Rear Elevation

Scale 1:100

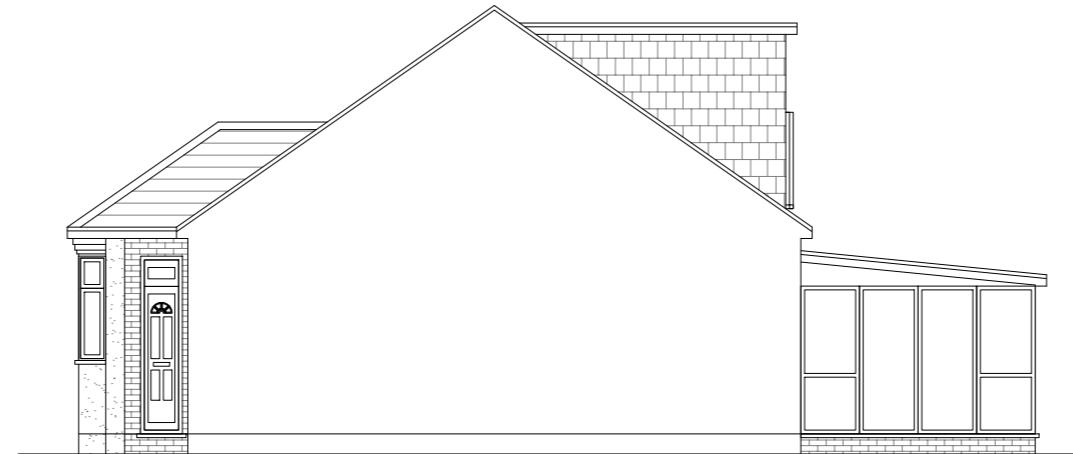

Proposed Side Elevation

Scale 1:100

REAR DORMER VOLUME = $W \times H \times L / 2$
 $7.400 \times 2.456 \times 3.520 / 2$
 $63.97 / 2$
 31.98 CU.MT.

HIP TO GABLE ROOF VOLUME = $W1 \times H1 \times L1 / 6$
 $8.406 \times 3.082 \times 4.053 / 6$
 $105.00 / 6$
 17.50 CU.MT.

TOTAL ROOF VOLUME = $V1 + V2$
 $31.98 + 17.50$
 $49.48 \text{ CU.MT.} < 50.00 \text{ CU.MT.}$

10 Meter
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1:100

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3. ALL WORK TO COMPLY WITH CURRENT BUILDING REGULATIONS AND CODES OF PRACTICE

Title:

Proposed Elevations

Site Address	Scale: 1:100 @A3	Revision Date:
78 Herlwyn Avenue, Ruislip. HA4 6HQ	Date: 21/09/2022	
	Drawing No.: 2022/130 -04PD	
	Drawn By: RO	
	e:mail - faluckpatel@yahoo.com (M) +44 (0) 7871 466 254	

Faluck Patel