

Pre-Existing Ground Floor Plan

Scale 1:50

GENERAL NOTES:
 1. ALL DIMENSIONS ARE IN MILLIMETER.
 2. VERIFY ALL DIMENSIONS AND CONDITIONS BEFORE BUILDING OR
 STARTING CONSTRUCTION. NOTIFY THE DESIGNER IMMEDIATELY OF ANY
 DISCREPANCY OR VARIATION.
 3. ALL WORK TO COMPLY WITH CURRENT BUILDING REGULATIONS AND CODES OF PRACTICE


5 Meter
2
1
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1:50

Title:

Pre-Existing Ground Floor Plan

Site Address	Scale: 1:50 @A3
15 Nine Elms Close, Cowley. UB8 3TN	Date: 10/08/2023
	Drawing No.: 2022/106 -01E
	Drawn By: RO
Revision Date:	
e:mail -	
	faluckpatel@yahoo.com
	(M) +44 (0) 7871 466 254

Faluck Patel

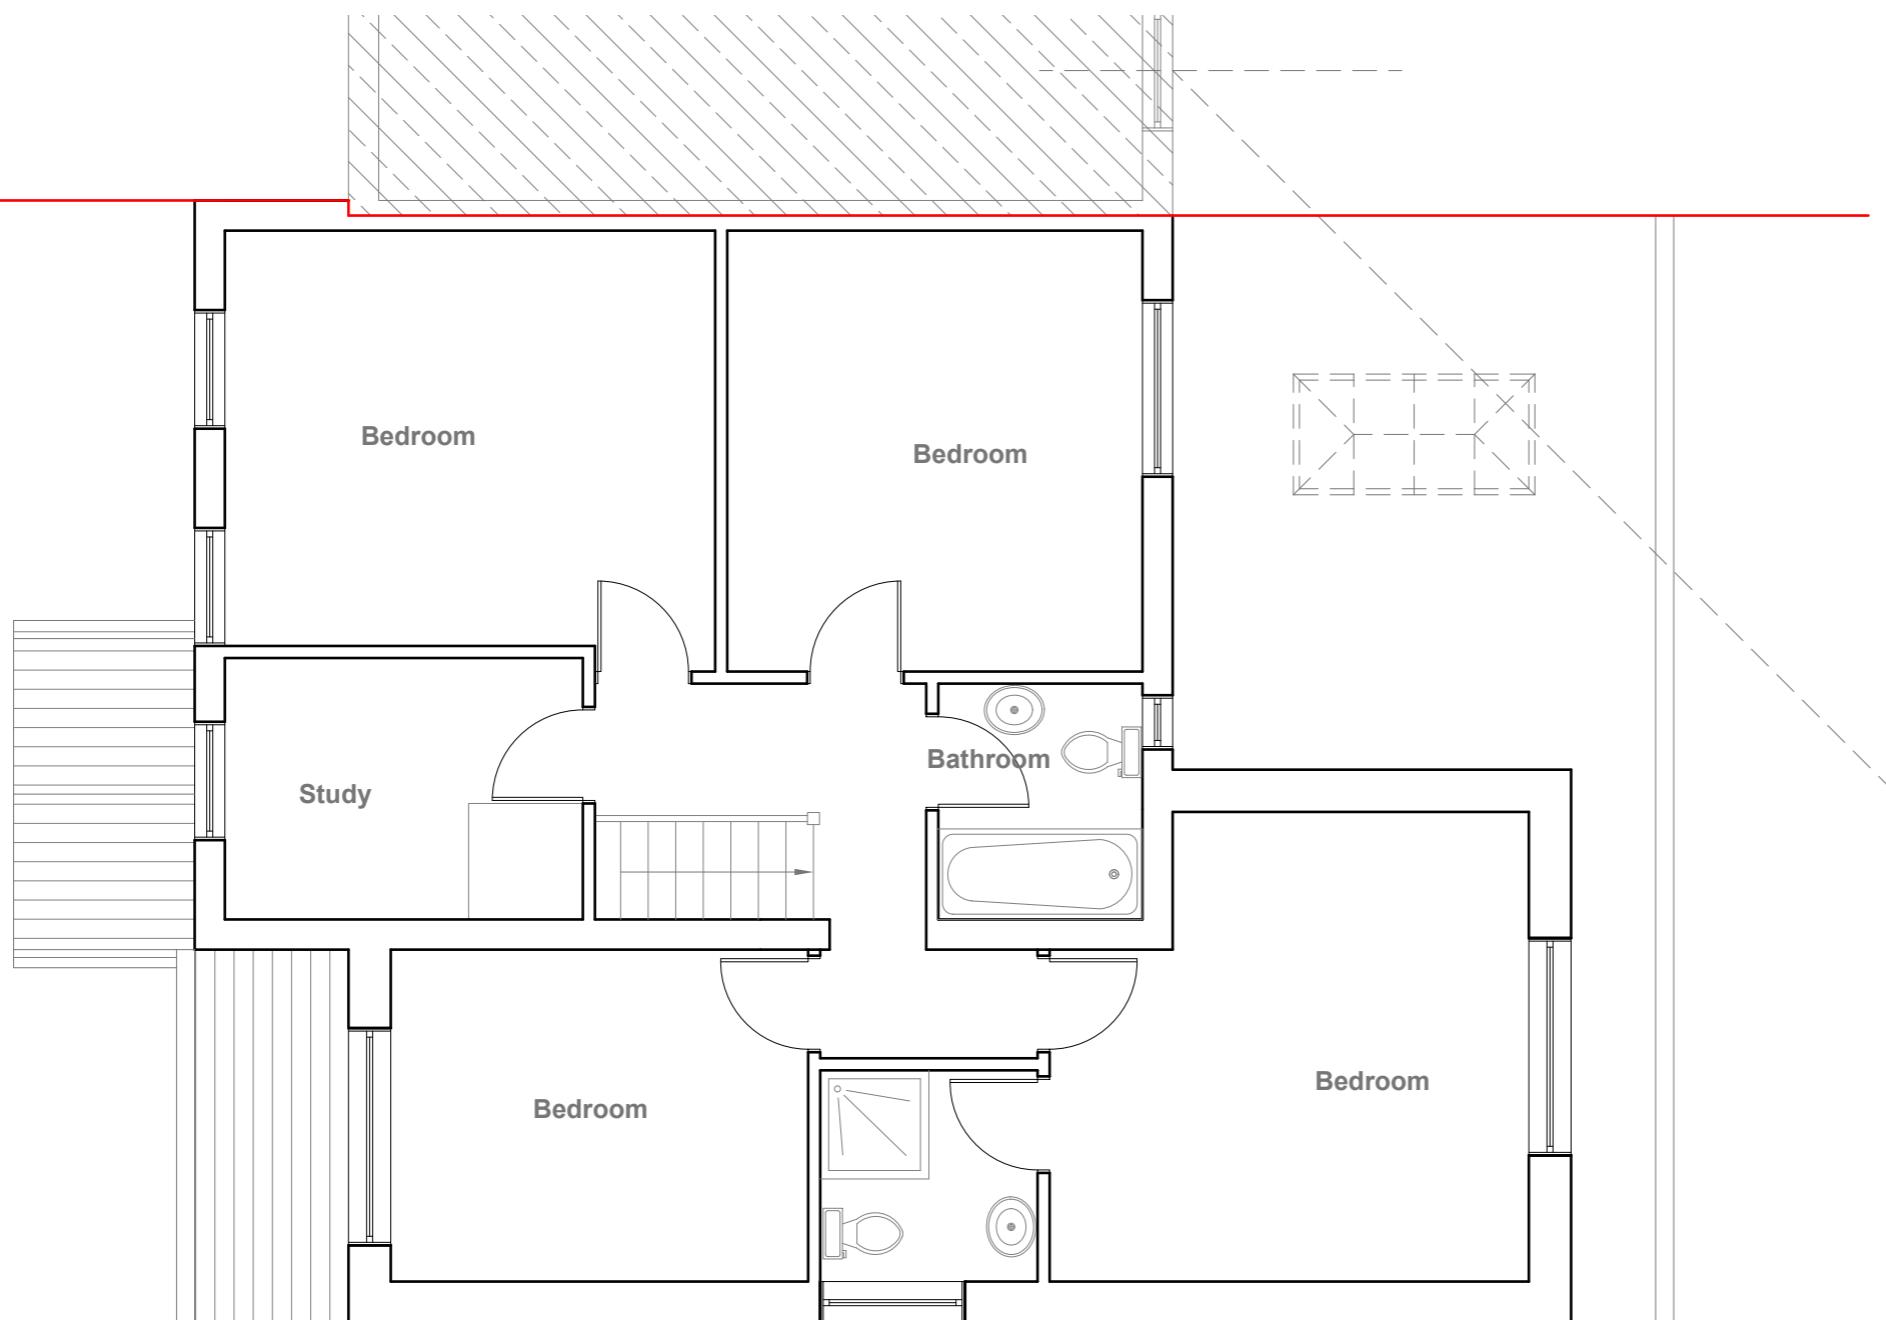

Pre-Existing First Floor Plan
Scale 1:50

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15 Nine Elms Close, Cowley. UB8 3TN	Date: 10/08/2022
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Pre-Existing Front Elevation

Scale 1:100




Pre-Existing Side Elevation

Scale 1:100



Pre-Existing Rear Elevation

Scale 1:100

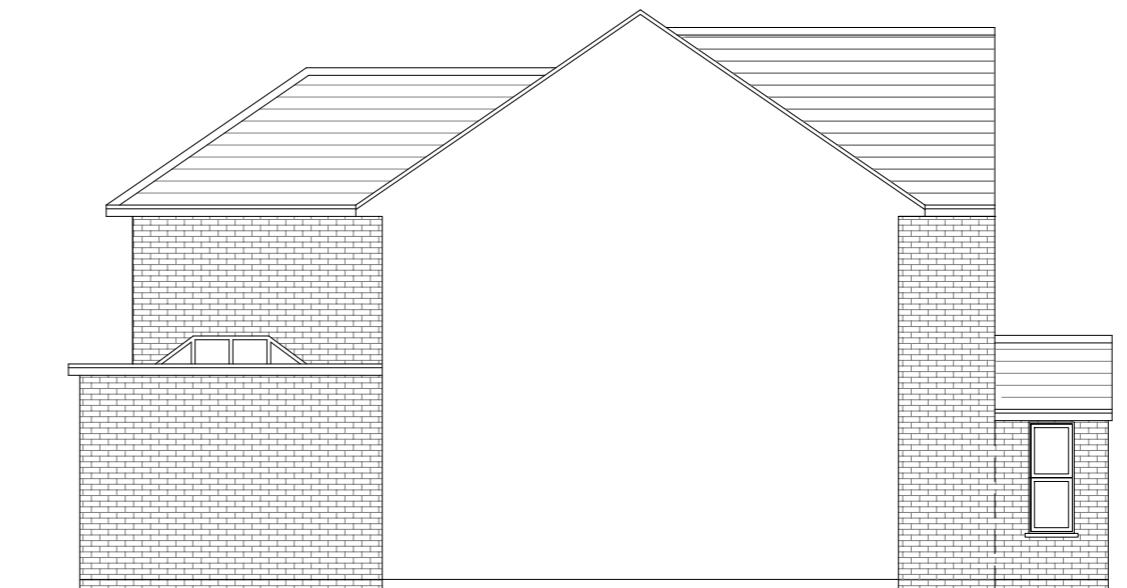

Pre-Existing Side Elevation

Scale 1:100



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Title:


Pre-Existing Elevations

Site Address
15 Nine Elms Close,
Cowley.
UB8 3TN

Scale: 1:100 @A3
Date: 10/08/2023
Drawing No.:
2022/106 -03E
Drawn By:
RO

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Existing Ground Floor Plan

Scale 1:50

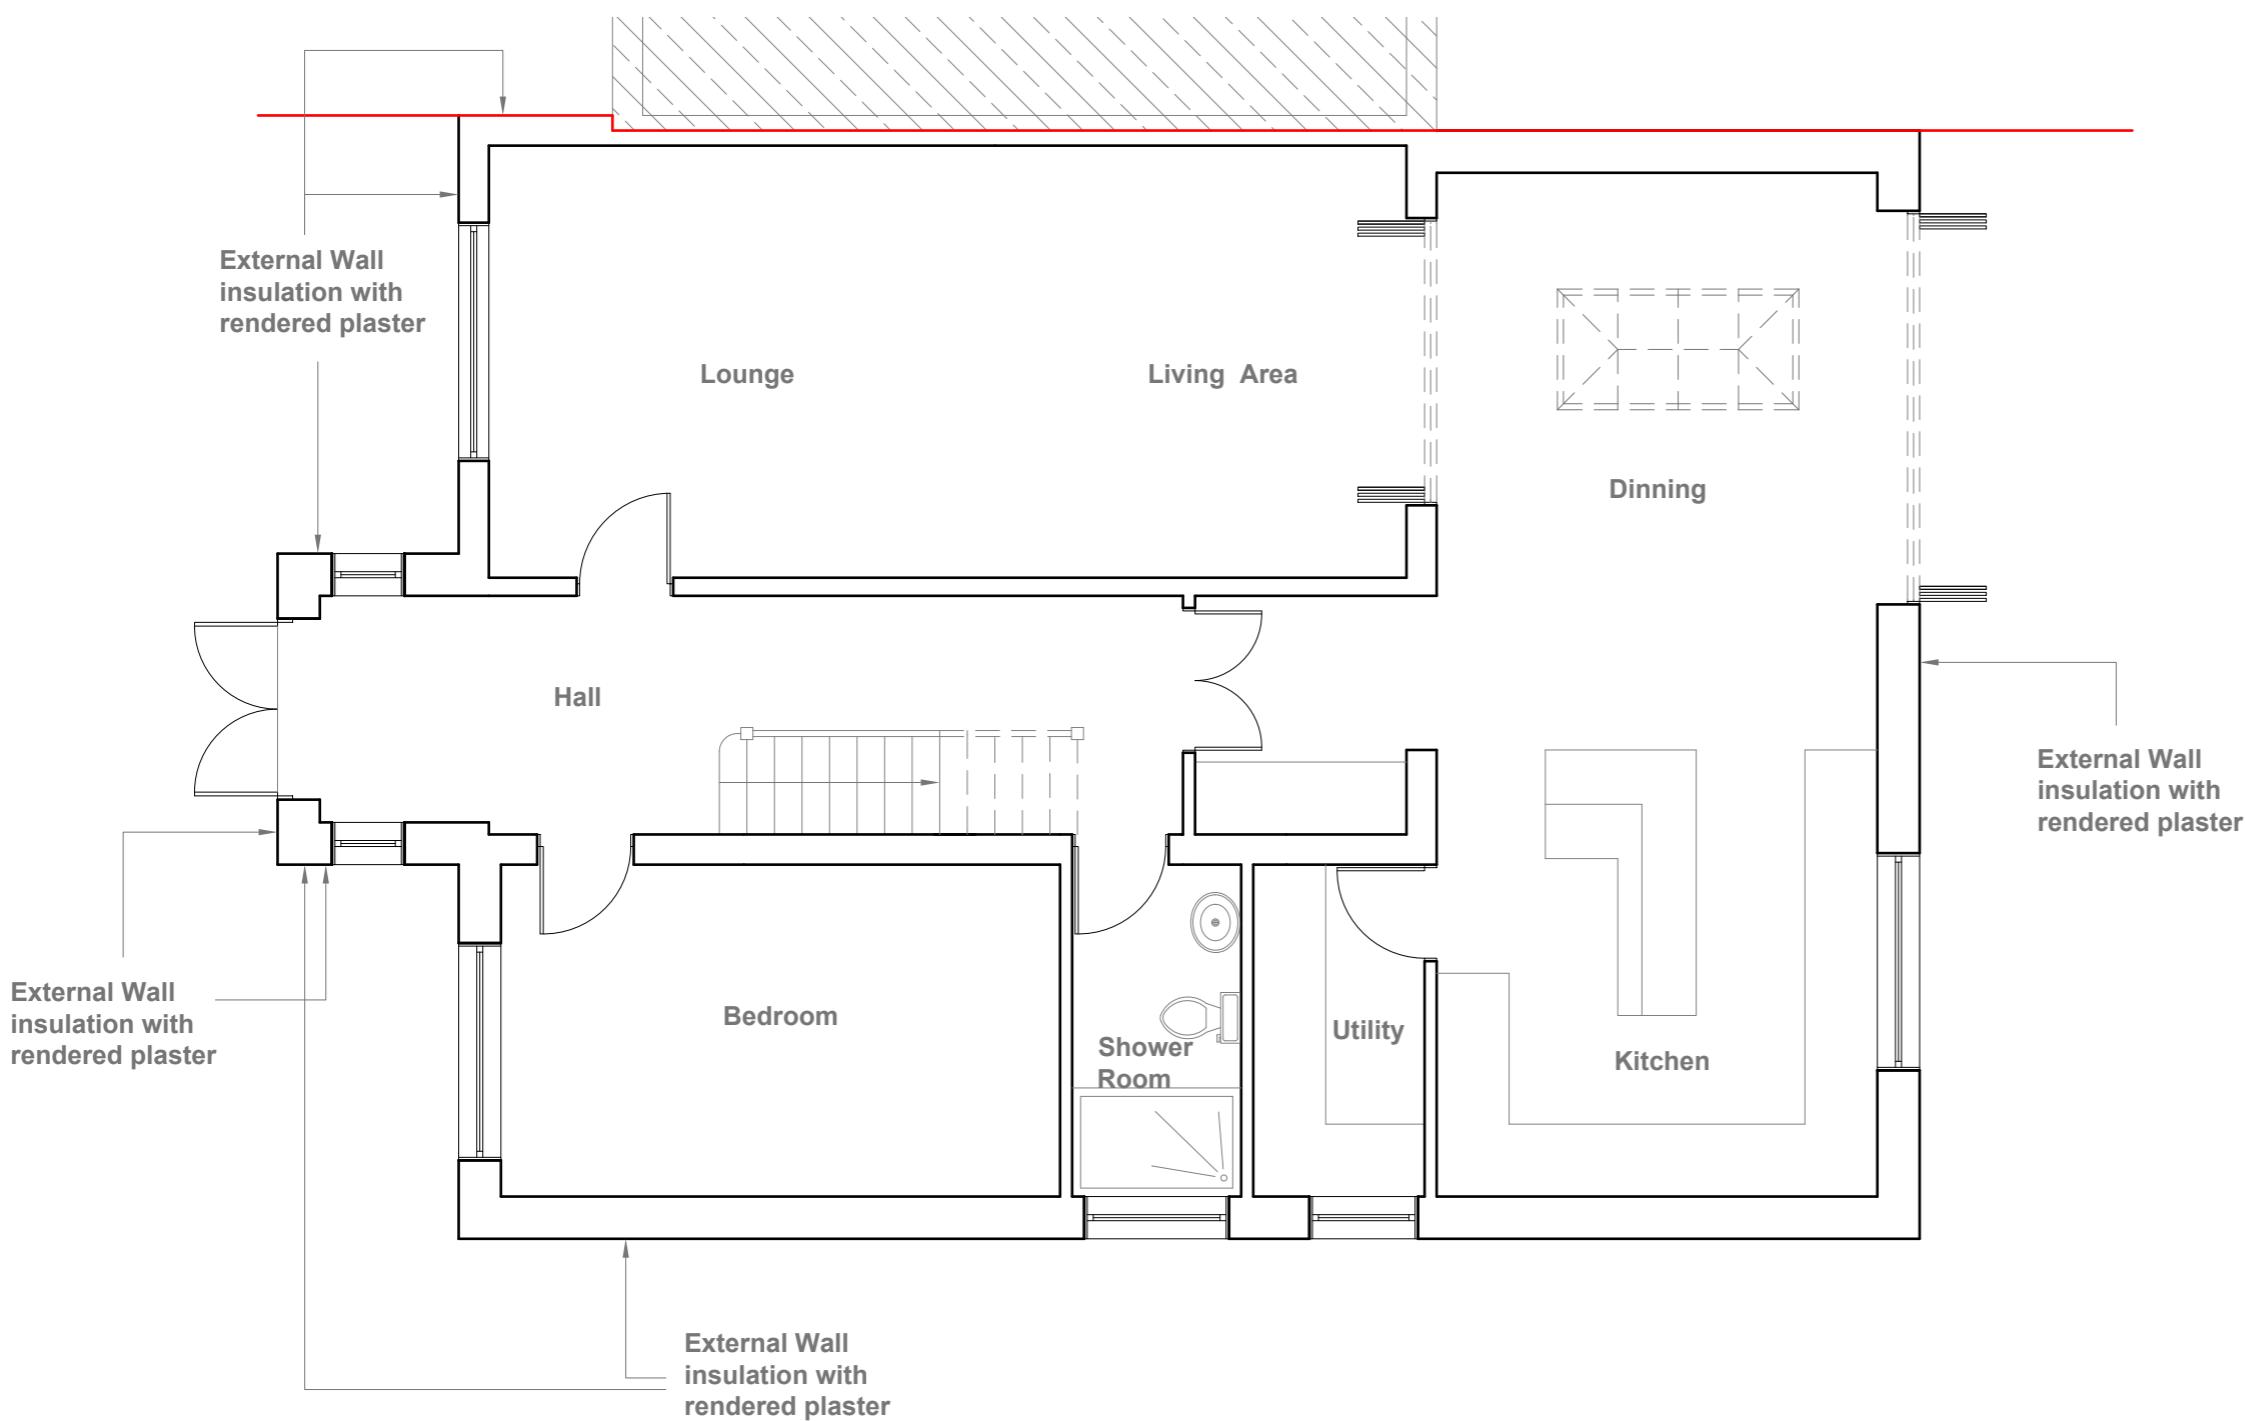
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Title:
**Existing
Ground Floor
Plan**

Site Address	Scale: 1:50 @A3
15 Nine Elms Close, Cowley. UB8 3TN	Date: 10/08/2022
	Drawing No.: 2022/106 -04E
	Drawn By: RO
Revision Date:	
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**Faluck
Patel**



Existing First Floor Plan
Scale 1:50

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Existing First Floor Plan

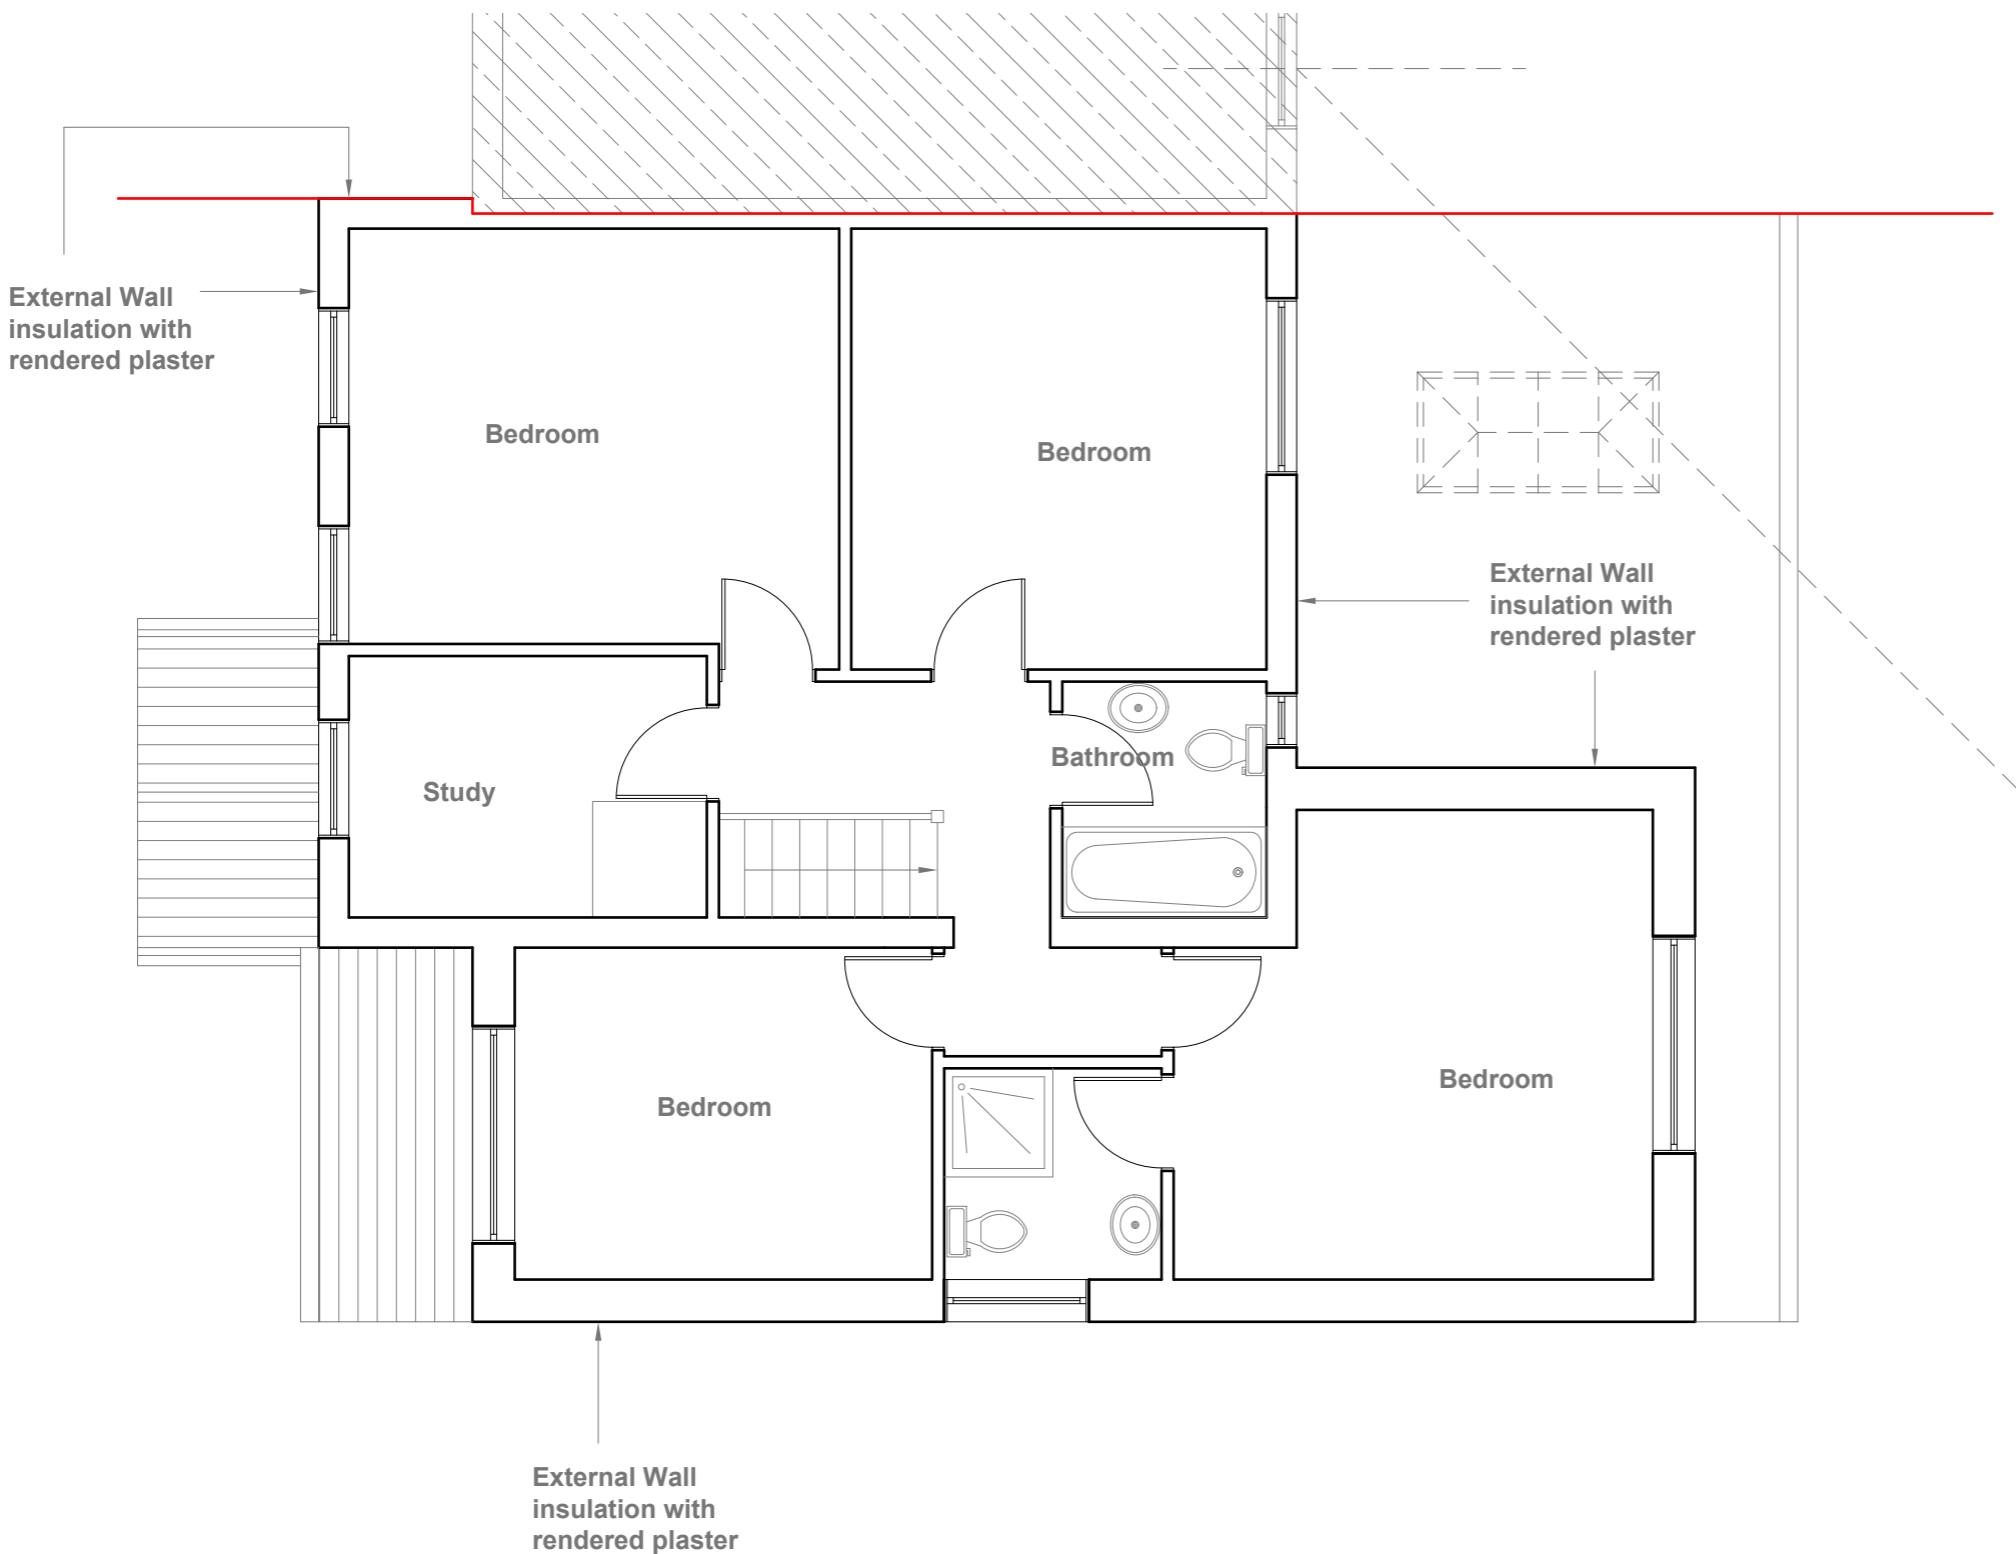
Site Address	Scale: 1:50 @A3
15 Nine Elms Close, Cowley. UB8 3TN	Date: 04/08/2022
	Drawing No.: 2022/106 -05E
	Drawn By: RO
Revision Date:	
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Existing Front Elevation

Scale 1:100




Existing Side Elevation

Scale 1:100

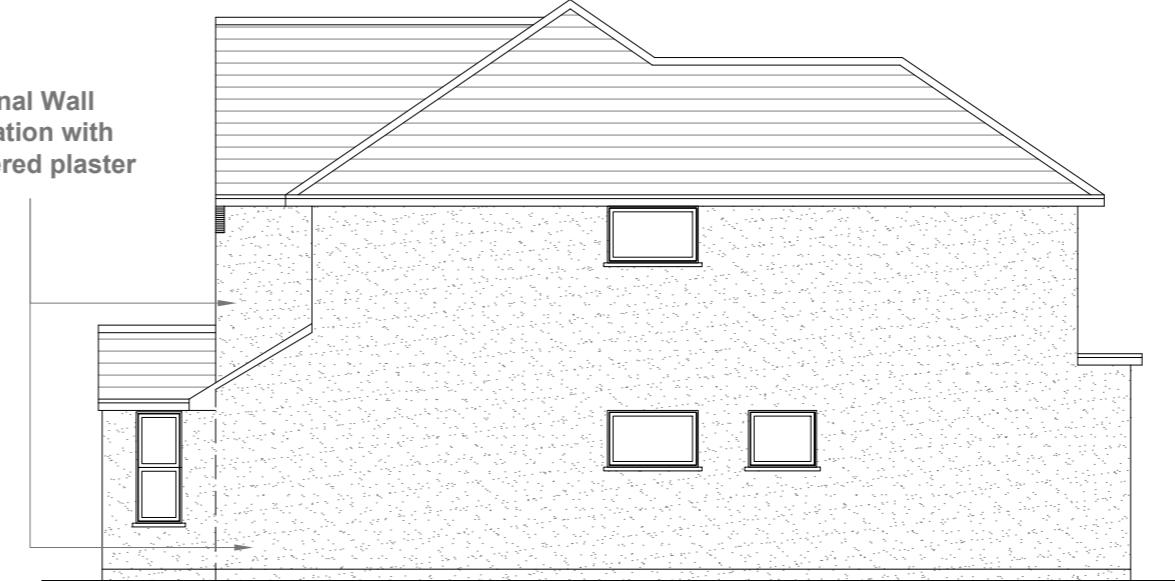

Existing Rear Elevation

Scale 1:100

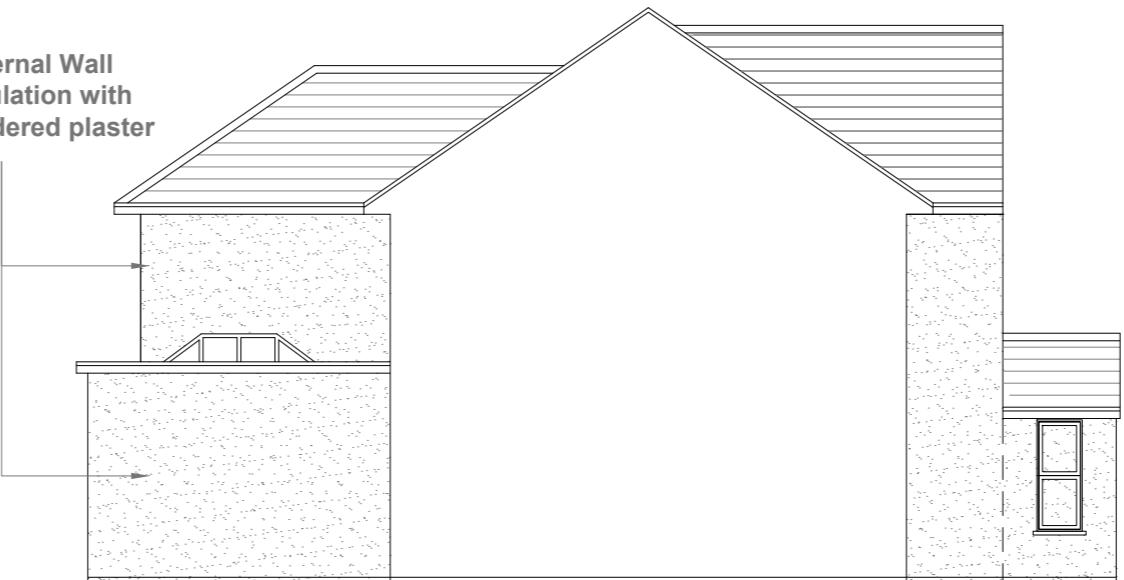

Existing Side Elevation


Scale 1:100

Proposed External Finish
Materials to Match Existing
External Finish Materials

Proposed Flank Wall
Window to be Obscure
Glazed and Non Opening
below 1.7m from FFL

K Rend
SILICONE THIN COAT (TC)

Silicone TC	Primer TC
<p>Silicone TC is a ready to use organic resin render which is applied to provide a low maintenance textured finish. It is available in different textures and a wide variety of colours. Prior to application the substrate should be primed using Primer TC.</p> <p>Requirements:</p> <p>Silicone TC 05: 1.6kg / sq m approx. Silicone TC 10: 1.6kg / sq m approx. Silicone TC 15: 2.5 kg / sq m approx. Silicone TC 30: 5.0 kg / sq m approx.</p> <p>Product classification according to BS EN 15824:2009 Coating Material DIN 18558 - P Org 1 A water-dilutable product for exterior and interior use. Water vapour permeability - Category V2; Water absorption - Category W3; Adhesion - 0.65 MPa; Thermal Conductivity: λ 10, dry (P=50%) = 0.83; λ 10, dry (P=90%) = 0.93; Reaction to fire - Class B-s2,d0 Product Classification (DIN 18558) Coating Material DIN 18558 - P Org 1</p>	

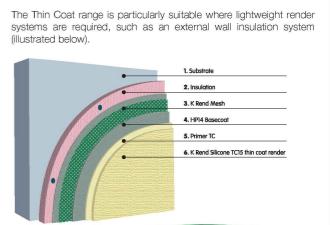

Pearl



All full colour illustrations shown in this brochure are as accurate as the printing process will allow. It is important that a sample is obtained as we recommend colours be verified against K Rend Thin Coat samples before ordering.

1:100 0 1 2 5 10 Meter

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Title:

Existing Elevations

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Cowley.
UB8 3TN

Scale: 1:100 @A3
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2022/106 -06E
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