




Existing Ground Floor Plan
Scale 1:100

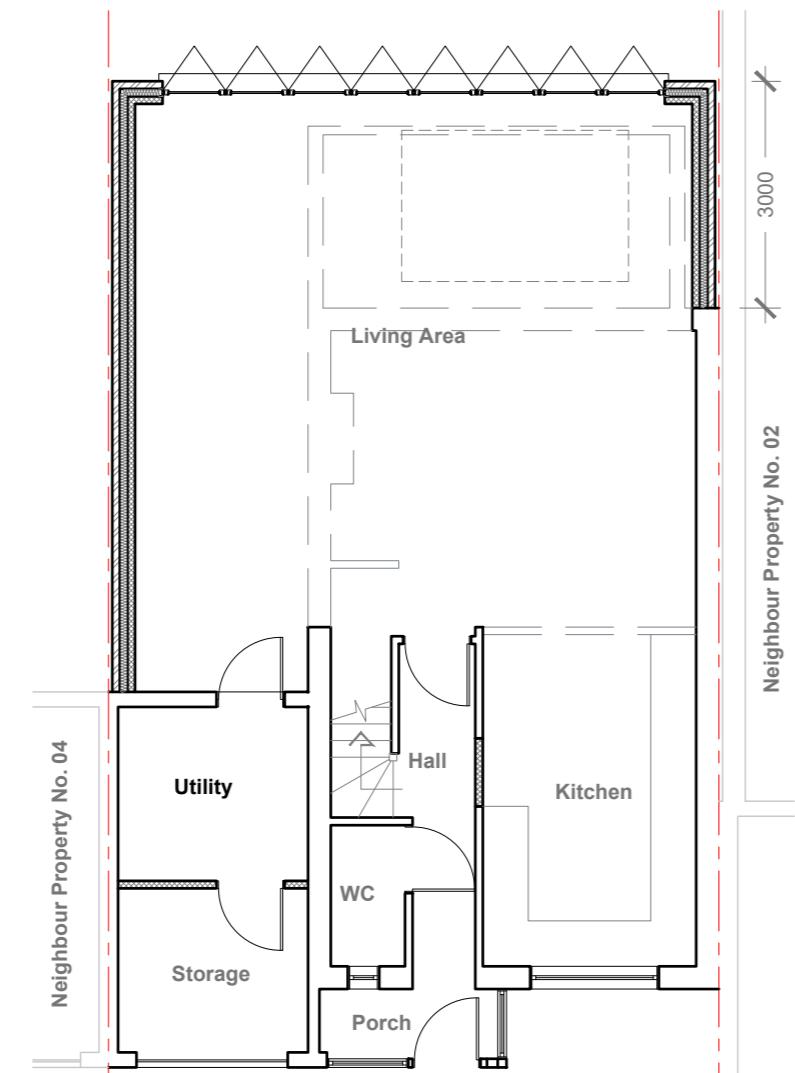


Proposed Ground Floor Plan
Scale 1:100

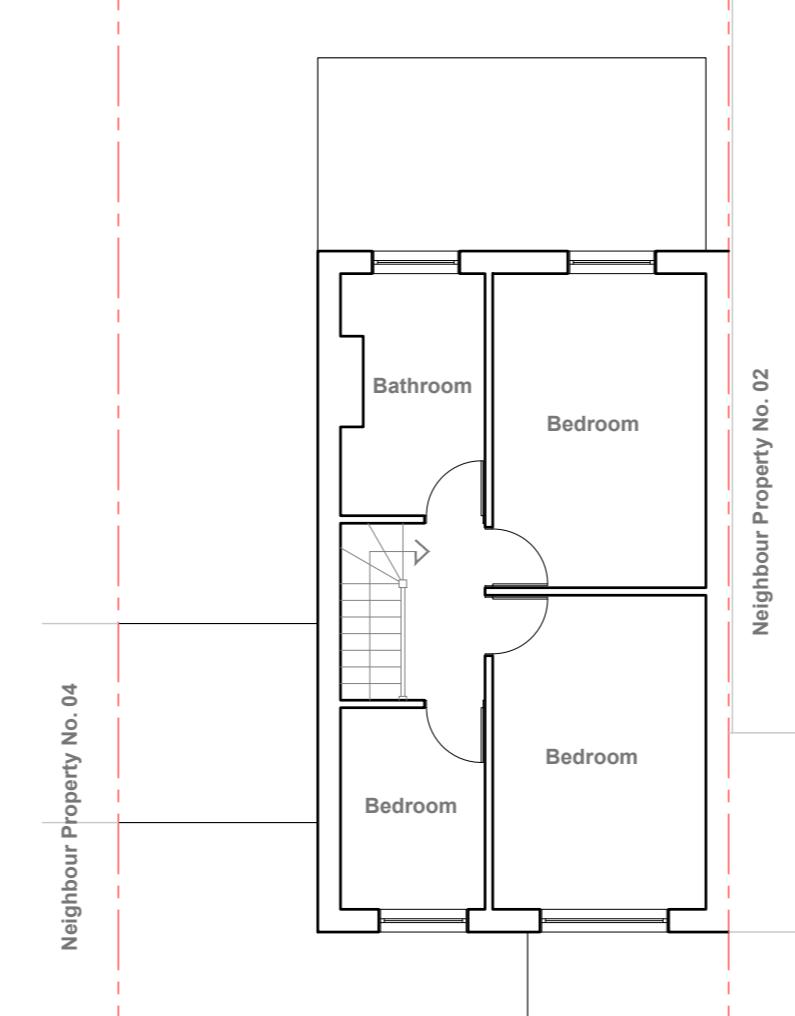

Existing First Floor Plan
Scale 1:100

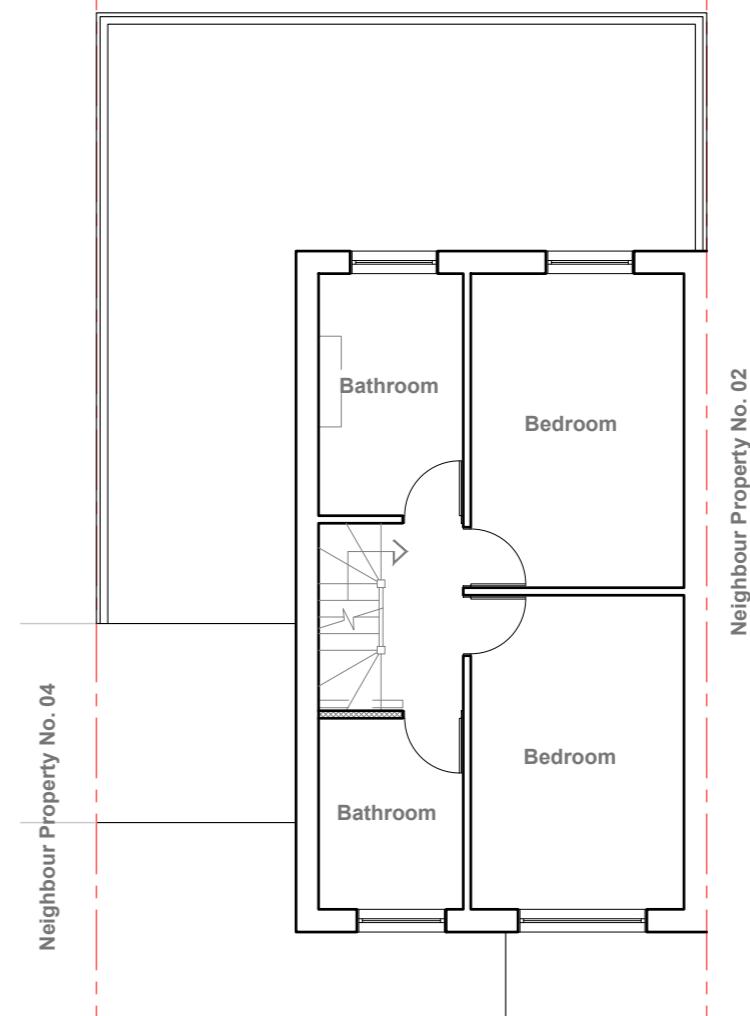

Proposed First Floor Plan
Scale 1:100

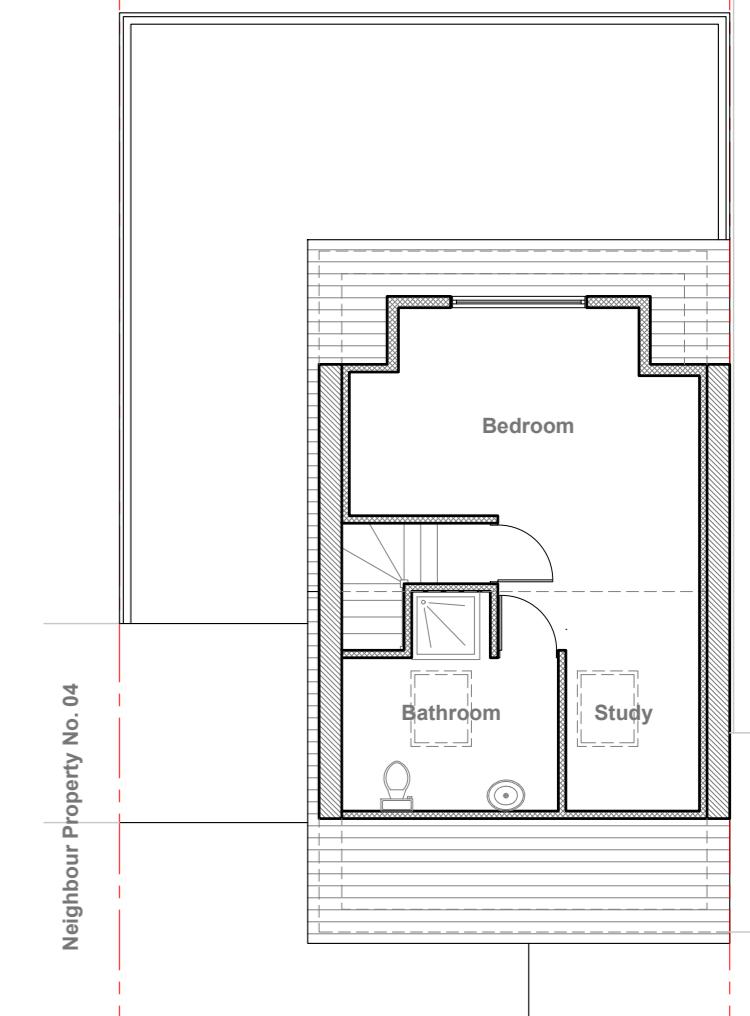


Proposed Loft Plan
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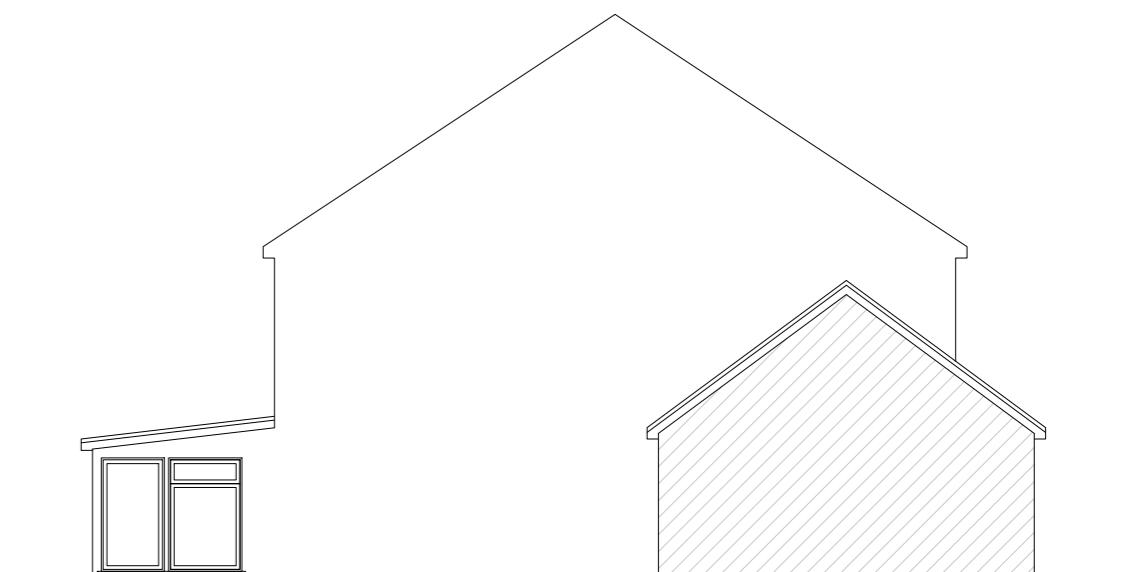
Existing Front Elevation
Scale 1:100



Existing Rear Elevation
Scale 1:100



Existing Side Elevation
Scale 1:100

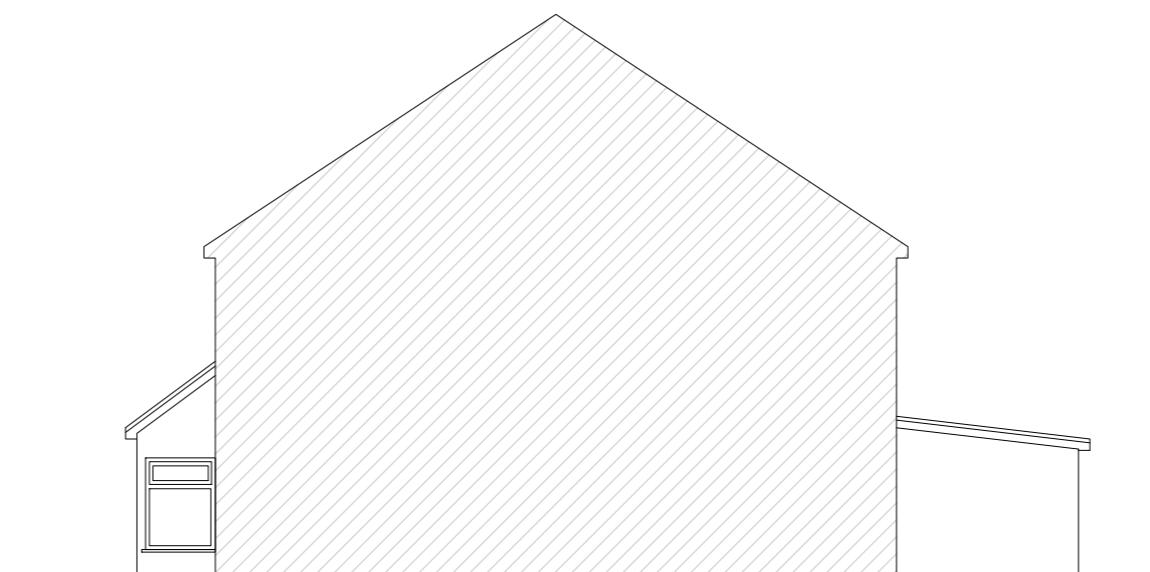


Existing Side Elevation
Scale 1:100




Proposed Front Elevation
Scale 1:100



Proposed Rear Elevation
Scale 1:100

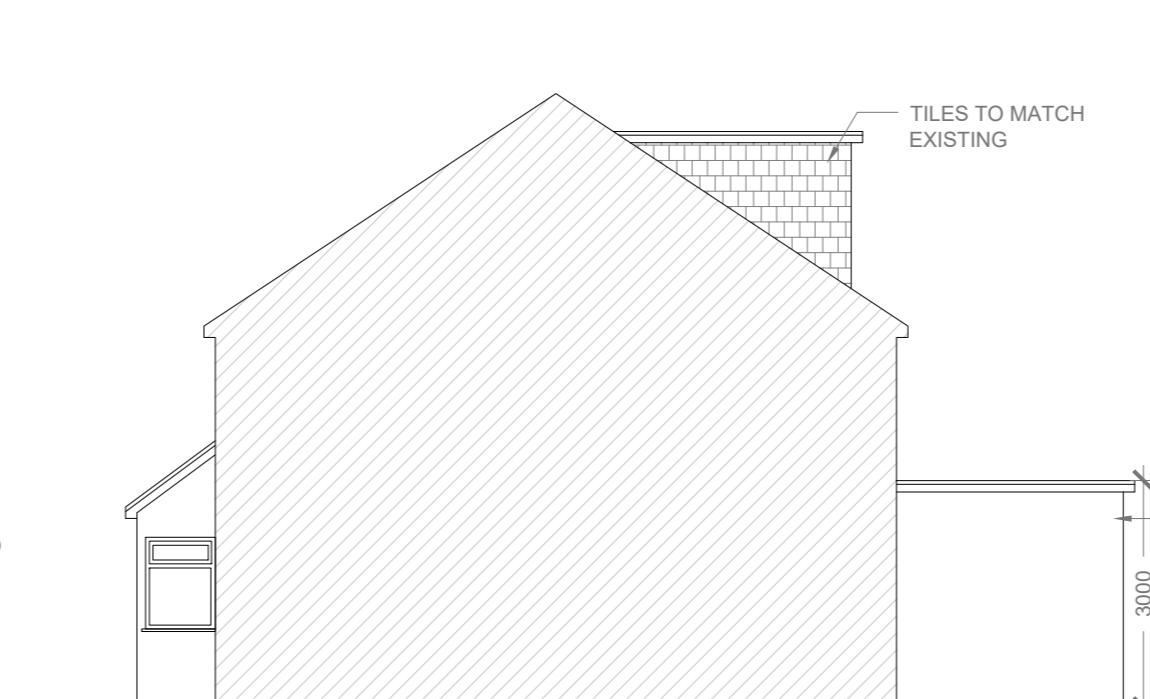

Proposed Side Elevation
Scale 1:100

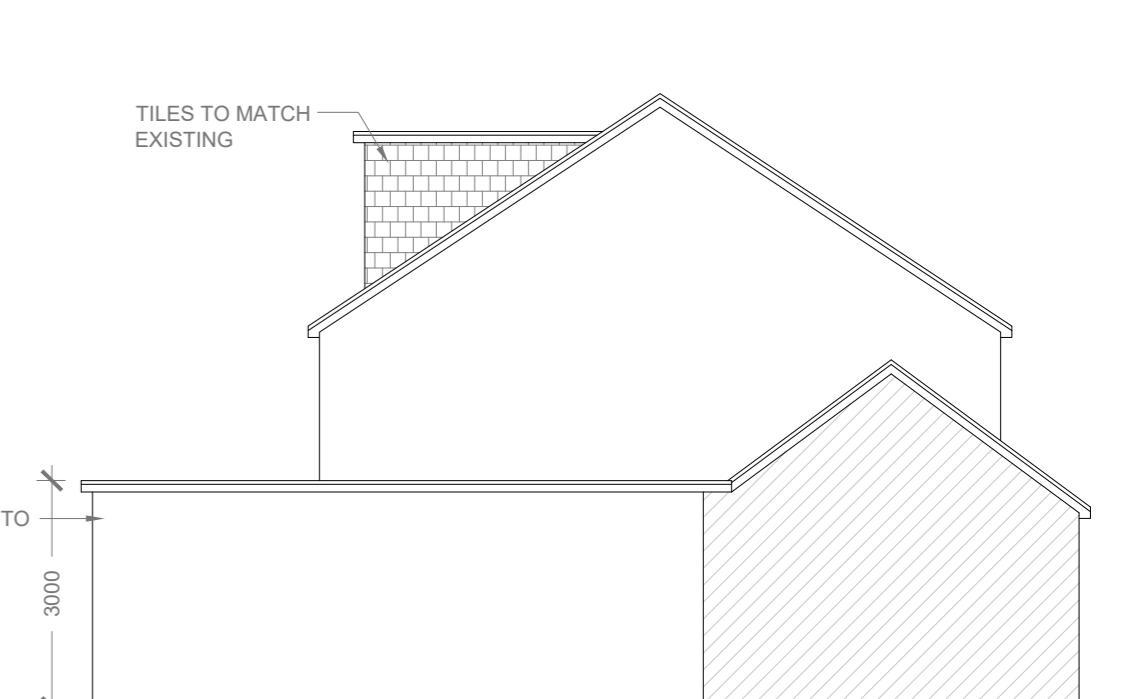

Proposed Side Elevation
Scale 1:100

1:100 0 1 2 5
10 Meter


Notes All plans, sections & elevations are based on measured readings and scaled dimension. Any discrepancies be reported immediately. To be read in conjunction with Structural Engineers' drawings and Mechanical and Electrical drawings All Materials To Match Existing	Revisions	Drawing name Floor Plans and Elevations		Drawing no 4 HH 01	Rev A		
		Project 4 Glenorchy Close, Hayes, UB4 9SU					
		Scale 1:100 @ A1					
Status Planning		T 07462540478 E info@dd2d.co.uk		Detail Design			



Location Plan

Scale 1:1250


A horizontal bar chart showing the distribution of a variable across a 100-meter distance. The x-axis is labeled '100 Meter' and has tick marks at 5, 10, 20, 50, and 100. The bar is divided into four segments: a small black segment from 0 to 5, a medium gray segment from 5 to 20, a long white segment from 20 to 50, a medium gray segment from 50 to 90, and a small black segment from 90 to 100.

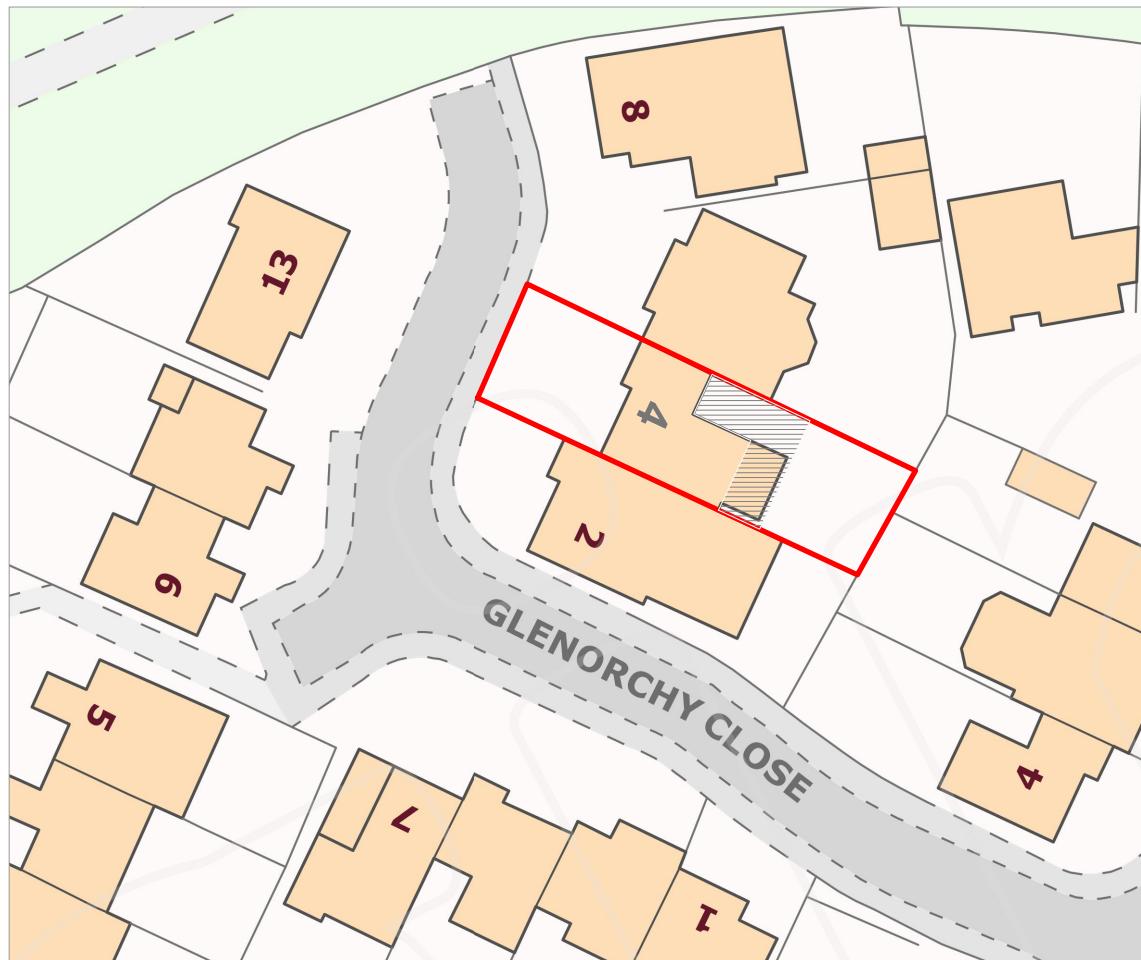

Block Plan

Scale 1:500

1:500 0 10 50 Meter

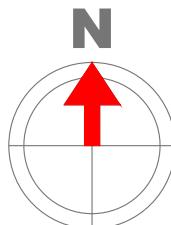

<p>Notes</p> <p>All plans, sections & elevations are based on measured readings and scaled dimension.</p> <p>Any discrepancies be reported immediately.</p> <p>To be read in conjunction with Structural Engineers' drawings and Mechanical and Electrical drawings</p> <p>All Materials To Match Existing</p>	<p>Revisions</p>	<p>Drawing name</p> <p>Proposed - Block Plan Location Plan</p>	<p>Drawing no</p> <p>04 OS 01</p>	<p>Rev</p> <p>A</p>
		<p>Project</p> <p>4 Glenorchy Close, Hayes, UB4 9SU</p>		
		<p>Scale</p> <p>1:500 / 1250 @ A4</p>	<p>Status</p> <p>Planning</p>	