

### VOLUME CALCULATION


#### PROPOSED DORMER

$$\text{Vol} = \frac{2.3 \times 3.4 \times 4.95}{2} = 19.4 \text{m}^3$$

TOTAL VOLUME PROPOSED = 19.4m<sup>3</sup>  
LESS THAN THE 40m<sup>3</sup> ALLOWED UNDER PERMITTED  
DEVELOPMENT FOR LOFT EXTENSIONS




SOUTH WEST ELEVATION

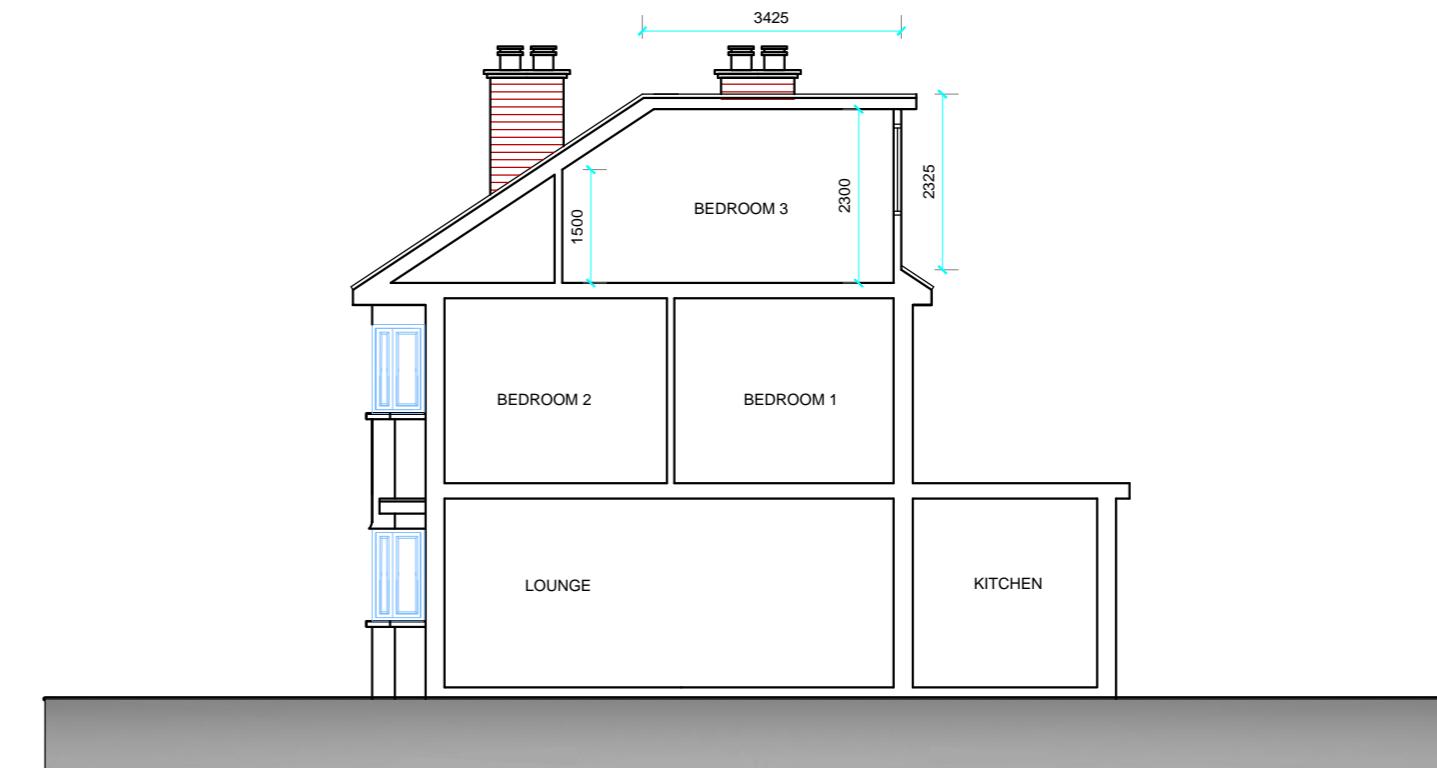

SOUTH EAST ELEVATION



NORTH EAST ELEVATION

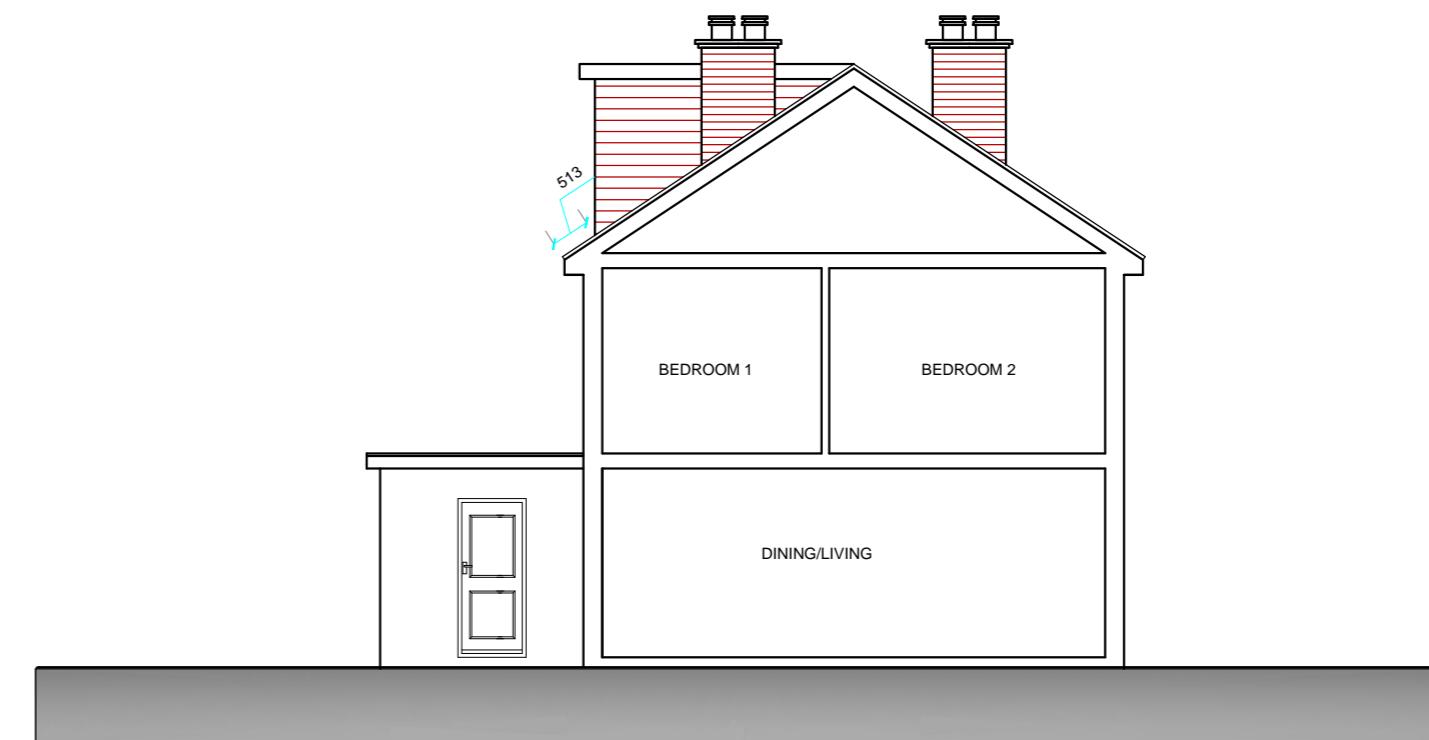

NORTH WEST ELEVATION

PROPOSED ELEVATIONS

51 Ashburton Rd, Ruislip HA4 6AA

Scale Bar

1:100 @ A2  
0 1 2 3 4 5 6 7 8 9 10 Metres



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Drg. No. 22/3500/7  
Scale 1:100  
Date 21/03/22  
Drawn by SB

REVISION  
C  
drawer