
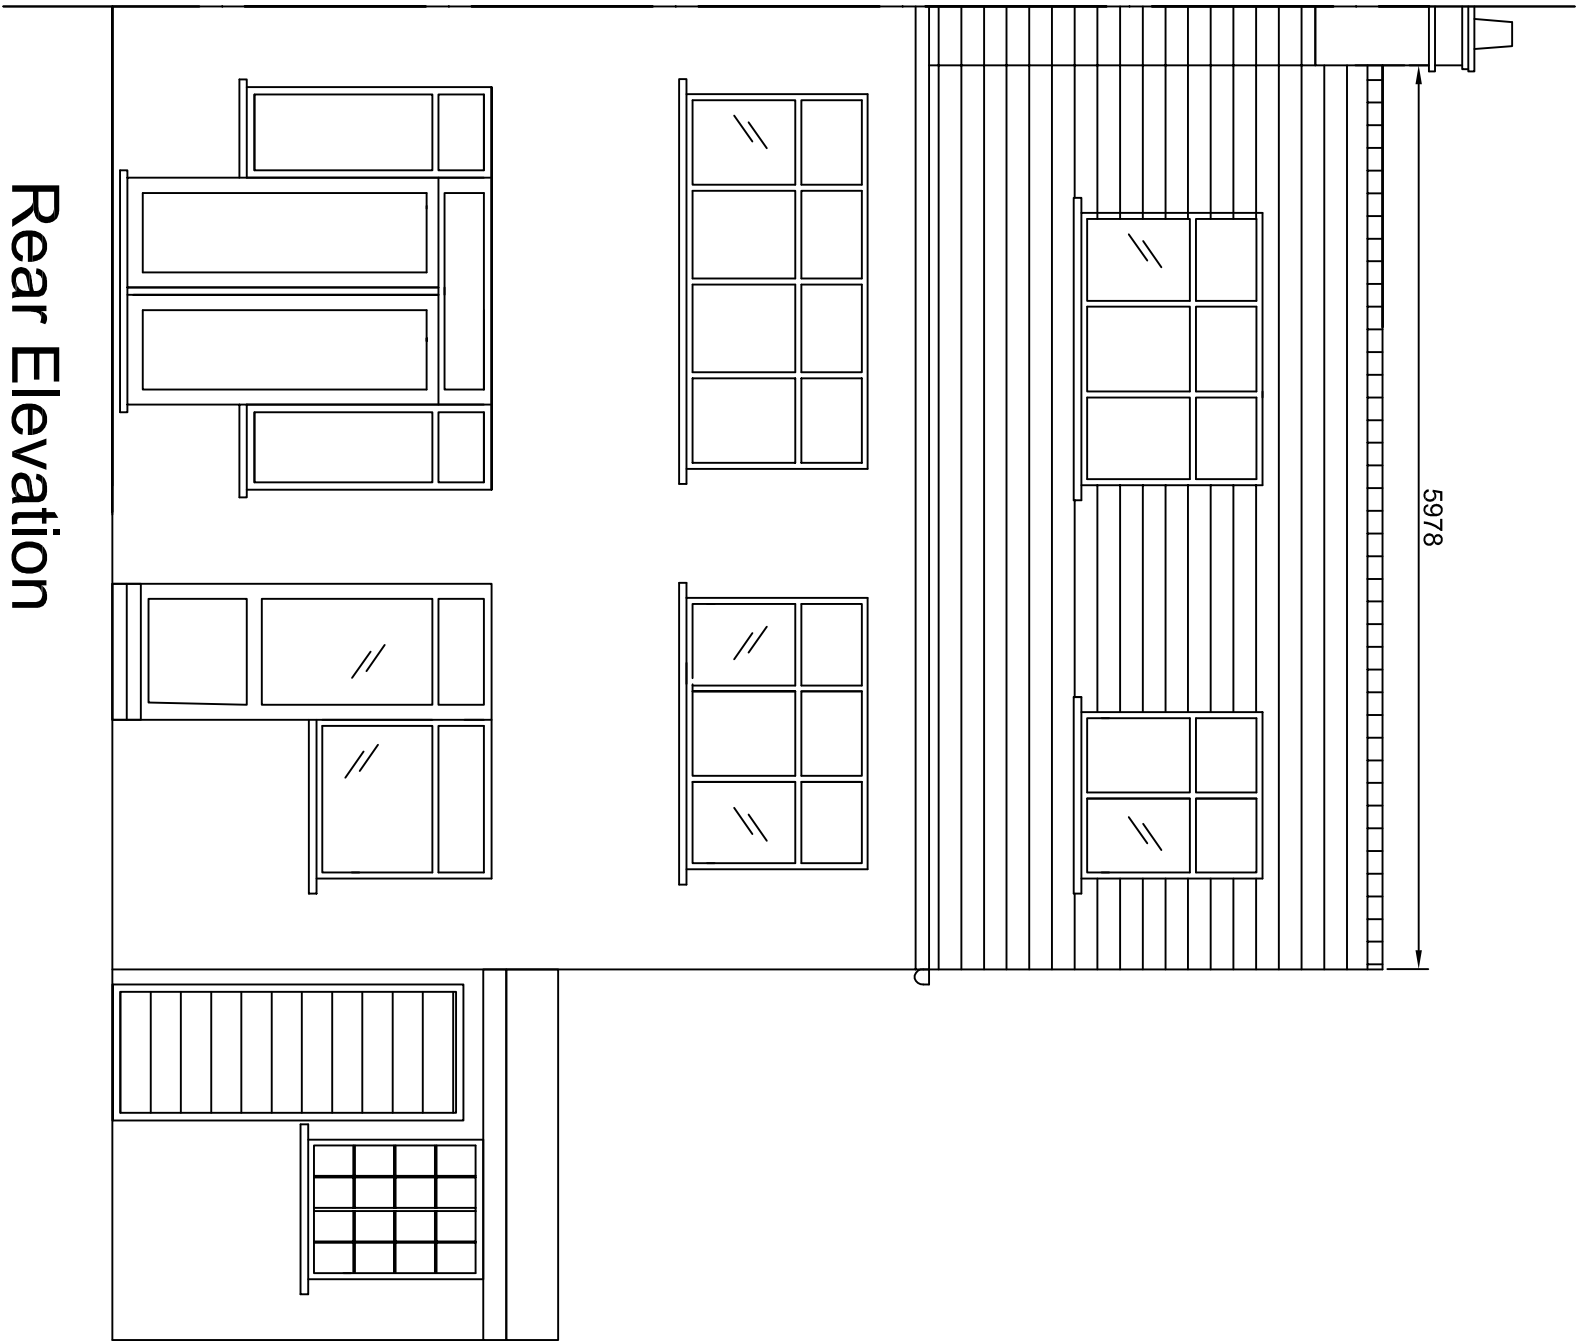


Notes:

All dimensions should be checked with a site survey.


Drawings are subject to statutory authority approval and are to be used for the purpose of planning.

Structural calculations and drawings to be supplied by a structural engineer.

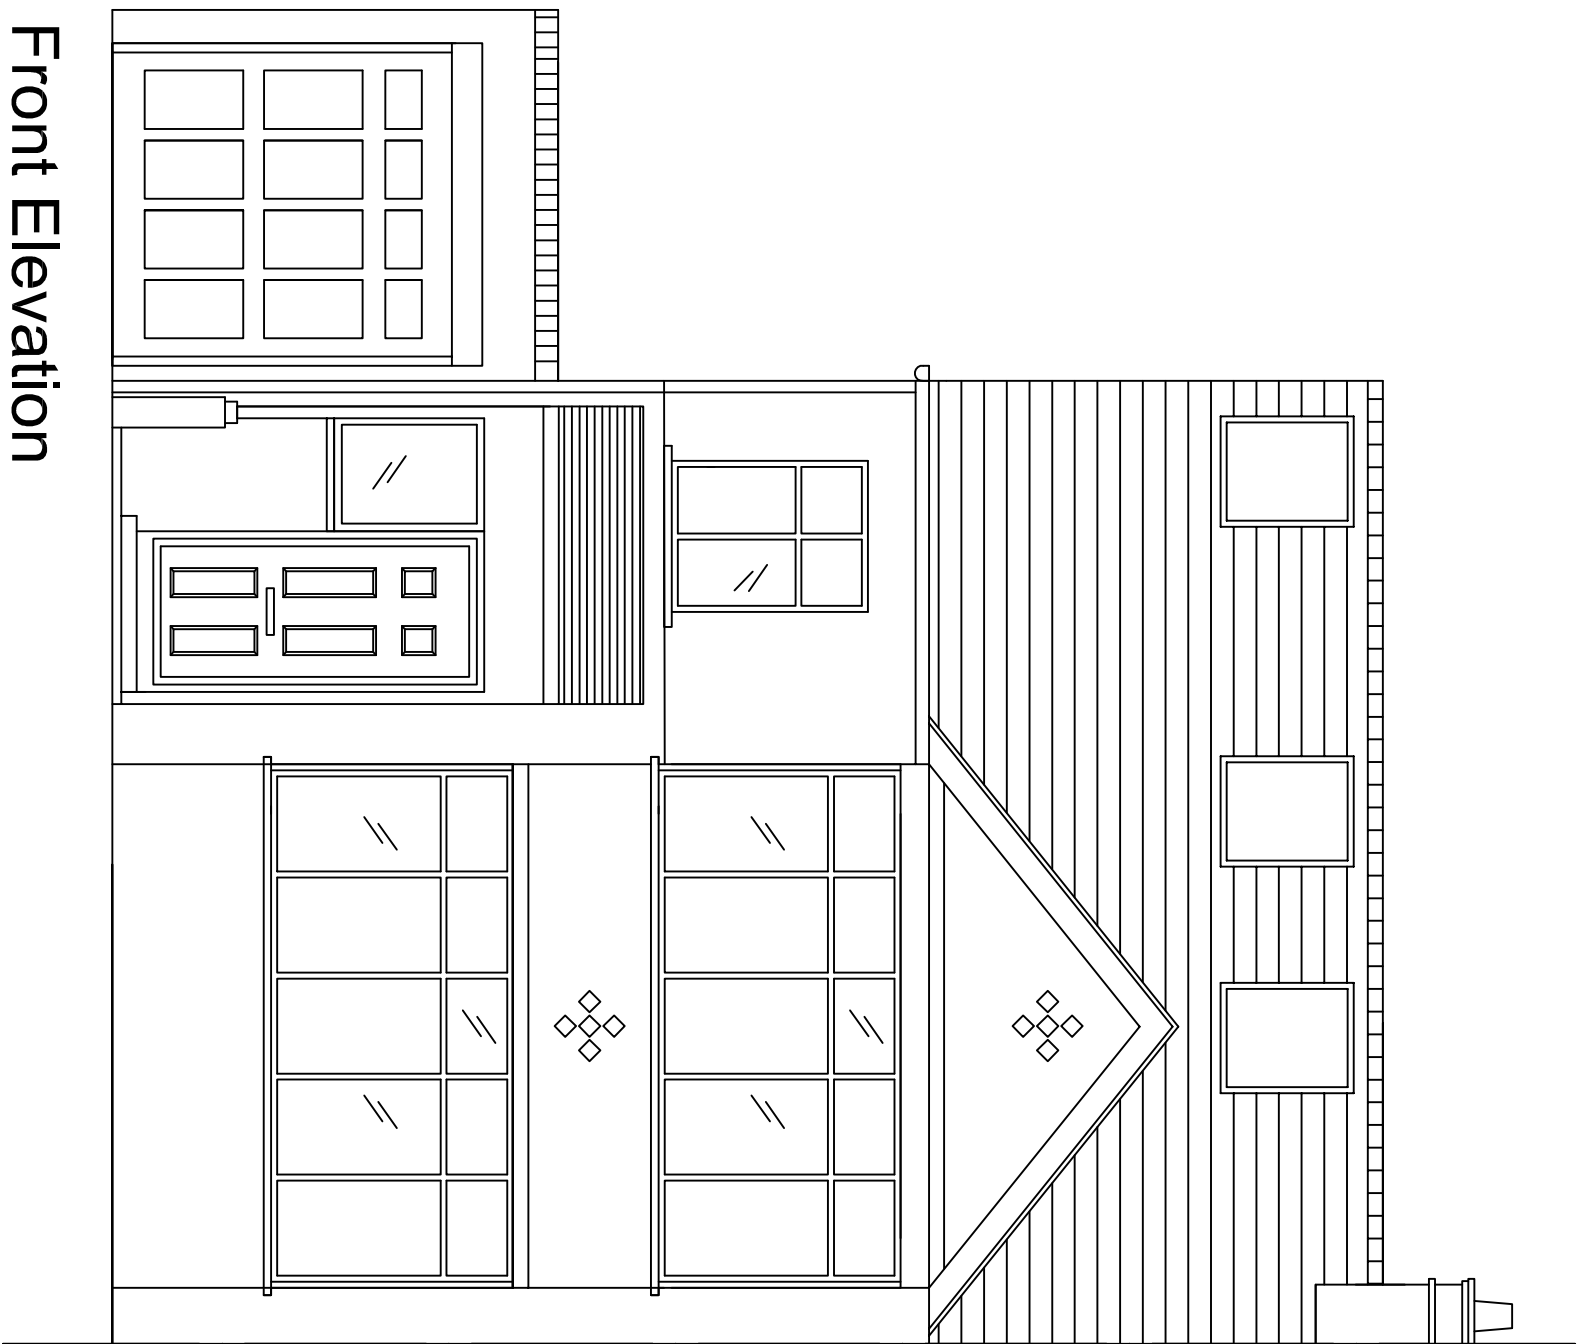


Front Elevation

Rear Elevation

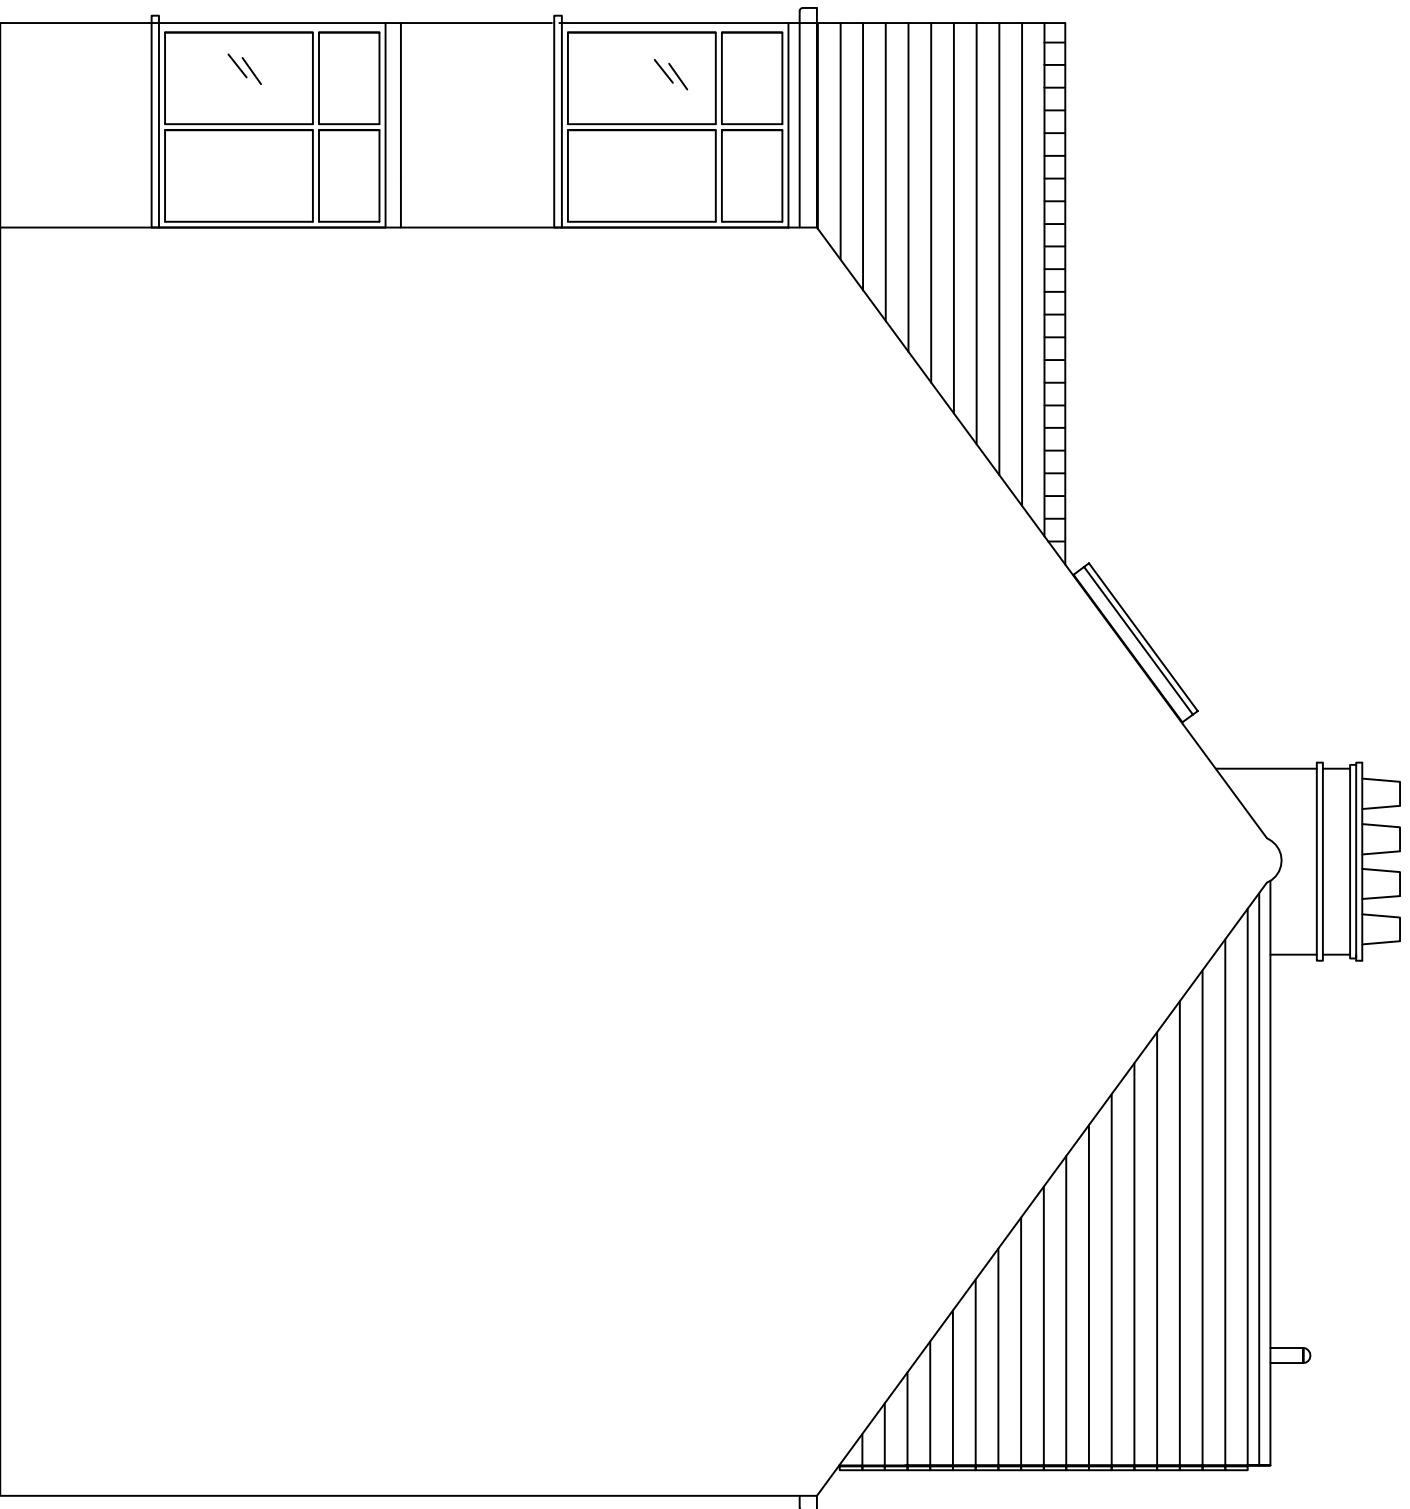


Boundary Elevation

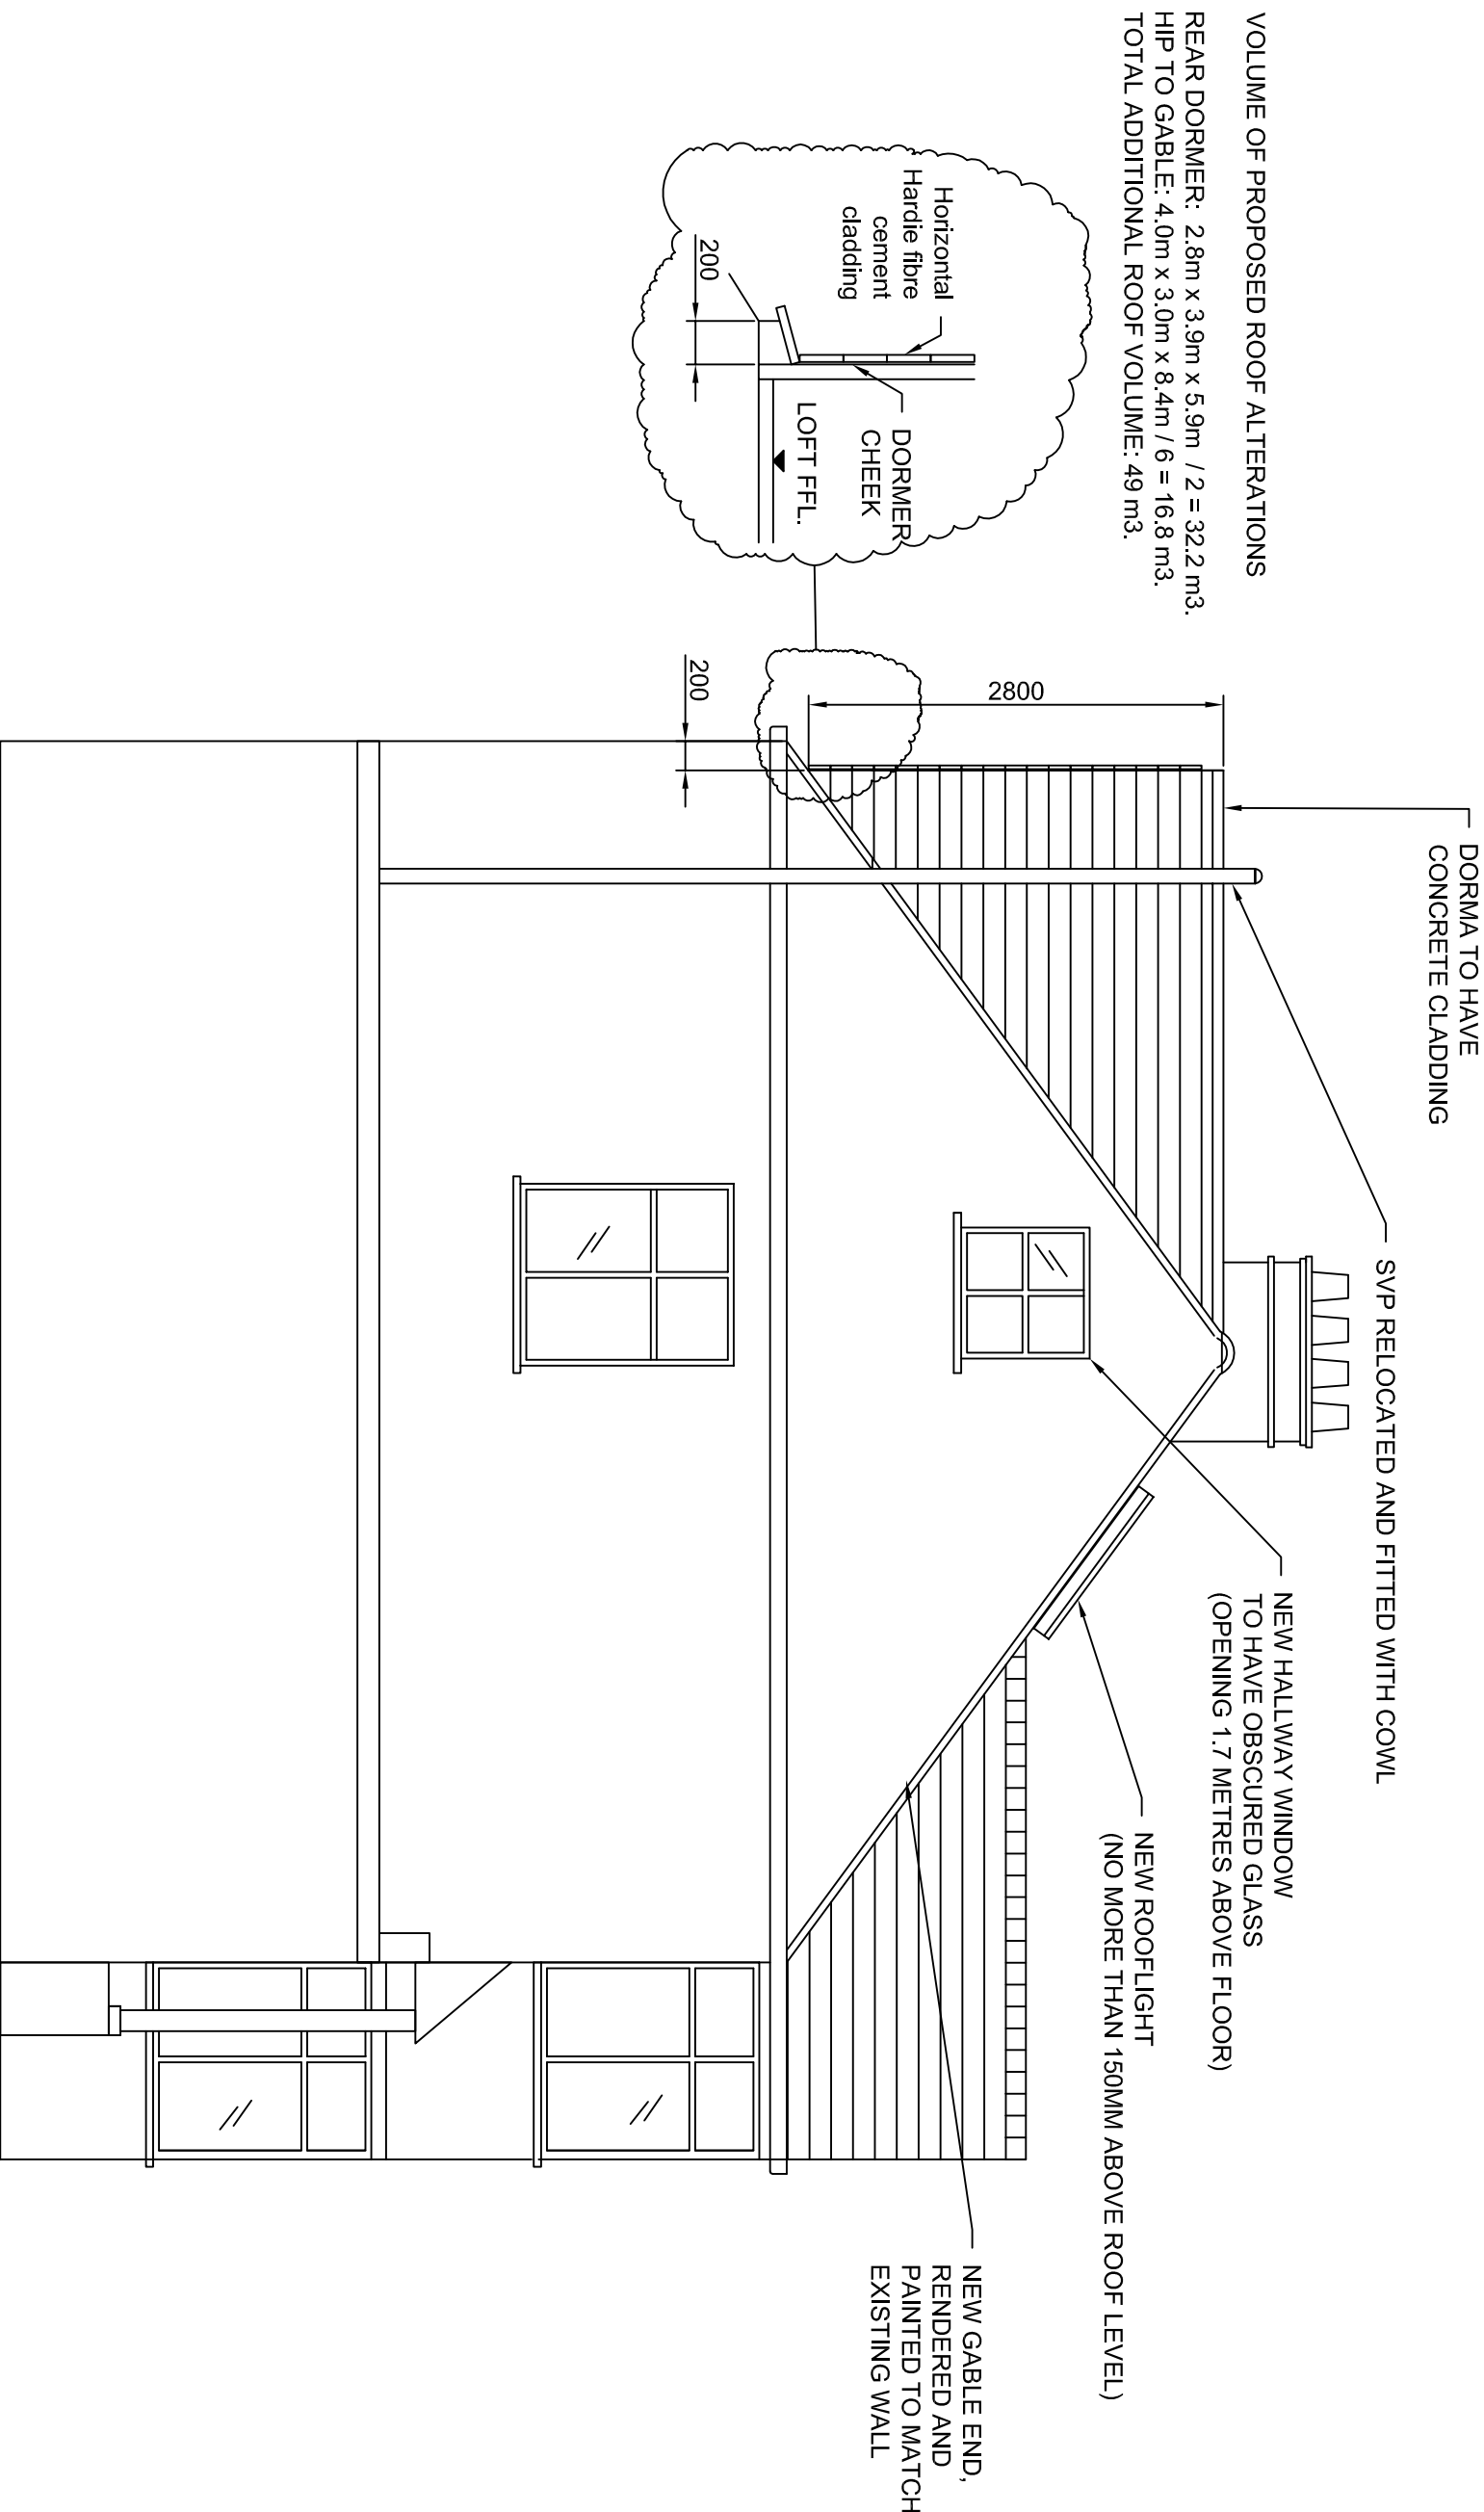

Side Elevation

VOLUME OF PROPOSED ROOF ALTERATIONS
REAR DORMER: 2.8m x 3.9m x 5.9m / 2 = 32.2 m³.
HIP TO GABLE: 4.0m x 3.0m x 8.4m / 6 = 16.8 m³.
TOTAL ADDITIONAL ROOF VOLUME: 49 m³.

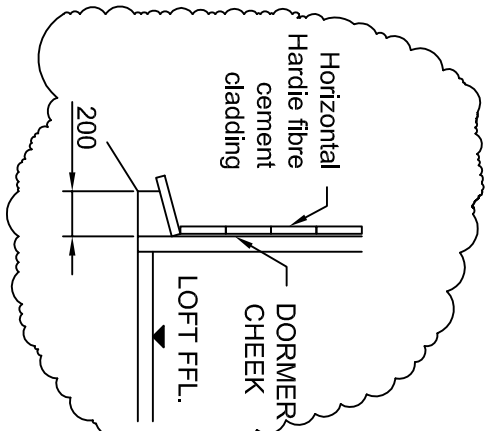


DORMA TO HAVE CONCRETE CLADDING

SVP RELOCATED AND FITTED WITH COWL

NEW HALLWAY WINDOW TO HAVE OBSCURED GLASS (OPENING 1.7 METRES ABOVE FLOOR)

NEW ROOFLIGHT (NO MORE THAN 150MM ABOVE ROOF LEVEL)

NEW GABLE END, RENDERED AND PAINTED TO MATCH EXISTING WALL

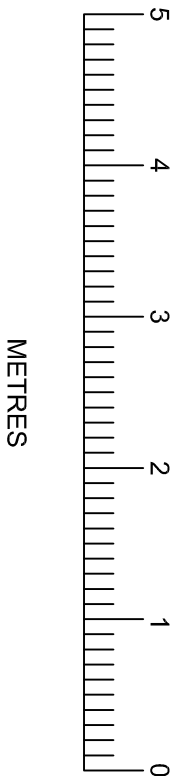

Client :
MR & MRS PIPER
11 CROFT GARDENS
RUISLIP
MIDDLESEX
HA48EY

Drawing Title:
PROPOSED
ELEVATIONS

SCALE: 1:50 @ A1
Drawn by: ML
Drawing no: 101 rev B
Date: 7.1.2022