





Existing Front Elevation.
1 : 100

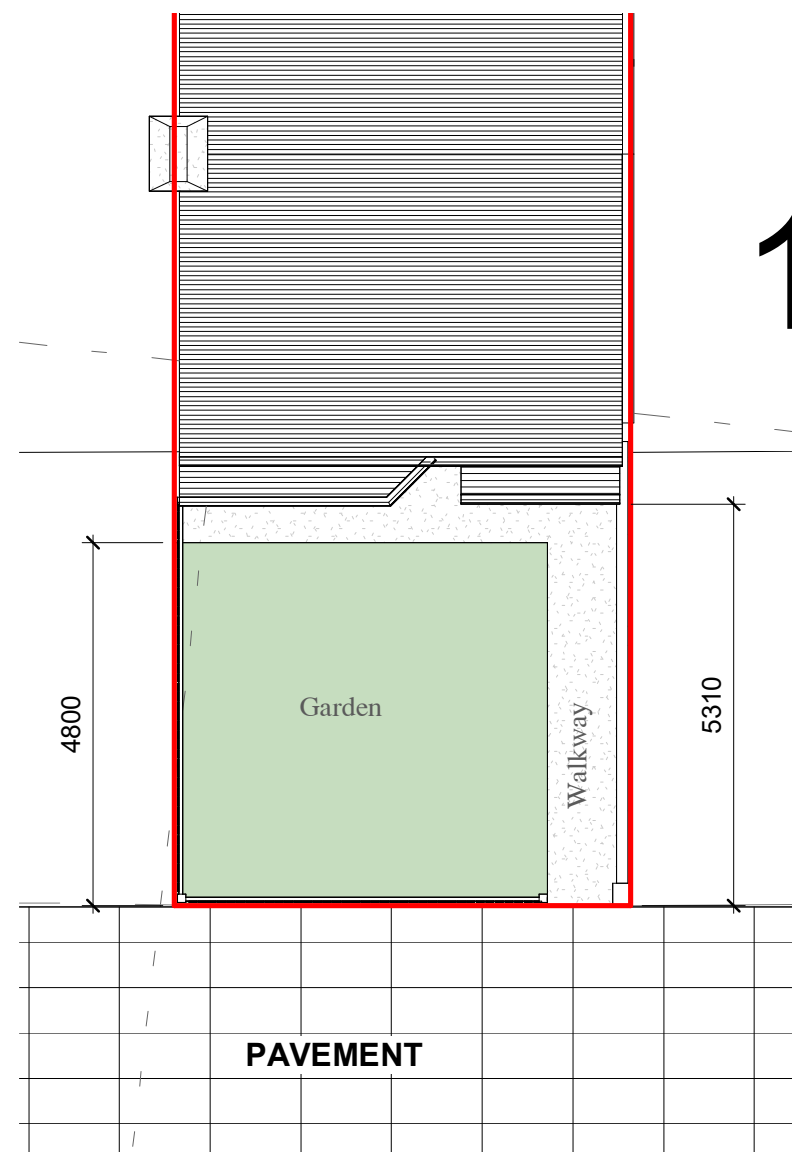


DT

02 EXISTING BLOCK PLAN
1 : 100

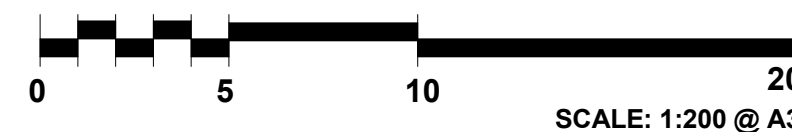

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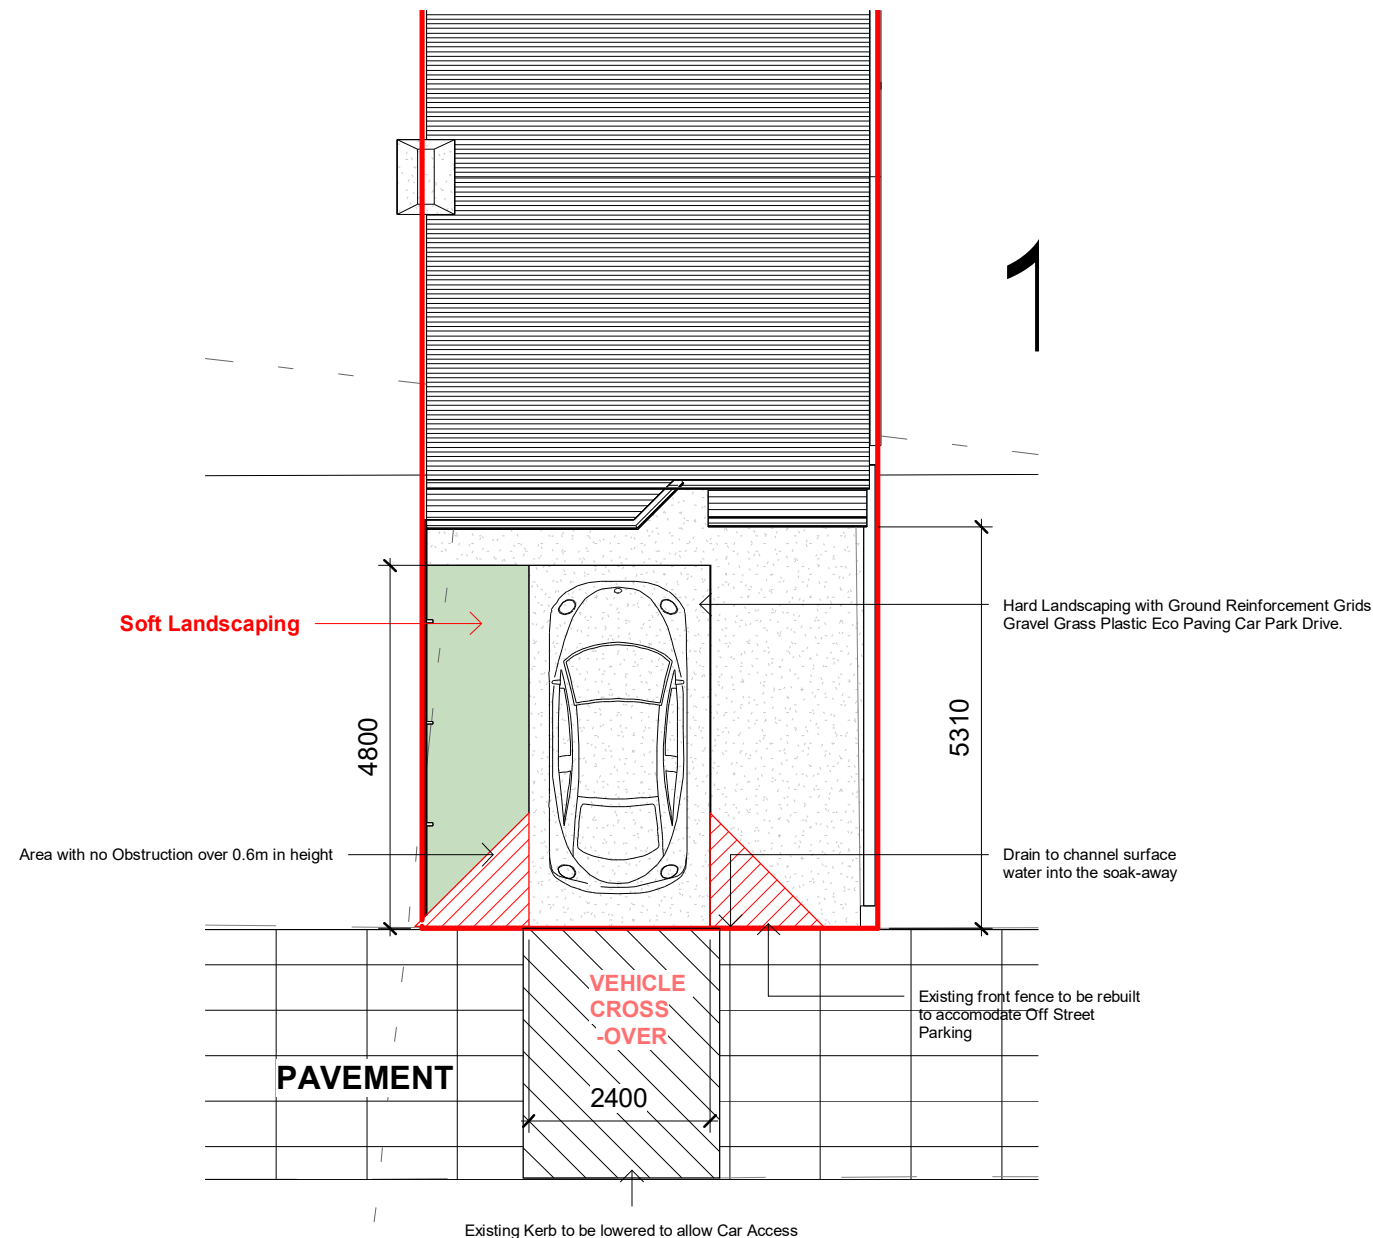
13 DRAYTON
GARDENS WEST
DRAYTON UB7 7LG

EXISTING PLAN

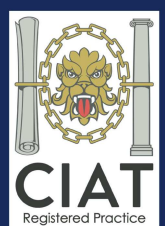Project number	Project Number	22121/14
Date	MAY 2022	
Drawn by	D P.	
Checked by	Checker	Scale 1 : 100



Proposed Front Elevation.
1 : 100



DR

The water will run off towards the footway.
Adequate drainage to be provide to prevent
surface water from spilling from the frontage
onto the highway.

Provide a soak-away with a drainage channel
to collect the surface water in order to prevent it
from spilling onto the highway.

Ground Reinforcement Grids Gravel Grass Plastic Eco Paving Car Park Drive Path

Grid Size : 500 x 500 x 40mm approx. Weight:
1.05kg each grid. High strength (up to 160 t /m²)
Grid Size : 500 x 500 x 40mm approx. Weight:
1.05kg each grid. High strength (up to 160 t /m²)

This interlocking ground and grass
reinforcement product is successfully used in
many applications, including green car parking
areas, overflow car parks, gravel drives,
driveways, private lanes, access roads,
construction sites, greenhouse soakaway, and
as a base for decking, log cabins and garden
sheds.


Tough, flexible and easy to install making
TrueGrid the professional choice for a wide
range of projects. Manufactured from 100%
recycled plastic diverted from landfill, the
environmental and sustainable solution of
choice.

Use water permeable Woven Weed Control
Fabric under pavers for control of weeds and as
a geotextile separator stabiliser. Can be filled
with many materials: soil, grass turf, gravel,
stones, and sand.

Surface reinforcement with natural drainage.
Minimal maintenance. Up to 16 tons axle load
(on suitable base). 35mm ground spikes resist
lateral forces caused by vehicles

02 PROPOSED BLOCK PLAN

1 : 100

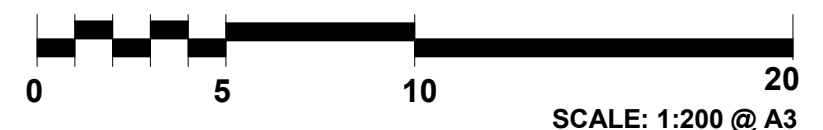

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GARDENS WEST
DRAYTON UB7 7LG

PROPOSED CROSSOVER

Project number	Project Number	22121/15 - A
Date	MAY 2022	
Drawn by	Author	
Checked by	Checker	Scale 1 : 100



EXISTING 3D



PROPOSED 3D



13 DRAYTON
GARDENS WEST
DRAYTON UB7 7LG

PROPOSED 3D		
PLANNING USE ONLY		22121/16
Date	MAY 2022	
Drawn by	D P.	
Checked by	Checker	Scale



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