


Existing Ground Floor Plan
Scale 1:100

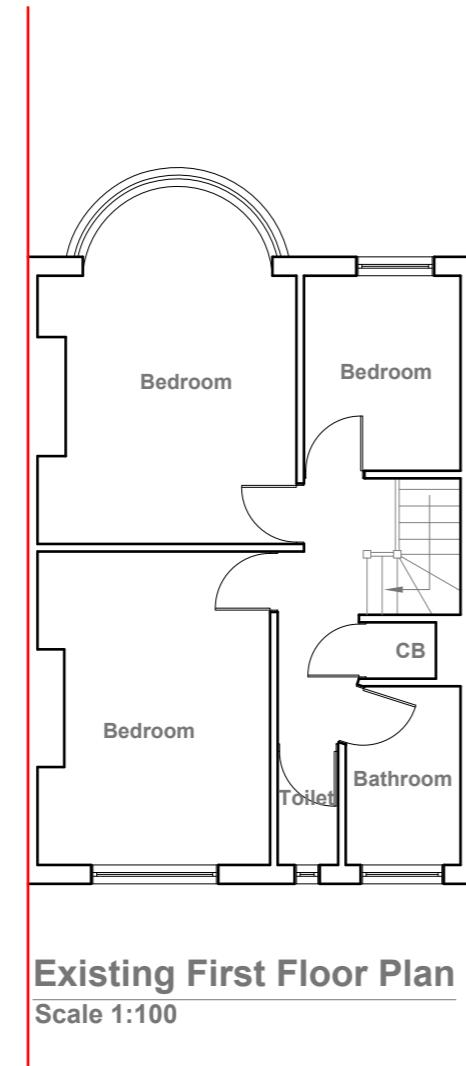

Existing First Floor Plan
Scale 1:100



Existing Front Elevation
Scale 1:100



Existing Rear Elevation
Scale 1:100



Existing Side Elevation
Scale 1:100



Existing Side Elevation
Scale 1:100


GENERAL NOTES:
 1. ALL DIMENSIONS ARE IN MILLIMETER.
 2. VERIFY ALL DIMENSIONS AND CONDITIONS BEFORE BUILDING OR
 STARTING CONSTRUCTION. NOTIFY THE DESIGNER IMMEDIATELY OF ANY
 DISCREPANCY OR VARIATION.
 3. ALL WORK TO COMPLY WITH CURRENT BUILDING REGULATIONS
 AND CODES OF PRACTICE

Title:

Existing Floor Plans and Elevations

Site Address	Scale: 1:100 @A3	Revision Date:
52 Cornwall Road, Ruslip, Middlesex HA4 6AN	Date: 10/09/2021	
	Drawing No.:	
	2021/135-01	
	Drawn By:	
	DP	
	e:mail - faluckpatel@yahoo.com (M) +44 (0) 7871 466 254	


10 Meter
5
2
1
0
1:100

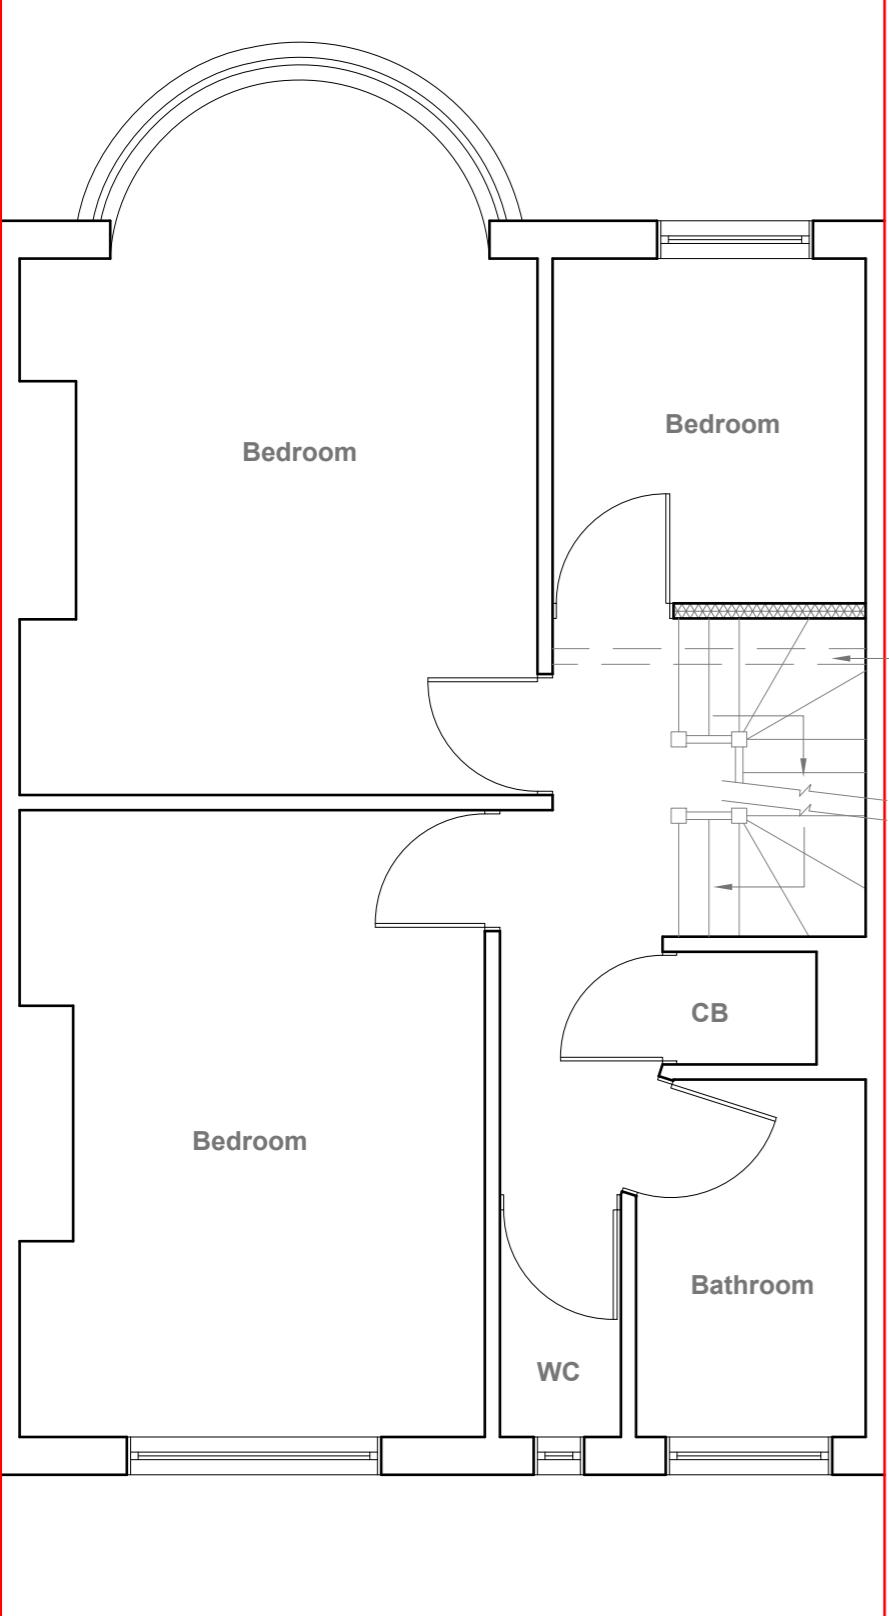

Proposed First Floor Plan

Scale 1:50

provide 2m headheight
between two Staircases
(If not Existing Wall to
be moved to get 2m
clear headheight)

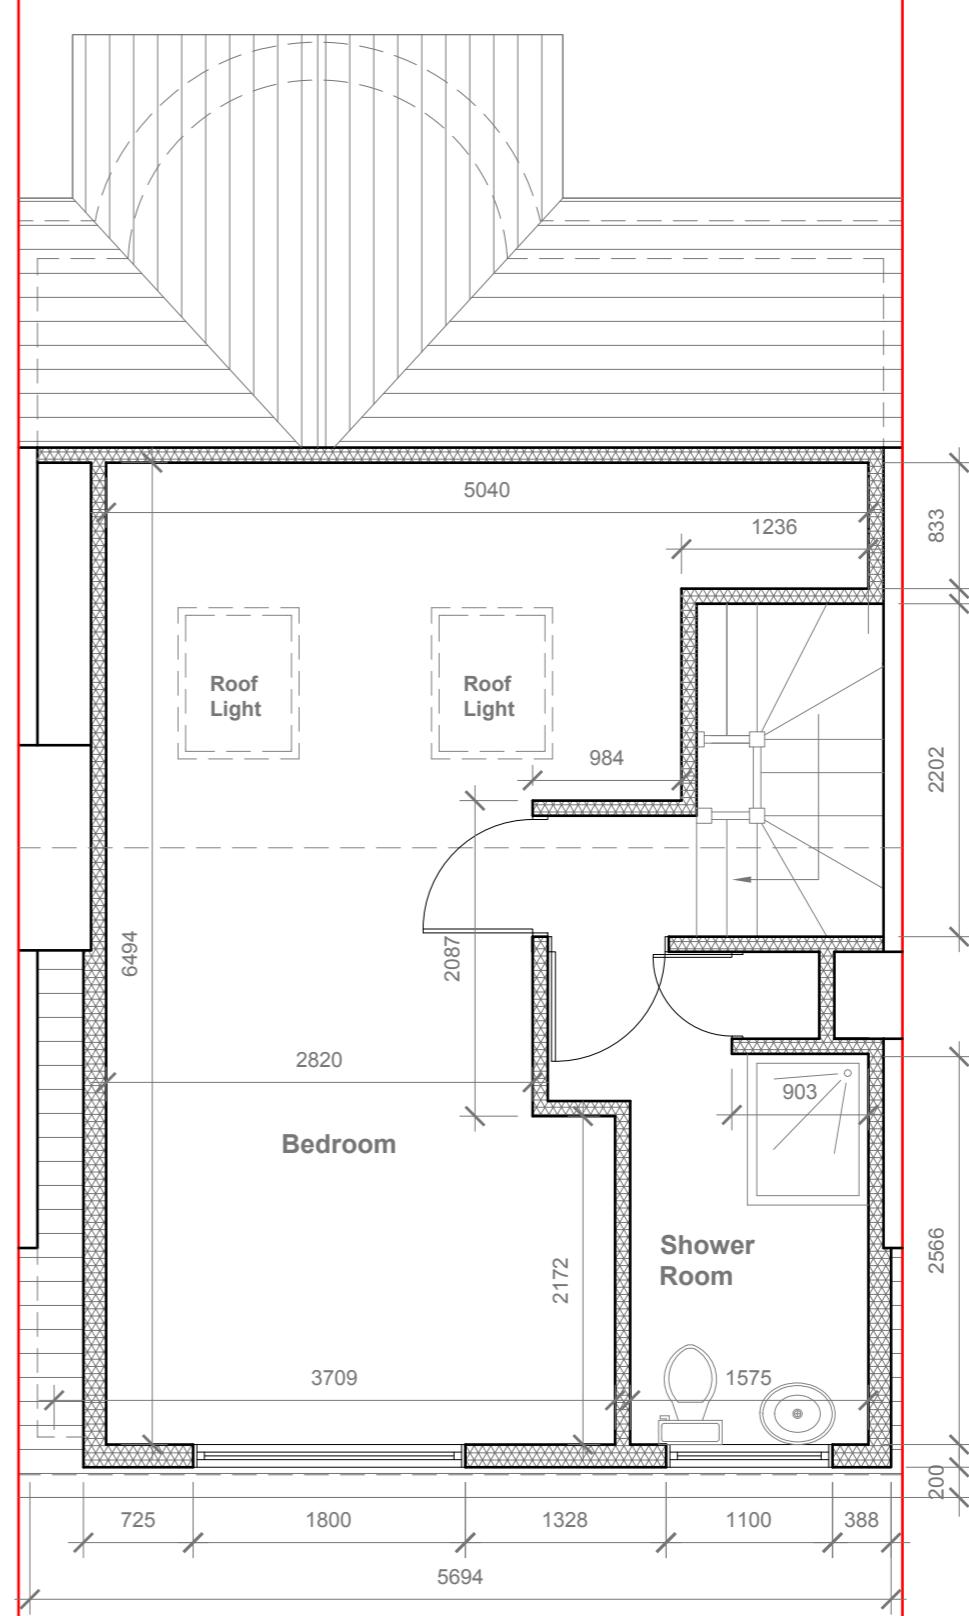

Proposed Loft Plan

Scale 1:50

Velux Window to be installed as per manufacturer specification, not projected more than 150mm from the plane of roof slop

5 Meter

GENERAL NOTES:

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3. ALL WORK TO COMPLY WITH CURRENT BUILDING REGULATIONS AND CODES OF PRACTICE

Title

Proposed First Floor & Loft Plans

Site Address	Scale: 1:50 @A3	Revision Date:
52 Cornwall Road, Ruslip, Middlesex HA4 6AN	Date: 10/09/2021	
	Drawing No.:	
	2021/135 -02	
	Drawn By:	
	DP	e:mail - faluckpatel@yahoo.com (M) +44 (0) 7871 466 254



Proposed Front Elevation

Scale 1:100



REAR DORMER VOLUME =


$W \times H \times L / 2$
 $5.694 \times 3.266 \times 4.097 / 2$
 $76.19 / 2$
 $38.09 \text{ CU.MT} < 40.00 \text{ CU.MT.}$

$V =$



Proposed Rear Elevation

Scale 1:100

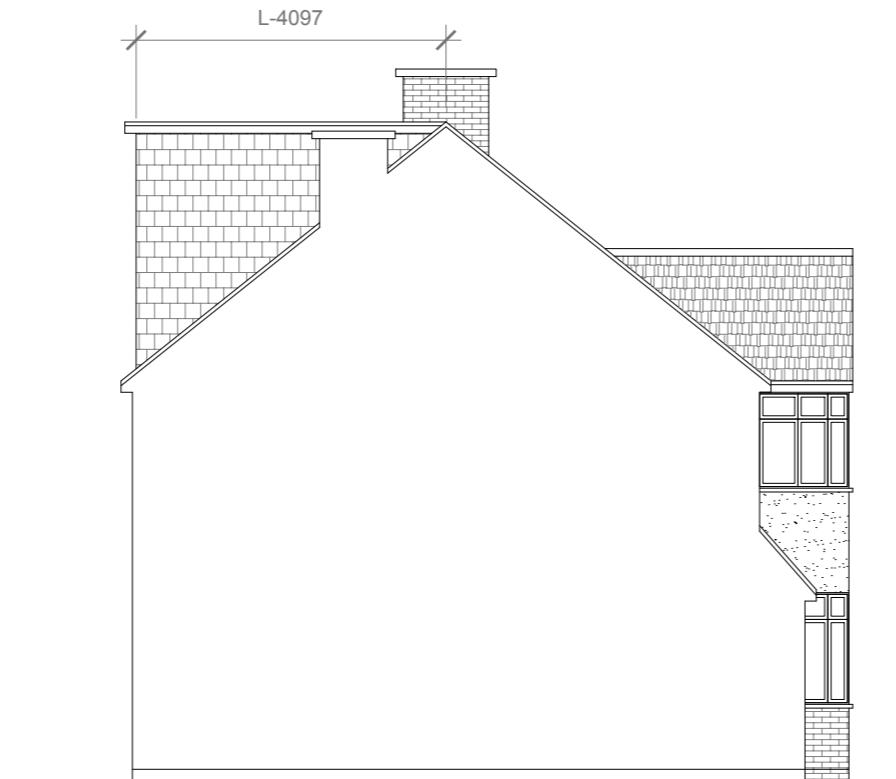

Proposed Side Elevation

Scale 1:100

GENERAL NOTES:

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Title:

Proposed Elevations

Site Address

52 Cornwall Road,
Ruslip,
Middlesex
HA4 6AN

Scale: 1:100 @A3

Date: 10/09/2021
Drawing No.: 2021/135 -03

Revision Date:

Drawn By:
DP
e:mail - faluckpatel@yahoo.com
(M) +44 (0) 7871 466 254

10 Meter
5
5
2
1
0
1:100

Faluck Patel