

ns to be verified on site
SCALE FROM THIS DRAWING.
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tant Ltd

Address:

Goshawk Gardens,
es,
8LD

Block and Location Tables

e: 1:500, 1:1250

Size:

Date	Comments
------	----------

100



Block Plan


metres 1:500 scale



Site Location

A scale bar for 1:1250 scale, showing 0 to 50 metres. The scale bar is marked at 0, 10, 20, 30, 40, and 50. Below the scale bar, the text 'metres 1:1250 scale' is written.

Drawn By: VG
Job Ref: 22080
Date: Aug- 2024
Drawing No. LW- 01

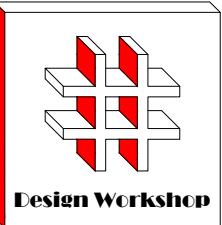

Dimensions to be verified on site
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Site Address:

105, Goshawk Gardens,
Hayes,
UB4 8LD


Title:

Existing First floor plan and
Proposed First floor and Loft Plan

Scale: 1:50, 1:100


Paper Size: A3

Rev Date Comments

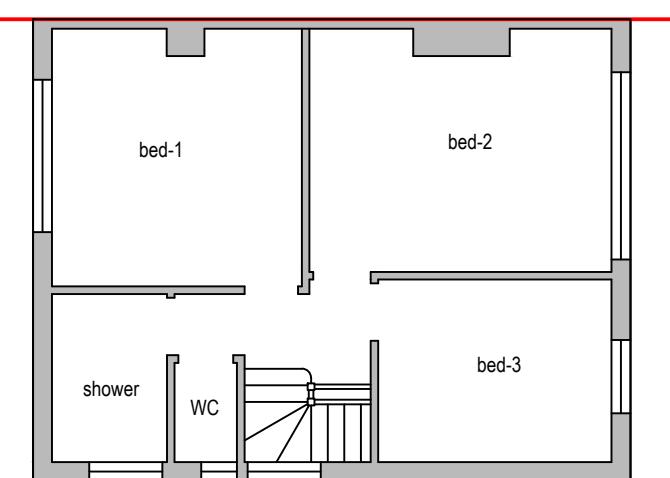


Existing First Floor Plan

0 1 2 3 4 5
metres 1:100 scale

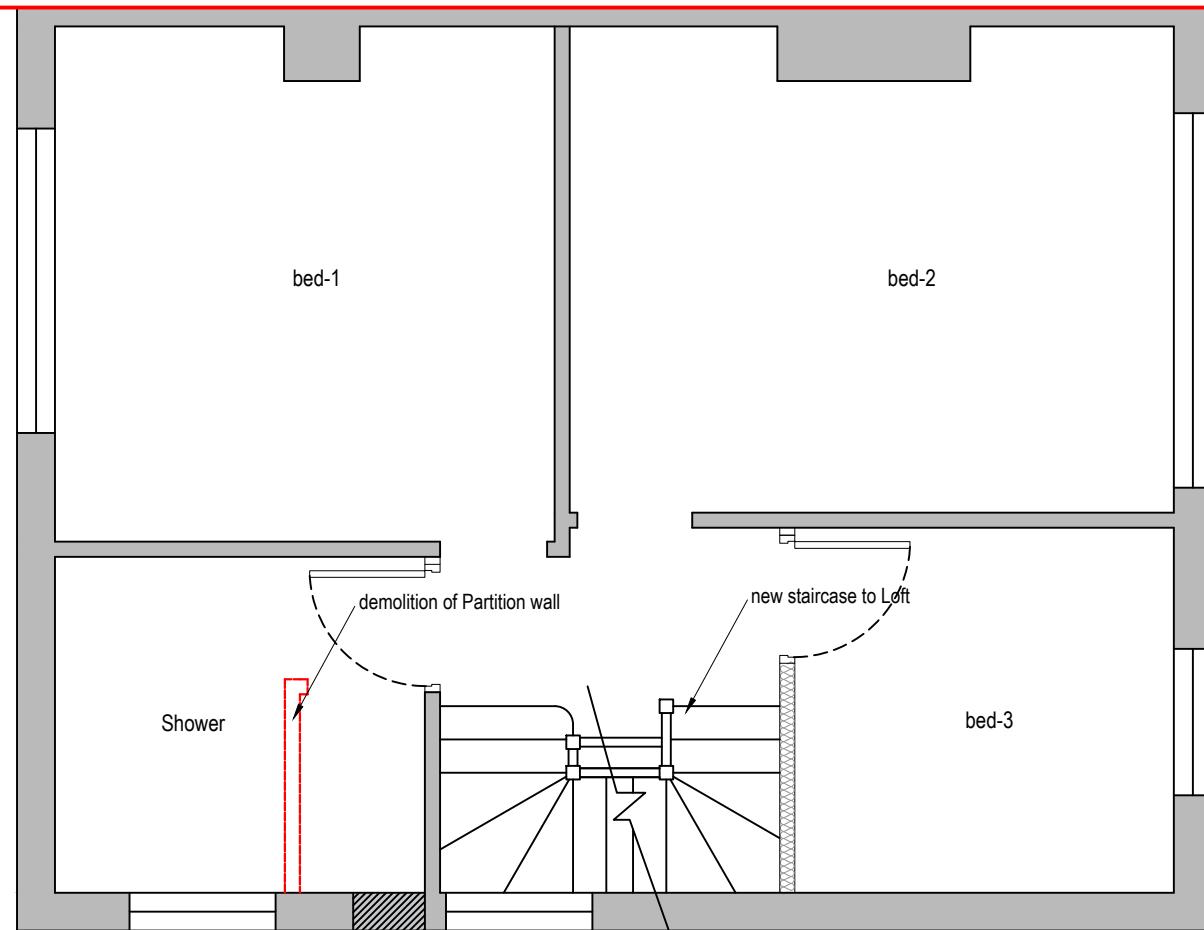

Proposed First floor Plan

0 0.5 1.0 1.5 2.0 2.5
metres 1:50 scale

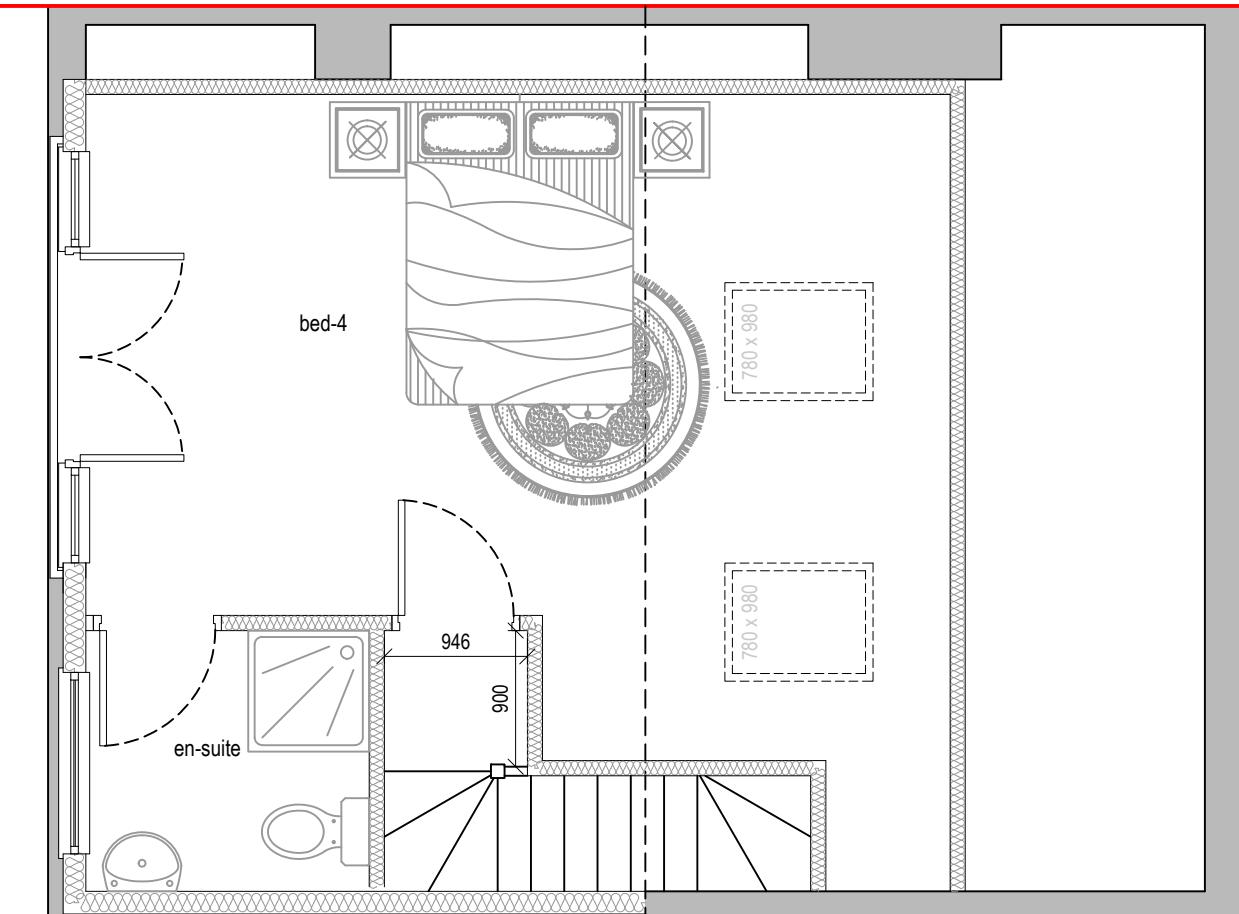

Proposed Loft floor Plan

0 0.5 1.0 1.5 2.0 2.5
metres 1:50 scale

Drawn By: VG

Job Ref: 22080

Date: Aug- 2024

Drawing No. LW- 02



Design Workshop

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Site Address:

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Hayes,
UB4 8LD


Title:

Existing Elevations

Scale: 1:100

Paper Size: A3

Rev	Date	Comments

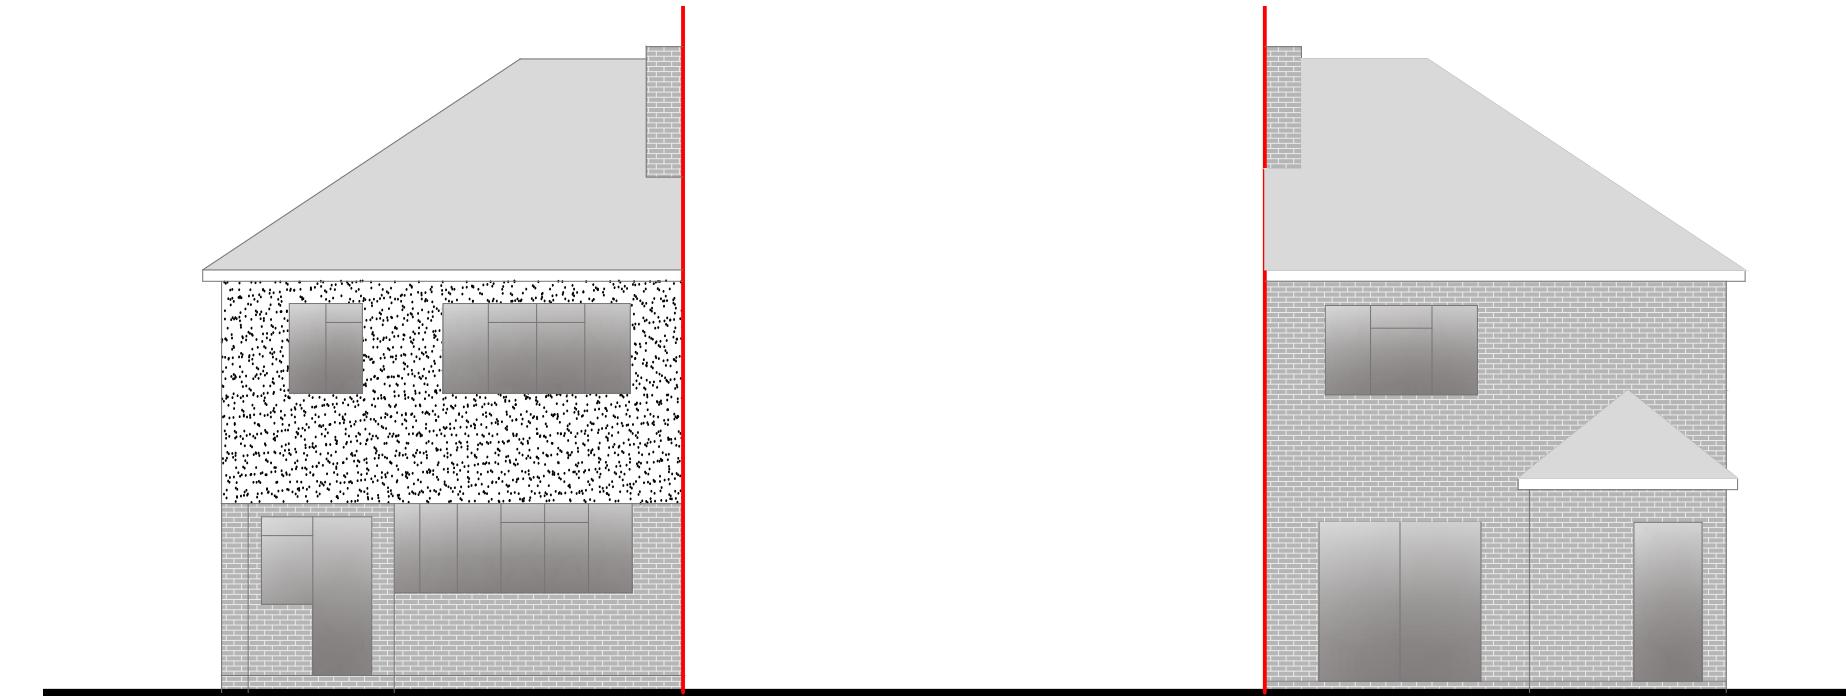


Front Elevation

0 1 2 3 4 5
metres 1:100 scale


Rear Elevation

0 1 2 3 4 5
metres 1:100 scale

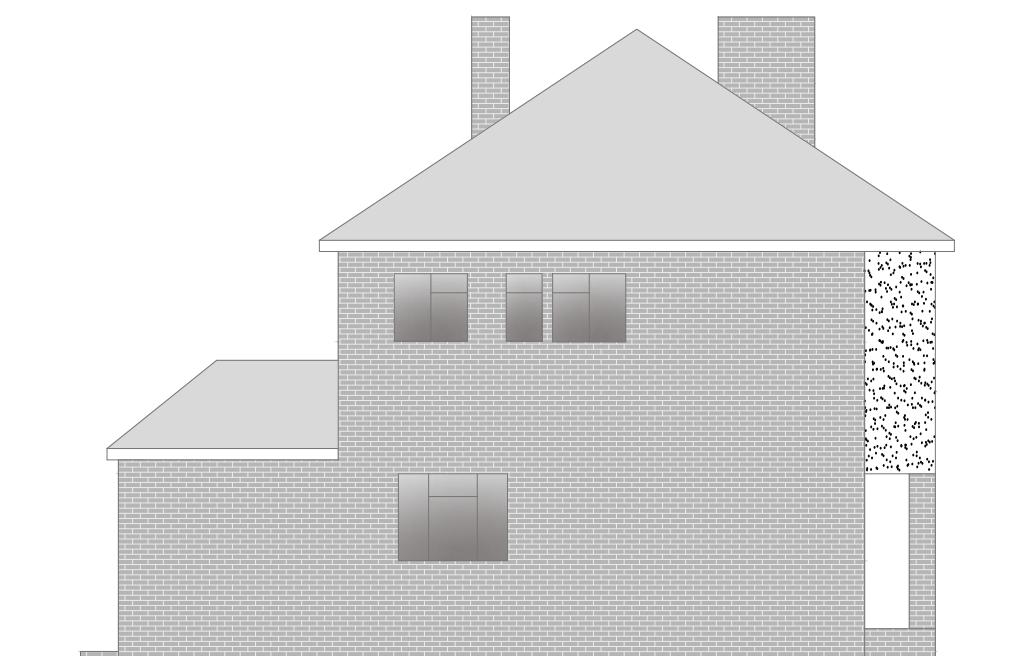

Side Elevation


0 1 2 3 4 5
metres 1:100 scale

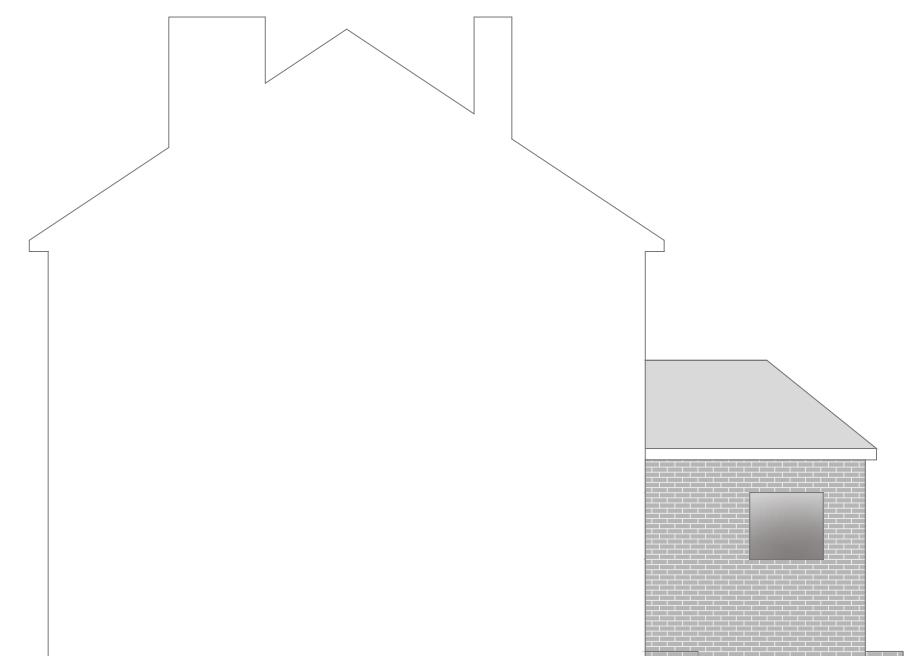

Side Elevation

0 1 2 3 4 5
metres 1:100 scale

Drawn By: VG
Job Ref: 22080
Date: Aug- 2024
Drawing No. LW- 03

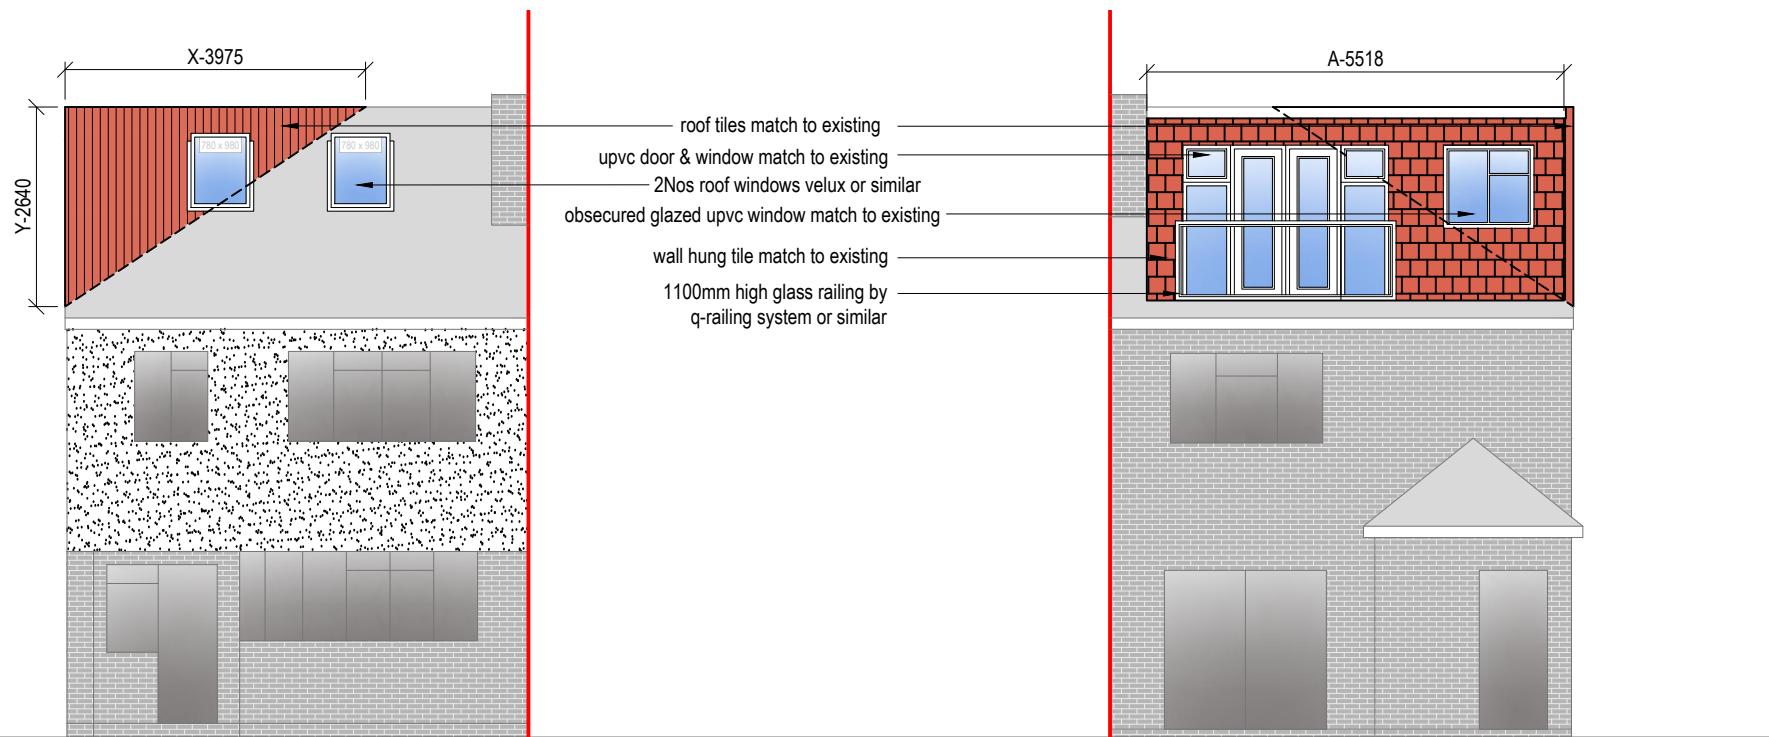

VOLUME CALCULATION :-


1. HIP TO GABLE :-

$$X-3.975 \times Y-2.640 \times Z-7.899 \times \frac{1}{6} = 13.81 \text{ M3}$$

2. DORMER :-

$$A-5.518 \times B-3.852 \times C-2.558 \times \frac{1}{2} = 27.18 \text{ M3}$$

$$\text{TOTAL} : 13.81 + 27.18 = 40.99 \text{ M3}$$

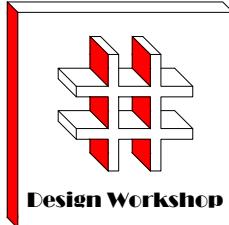

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Site Address:

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UB4 8LD

Title:

Proposed Elevations

Scale: 1:100

Paper Size: A3

Rev Date Comments


Drawn By: VG
Job Ref: 22080
Date: Aug- 2024
Drawing No. LW- 04

Front Elevation

0 1 2 3 4 5
metres 1:100 scale

Rear Elevation

0 1 2 3 4 5
metres 1:100 scale

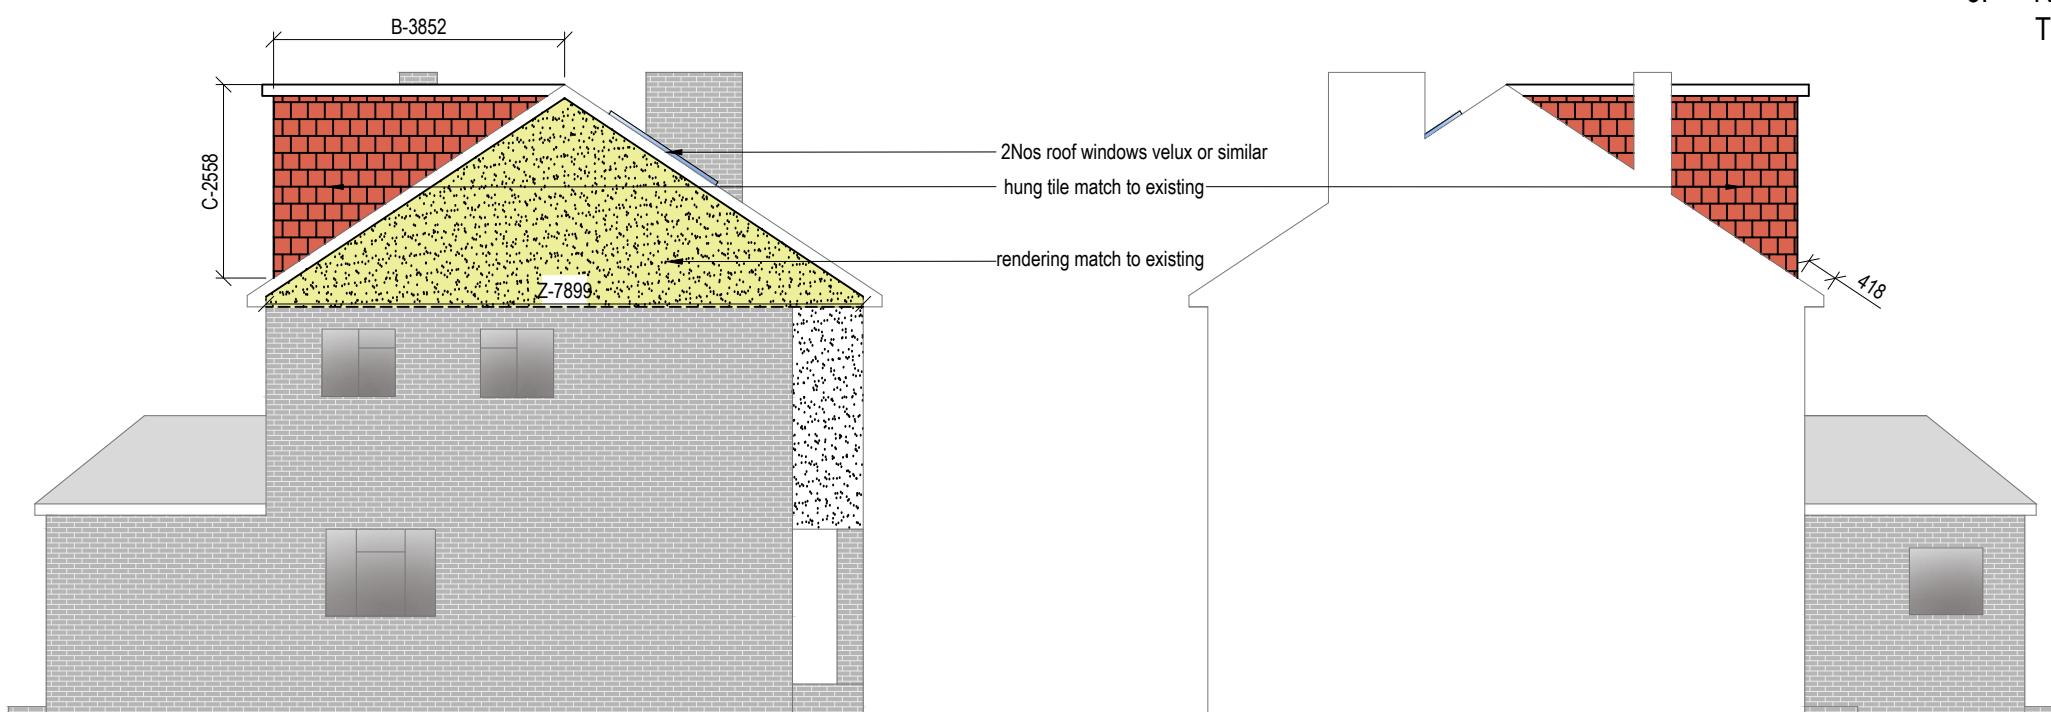

Side Elevation

0 1 2 3 4 5
metres 1:100 scale

Side Elevation

0 1 2 3 4 5
metres 1:100 scale

NOTE:

ANY WINDOW INSERTED ON WALL OR ROOF SLOPE FORMING A SIDE ELEVATION OF THE DWELLING SHALL BE:

1. OBSECURE P GLAZED
2. NON- OPENING UNLESS THE PARTS OF THE WINDOW WHICH CAN BE OPENED ARE MORE THAN 1.7 METERS ABOVE THE FLOOR OF THE ROOM IN WHICH THE WINDOW IS INSTALLED.
3. ROOF WINDOW WILL NOT PROTRUDE MORE THAN 150MM