


EXISTING/ORIGINAL
HARDSTANDING AREA
DEPICTED:




(CURRENTLY USED FOR
OFF-STREET PARKING)

EXISTING PERMEABLE
'CELLWEB TRP' AREA
DEPICTED:

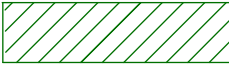

(USED FOR OFF-STREET
PARKING)

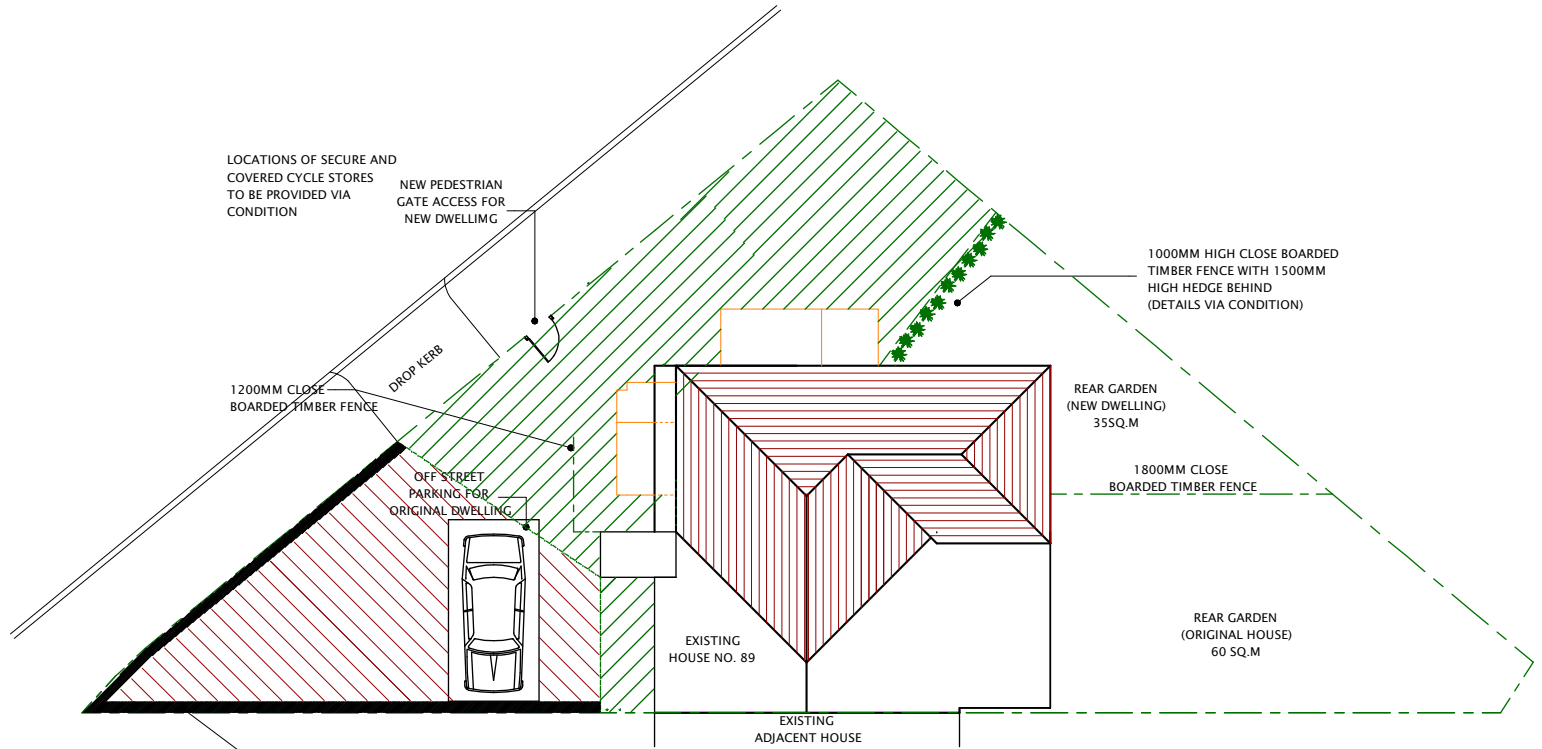


EXISTING LANDSCAPED
STRIP (LAWN)

Difference between internal
ffl and external gl is 100mm.
Therefore, ramp gradient
would be very gentle


PROPOSED BLOCK / ROOF PLAN (SCALE 1:200)

NOTE:
"PRIMARY WHEELCHAIR ACCESSIBLE RAMP
to allow step free access
[in accordance with approved
document M of building regulations
(details via condition)]"


NOTE:
"SECONDARY WHEELCHAIR ACCESSIBLE RAMP
to allow step free access
[in accordance with approved
document M of building regulations
(details via condition)]"

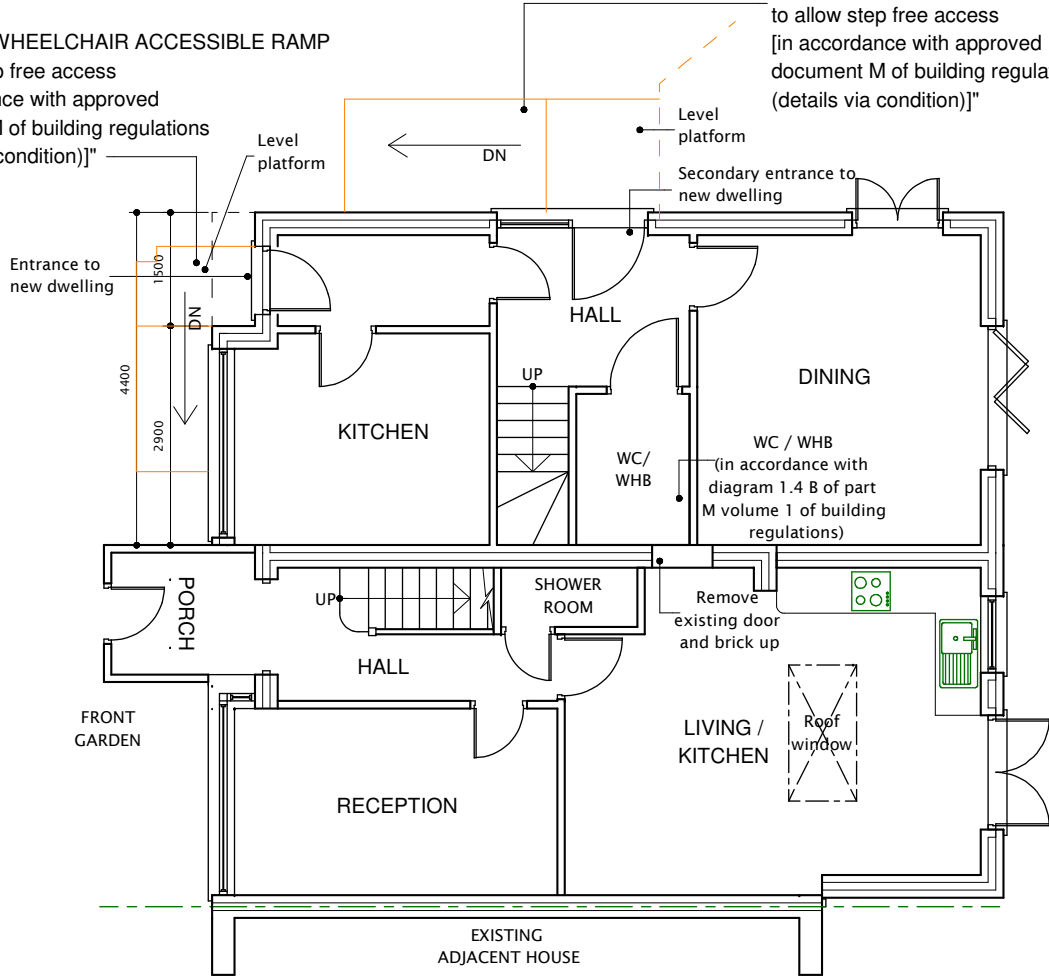

PROPOSED GROUND FLOOR PLAN

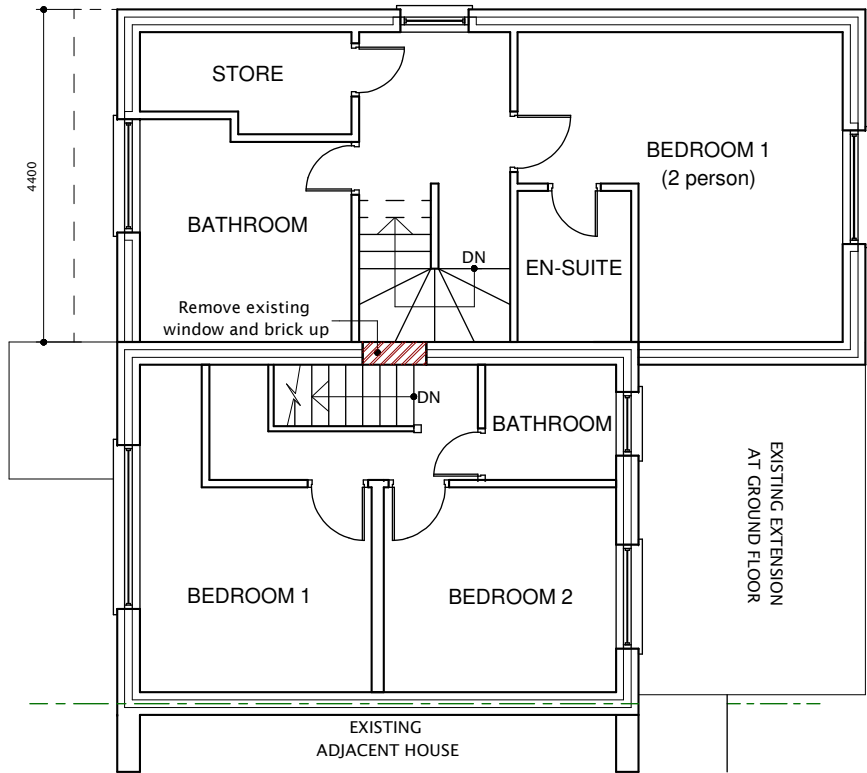

PROPOSED FIRST FLOOR PLAN

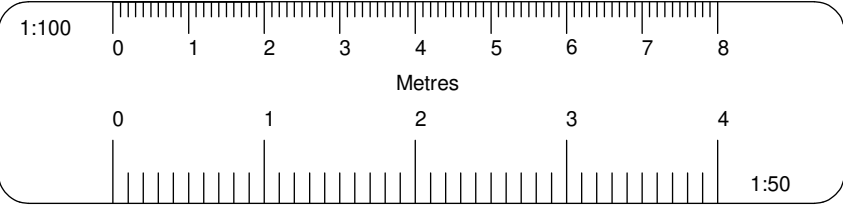

All dimensions verified on site.
All work to comply with British Standards, Code of practice.
All internal works to be in accordance with client instructions.
All external surfaces to match existing.
All work to be to the satisfaction of the local authority-building surveyor.
Builder to serve building notice and comply fully in all respects.
Owner responsible for compliance with 1.Party Wall etc Act 1996. 2. Thames water Build Over Agreement.
Builder to ensure all work in compliance with Build Over agreement as approved by Thames Water
All proprietary materials to manufacturers recommendations
Works to boiler/Gas to be carried out by Gas Safe registered installer and to Gas Safe recommendations

All wiring and electrical work will be designed, installed, inspected and tested in accordance with the requirements of BS 7671:2001 (2004), the 17th edition Wiring Guidance and Building Regulation Part P (Electrical Safety) by a competent person registered with an electrical self-certification scheme, (BRE, BSI, ELECSA, NAPIT, or NICEIC), authorised by the Secretary of State
The competent person is to send a self-certification certificate to the Local Authority Building Control Department within 30 days of completion of the electrical works. The client must receive both a copy of the self-certification certificate and a BS 7671:2001 (2004) Electrical Installation Test Certificate and forward copies to the Local Authority Building Control Dept.

DATE	REVISION

COPYRIGHT:

JOB TITLE:
89 WARWICK CRESCENT HAYES

DRAWING TITLE:
PROPOSED GROUND FLOOR PLAN,
FIRST FLOOR PLAN AND BLOCK PLAN

SCALE : 1:100

DATE: 21062024

DRAWN BY:

DRG. NO.	REV.
2021/89/WCH/4003/A	