

EXISTING/ORIGINAL  
HARDSTANDING AREA  
DEPICTED:





(CURRENTLY USED FOR  
OFF-STREET PARKING)

EXISTING PERMEABLE  
'CELLWEB TRP' AREA  
DEPICTED:



(USED FOR OFF-STREET  
PARKING)

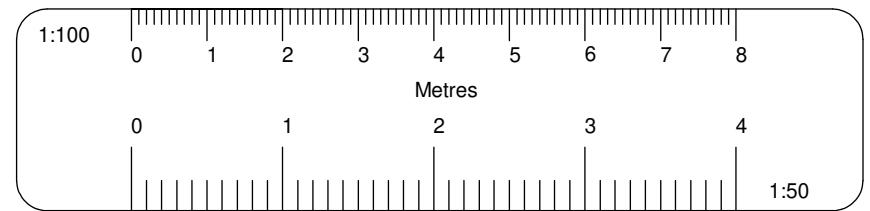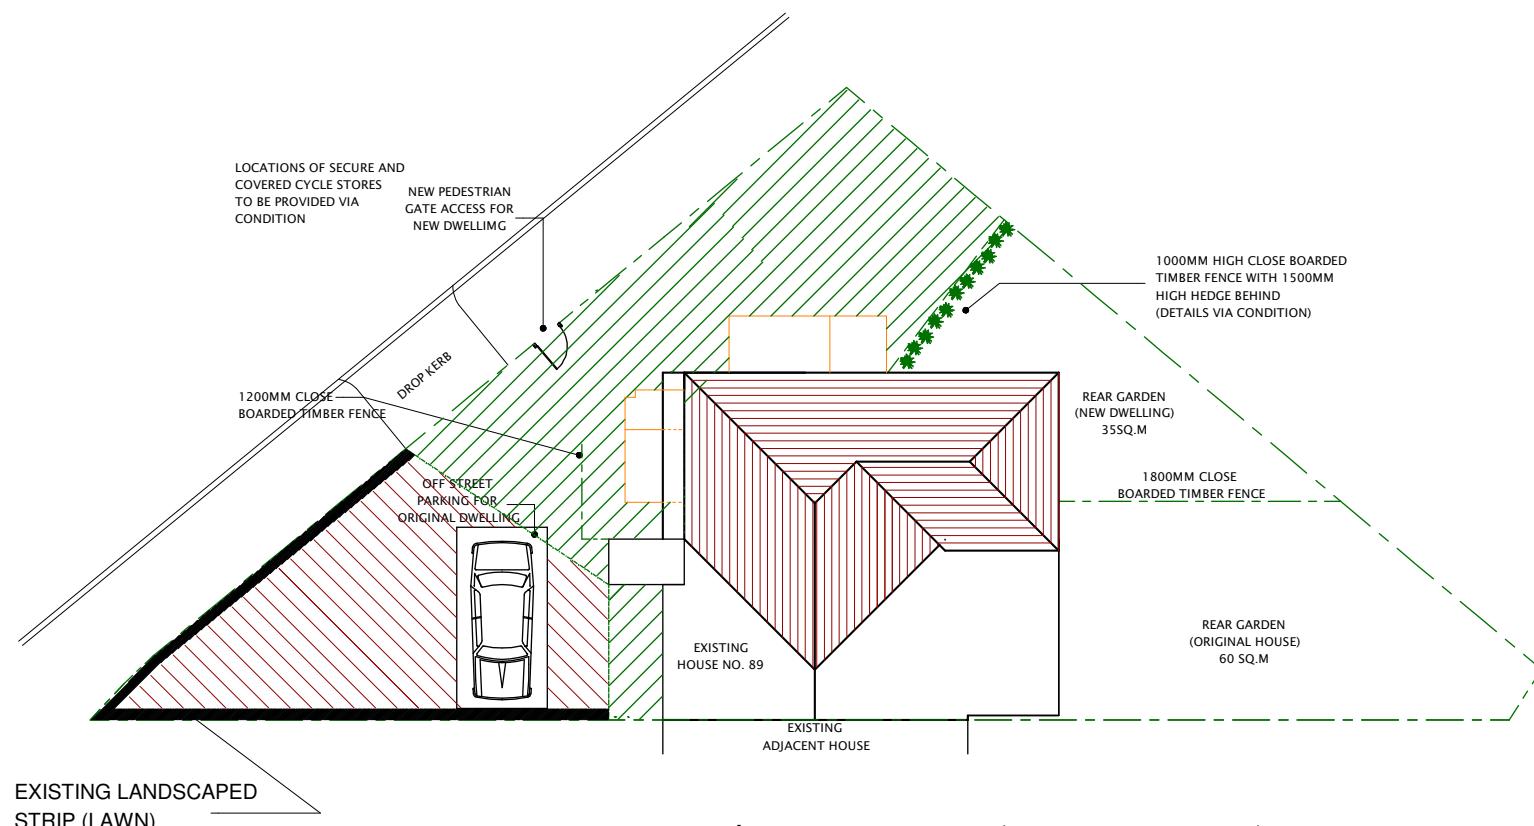

All dimensions verified on site.  
All work to comply with British Standards, Code of practice.  
All internal works to be in accordance with client instructions.  
All external surfaces to match existing.  
All work to be to the satisfaction of the local authority-building surveyor.  
Builder to serve building notice and comply fully in all respects.  
Owner responsible for compliance with 1. Party Wall etc Act 1996. 2. Thames water Build Over Agreement.  
Builder to ensure all work in compliance with Build Over Agreement as approved by Thames Water.  
All proprietary materials to manufacturers recommendations  
Works to boiler/Gas to be carried out by Gas Safe registered installer and to Gas Safe recommendations


All wiring and electrical work will be designed, installed, inspected and tested in accordance with the requirements of BS 7671:2001 (2004), the 17th edition Wiring Guidance and Building Regulation Part P (Electrical Safety) by a competent person registered with an electrical self-certification scheme, (BRE, BSI, ELECSA, NAPIT, or NICEIC), authorised by the Secretary of State

The competent person is to send a self-certification certificate to the Local Authority Building Control Department within 30 days of completion of the electrical works. The client must receive both a copy of the self-certification certificate and a BS 7671:2001 (2004) Electrical Installation Test Certificate and forward copies to the Local Authority Building Control Dept.


## PROPOSED BLOCK / ROOF PLAN (SCALE 1:200)

Difference between internal ffl and external gl is 100mm.  
Therefore, ramp gradient would be very gentle

NOTE:  
"SECONDARY WHEELCHAIR ACCESSIBLE RAMP  
to allow step free access  
[in accordance with approved  
document M of building regulations  
(details via condition)]"

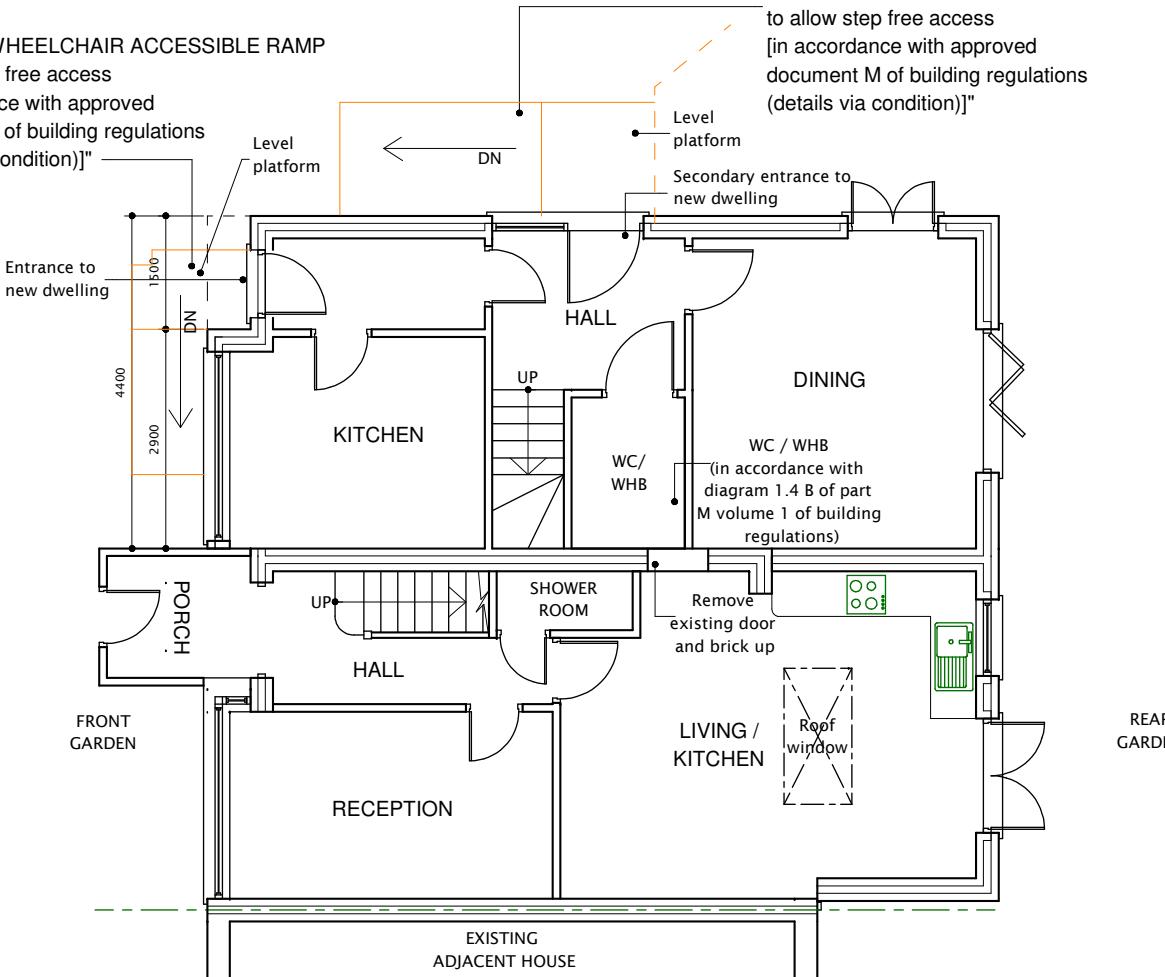

PROPOSED GROUND FLOOR PLAN

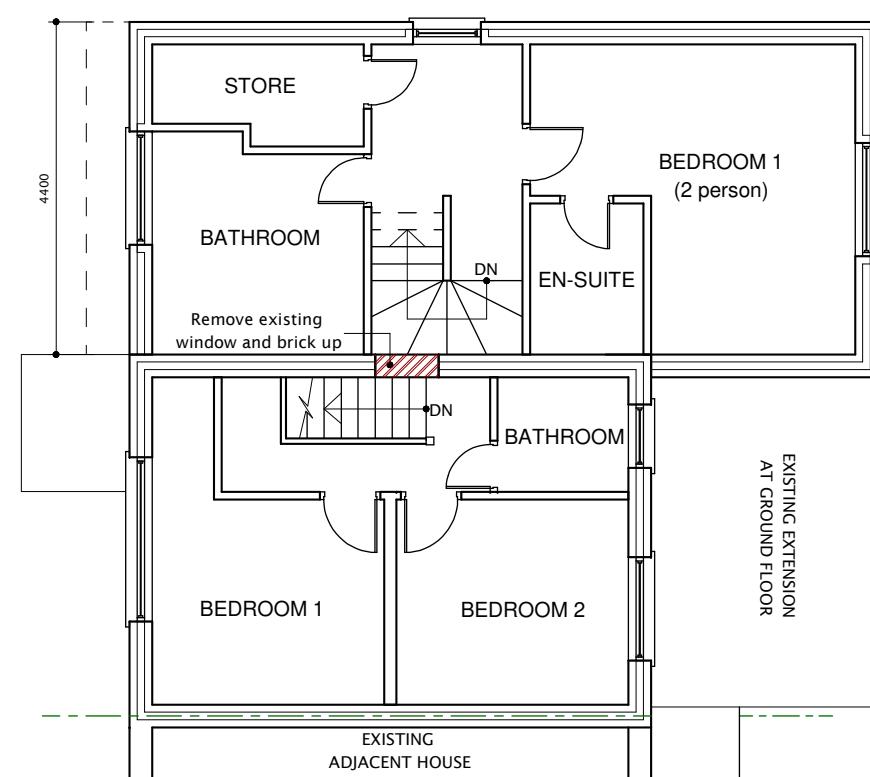

PROPOSED FIRST FLOOR PLAN

DATE	REVISION
COPYRIGHT:	
JOB TITLE: 89 WARWICK CRESCENT HAYES	
DRAWING TITLE: PROPOSED GROUND FLOOR PLAN, FIRST FLOOR PLAN AND BLOCK PLAN	
SCALE : 1:100	
DATE: 21062024 DRAWN BY:	
DRG. NO.	REV.
2021/89/WCH/4003/A	