



Existing Ground Floor Plan
Scale 1:100



Existing First Floor Plan
Scale 1:100

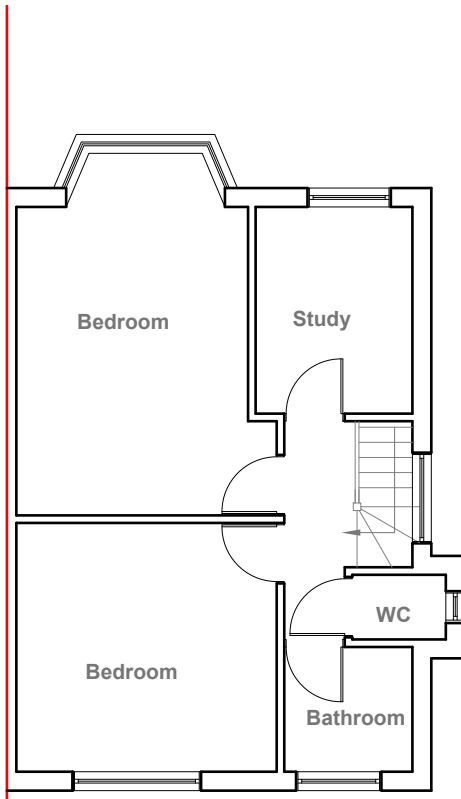

Existing Front Elevation
Scale 1:100

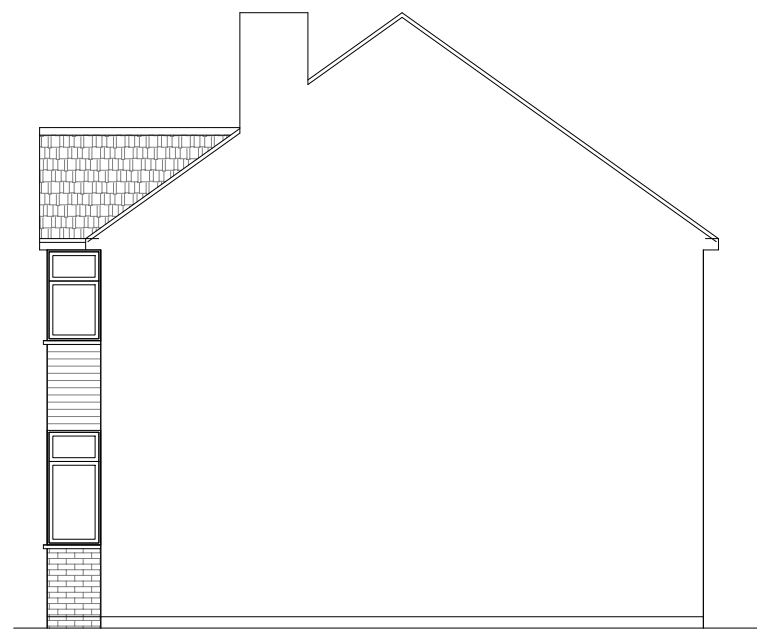

Existing Side Elevation
Scale 1:100



Existing Rear Elevation
Scale 1:100



Existing Side Elevation
Scale 1:100



GENERAL NOTES:
1. ALL DIMENSIONS ARE IN MILLIMETER.
2. VERIFY ALL DIMENSIONS AND CONDITIONS BEFORE BUILDING OR STARTING CONSTRUCTION. NOTIFY THE DESIGNER IMMEDIATELY OF ANY DISCREPANCY OR VARIATION.
3. ALL WORK TO COMPLY WITH CURRENT BUILDING REGULATIONS AND CODES OF PRACTICE

Title:

Existing Floor Plans & Elevations


Site Address
216 West End Road
Ruislip
Middlesex
HA4 6DU

Scale: 1:100 @A3
Date: 22/03/2021
Drawing No.: 2021/43 -01
Drawn By: FP


Revision Date:

e.mail -
faluckpatel@yahoo.com
(M) +44 (0) 7871 466 254



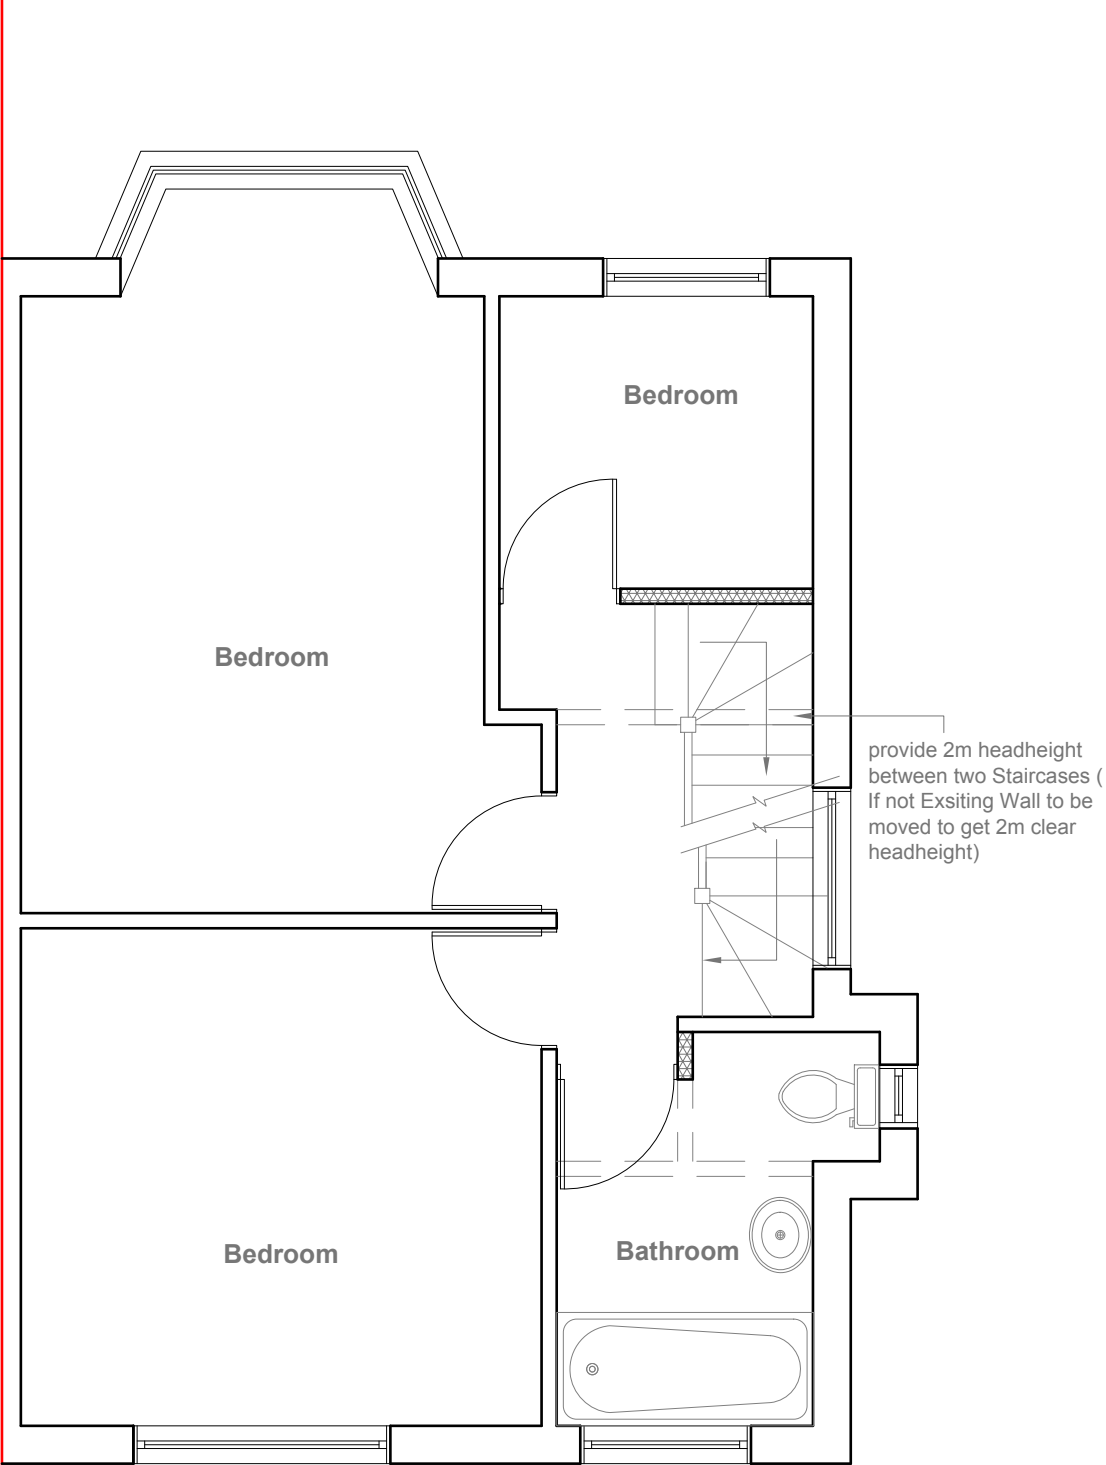

Proposed First Floor Plan
Scale 1:50

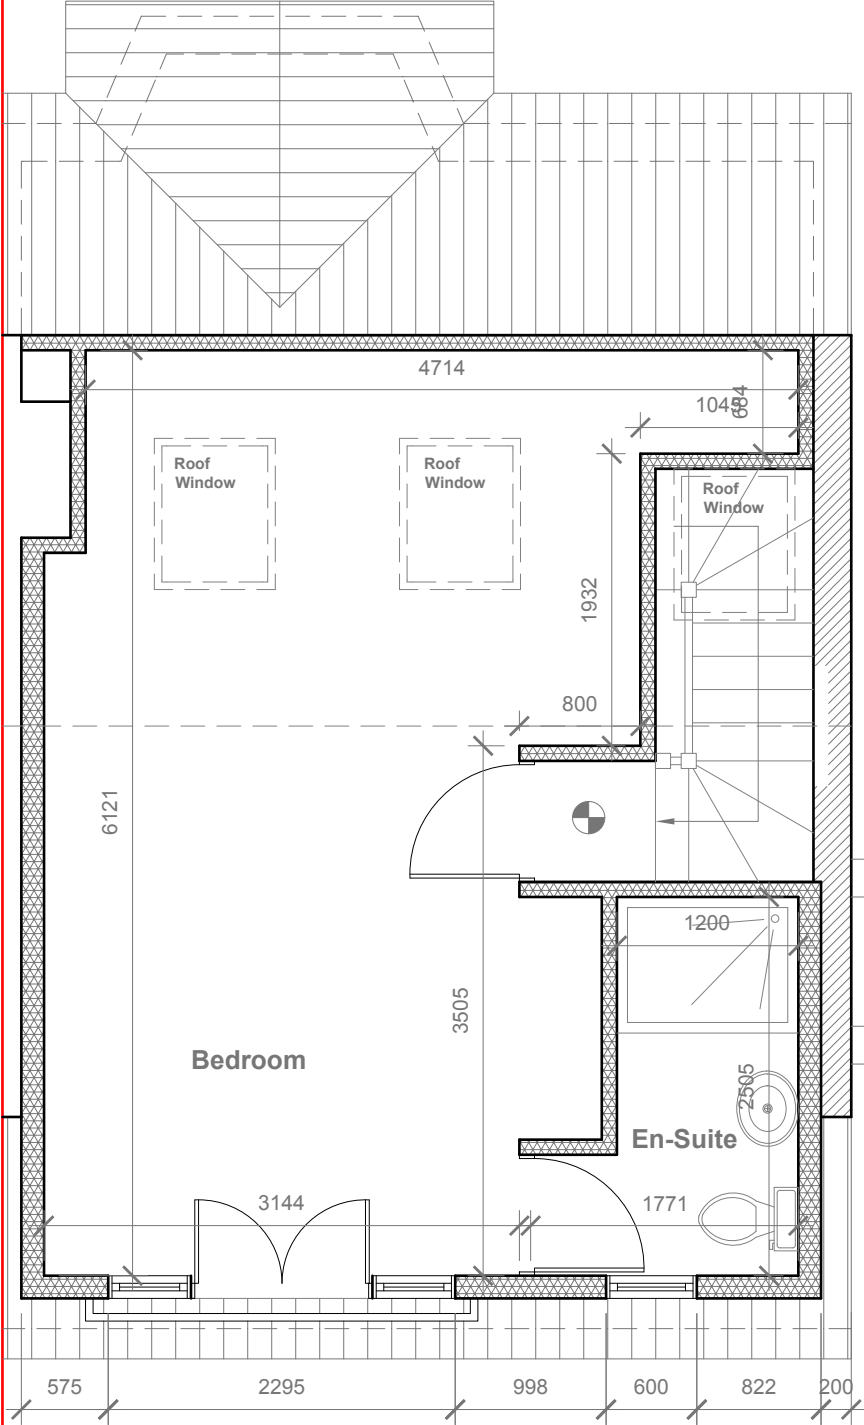

Velux Window to be installed as per manufacturer specification, not projected more than 150mm from the plane of roof slop

Proposed Loft Floor Plan
Scale 1:50



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Title:

Proposed First Floor & Loft Plans

Site Address
216 West End Road
Ruislip
Middlesex
HA4 6DU

Scale: 1:50 @A3
Date: 22/03/2021
Drawing No.: 2021/43 -02
Drawn By: FP

Revision Date:
e:mail - faluckpatel@yahoo.com
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Proposed External Finish
Materials to Match Existing
External Finish Materials

REAR DORMER VOLUME = $W \times H \times L / 2$
 $5.289 \times 2.700 \times 3.786 / 2$
 $54.06 / 2$
V1 = 27.03 CU.MT.

HIP TO GABLE ROOF VOLUME = $W1 \times H1 \times L1 / 6$
 $8.371 \times 3.138 \times 3.985 / 6$
 $104.67 / 6$
V2 = 17.44 CU.MT.

TOTAL ROOF VOLUME = $V1 + V2$
 $27.03 + 17.44$
44.47 CU.MT.< 50.00 CU.MT



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3. ALL WORK TO COMPLY WITH CURRENT BUILDING REGULATIONS AND CODES OF PRACTICE

Title:

Proposed Elevations & Ground Floor Plan

Site Address
216 West End Road
Ruislip
Middlesex
HA4 6DU

Scale: 1:100 @A3
Date: 22/03/2021
Drawing No.:
2021/43 -03
Drawn By:
FP

Revision Date:

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**Faluck
Patel**