

ons to be verified on site
SCALE FROM THIS DRAWING.
as indicated on this drawing are for guidance
responsibility is taken for their accuracy.

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Site Address:

9 St Anselms Road,
Hayes,
UB3 1SB


Title:

Block and Location Plans

Scale: 1:500, 1:1250

Planer Size

Rev	Date	Comments
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Block Plan

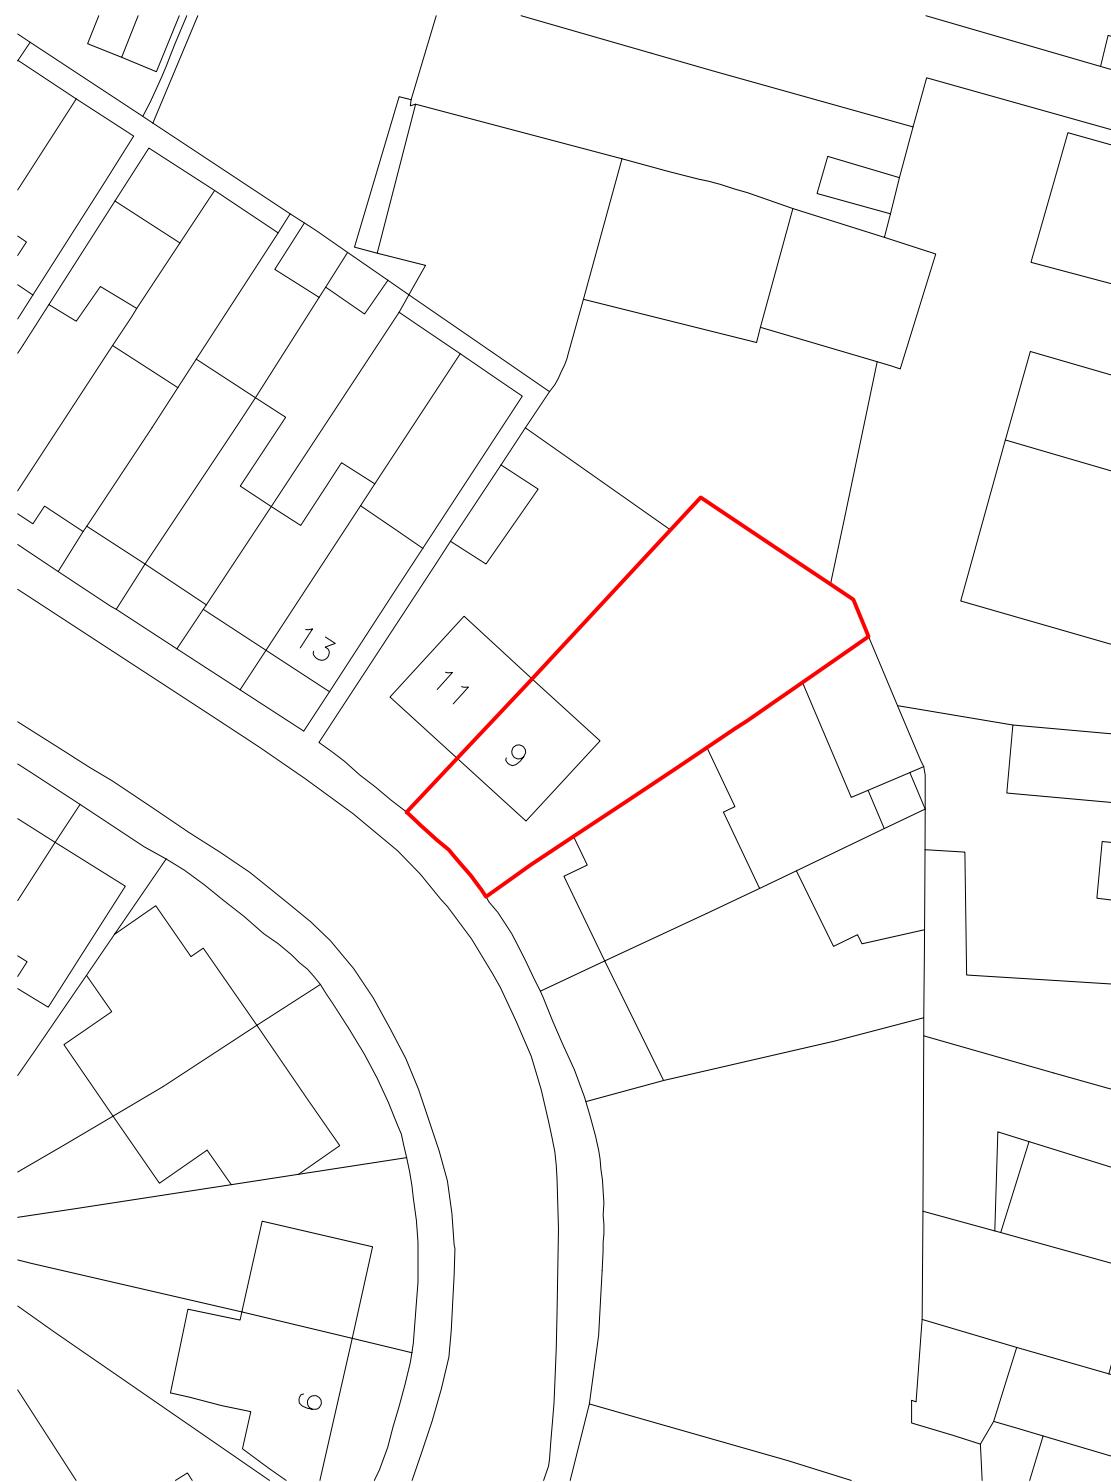A scale bar marked from 0 to 20 in increments of 5. Below the scale bar is the text "metres 1:500 scale".



Site Location


A scale bar for 1:1250 scale, showing distances from 0 to 50 metres. The bar is marked with major tick marks at 0, 10, 20, 30, 40, and 50. The first 10 units are further divided into 10 smaller segments, with the first segment being shaded dark grey and the second being light grey, representing a 1:1250 scale ratio.

Drawn By: VG

Job Ref: 24037

Date: May 2024

Drawing No. LW- 01

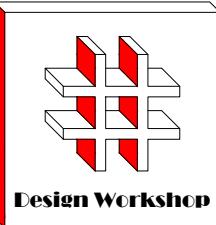

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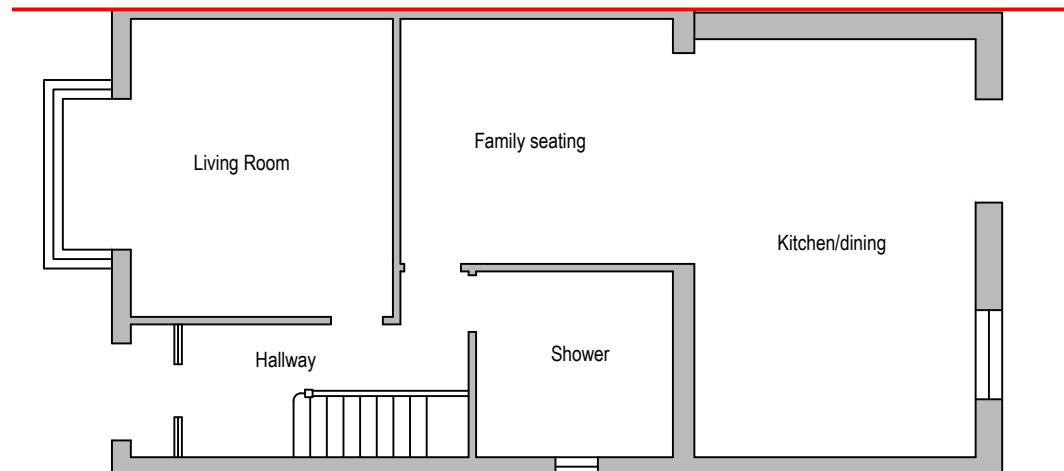
Title:

Existing & Proposed Ground Floor
Plans

Scale: 1:50, 1:100


Paper Size: A3

Rev Date Comments




Existing Ground Floor Plan

0 1 2 3 4 5
metres 1:100 scale

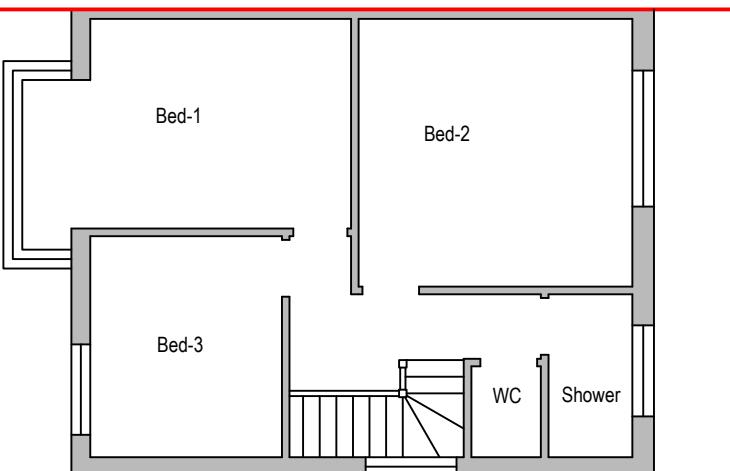


Existing First Floor Plan

0 1 2 3 4 5
metres 1:100 scale

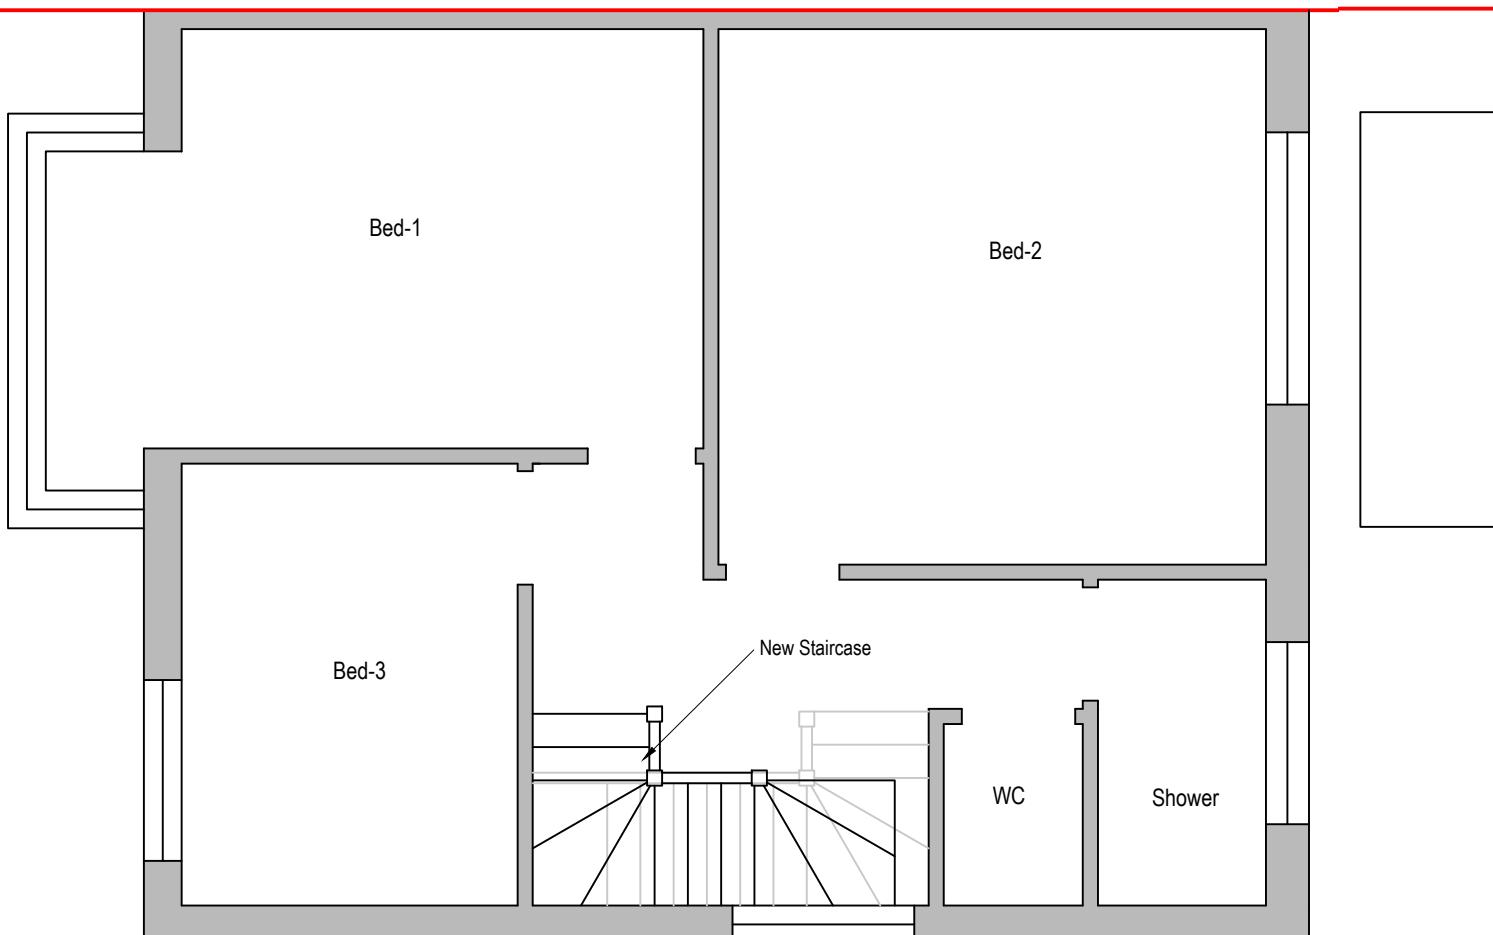

Proposed First Floor Plan

0 0.5 1.0 1.5 2.0 2.5
metres 1:50 scale

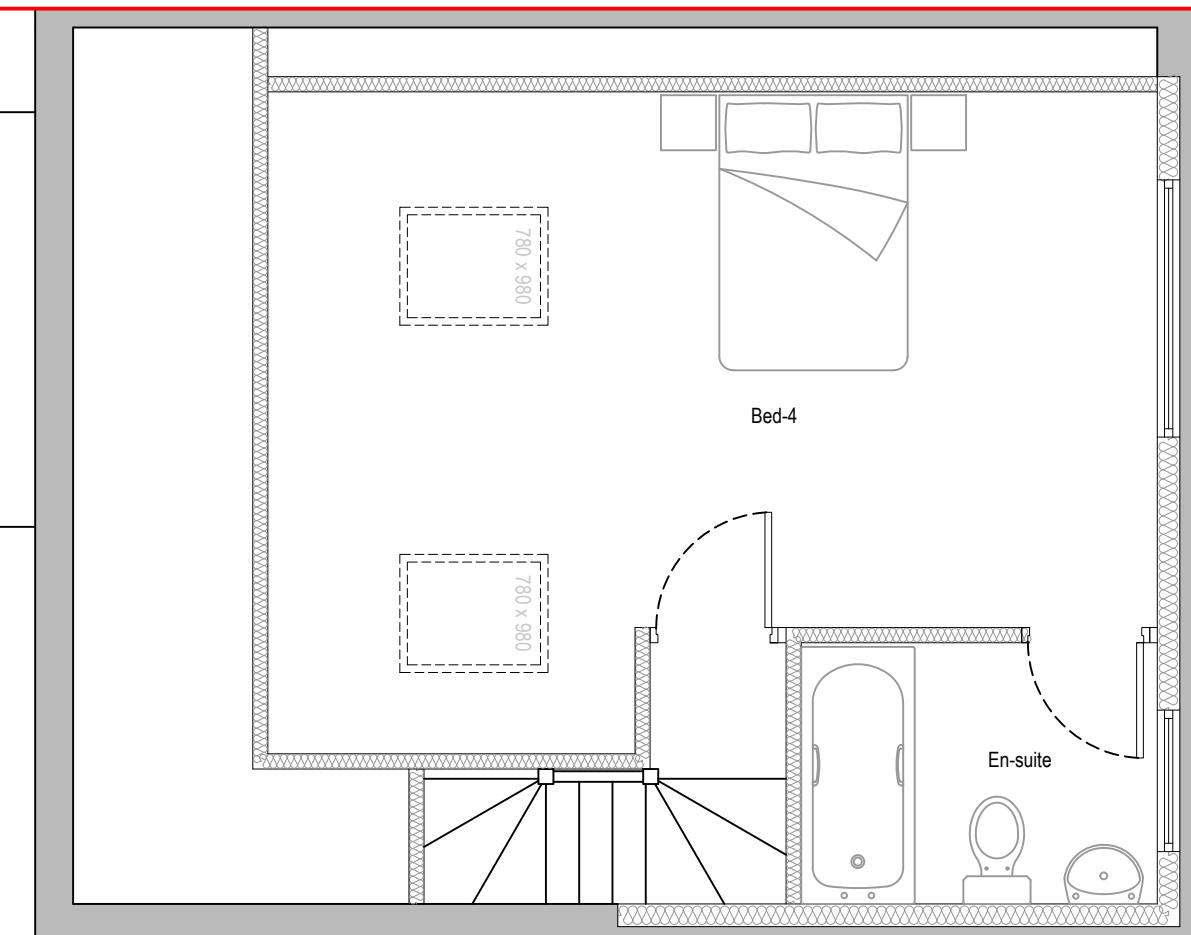

Proposed Loft Floor Plan


0 0.5 1.0 1.5 2.0 2.5
metres 1:50 scale

Drawn By: VG

Job Ref: 24037

Date: May 2024

Drawing No. LW-02

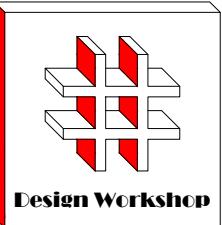

Design Workshop

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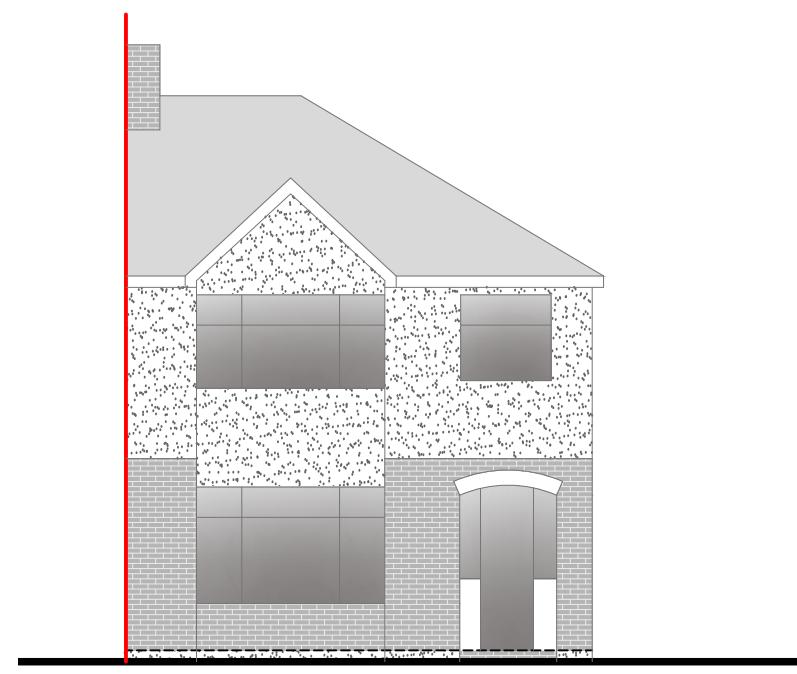
Title:

Existing Elevations


Scale: 1:100

Paper Size: A3


Rev	Date	Comments




Front Elevation

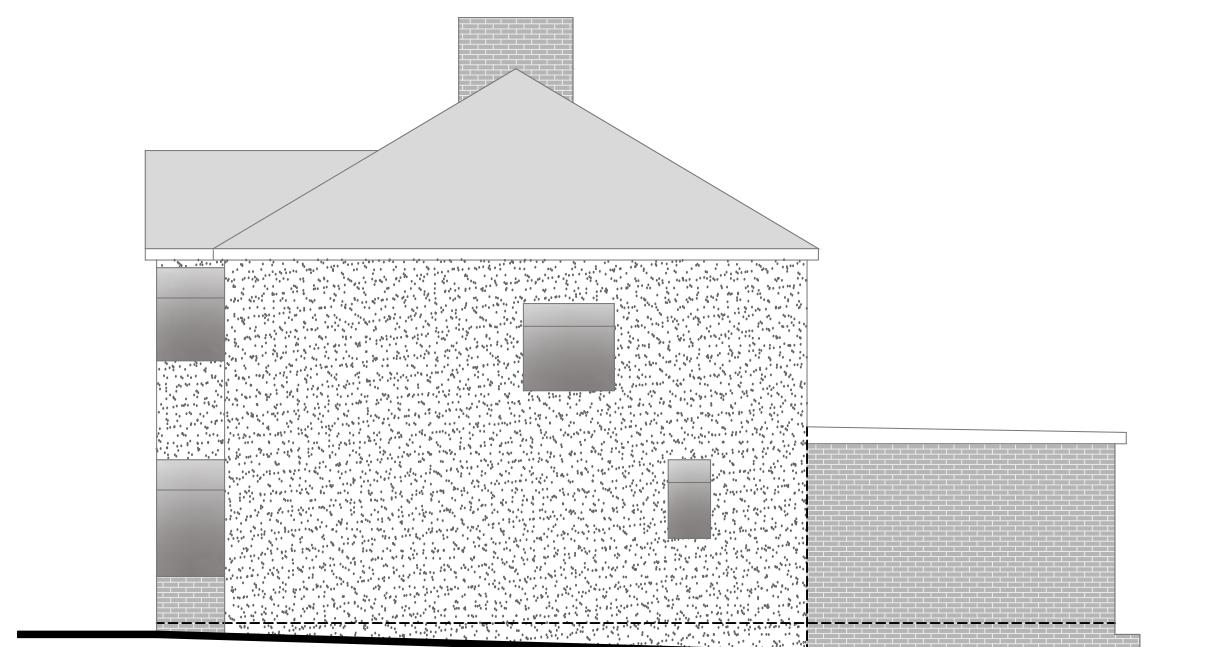

Side Elevation

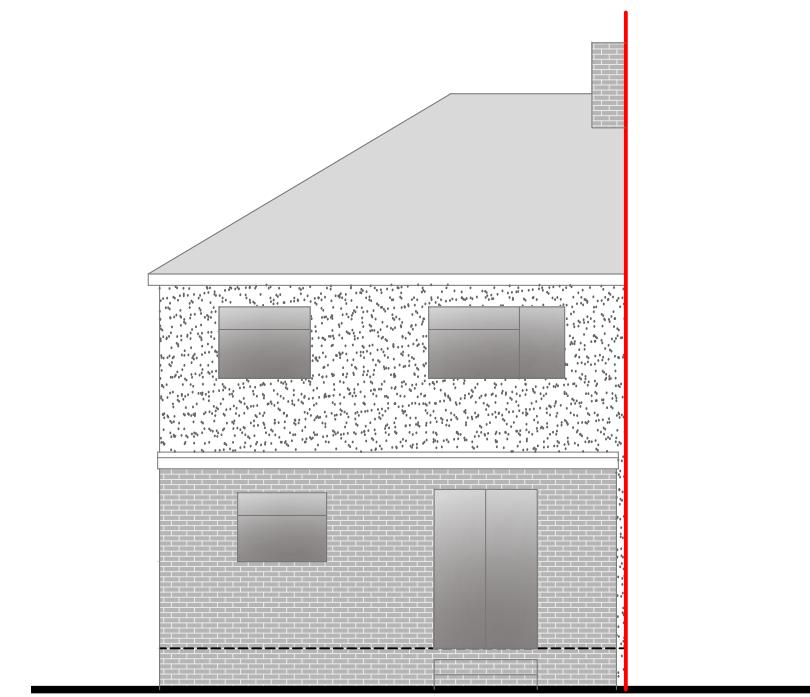


Rear Elevation

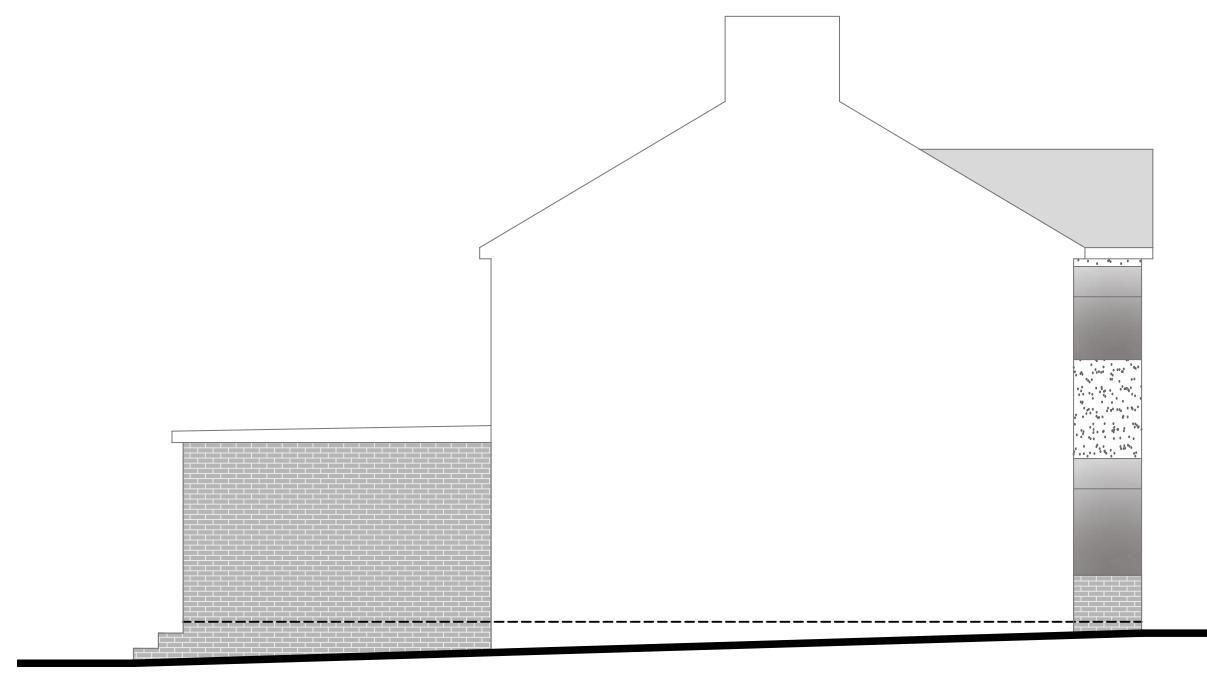

Side Elevation

Drawn By: VG
Job Ref: 24037
Date: May 2024
Drawing No. LW-03

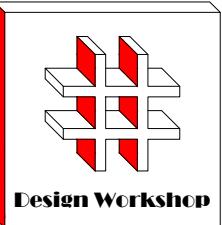

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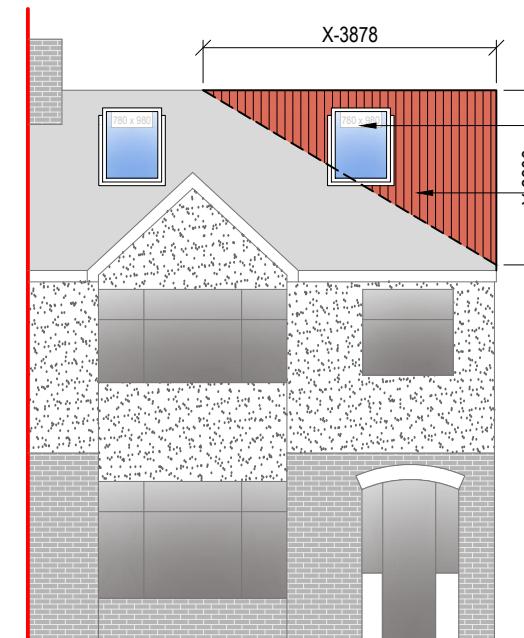
Title:

Proposed Elevations

Scale: 1:100


Paper Size: A3

Rev Date Comments




Front Elevation

0 1 2 3 4 5
metres 1:100 scale

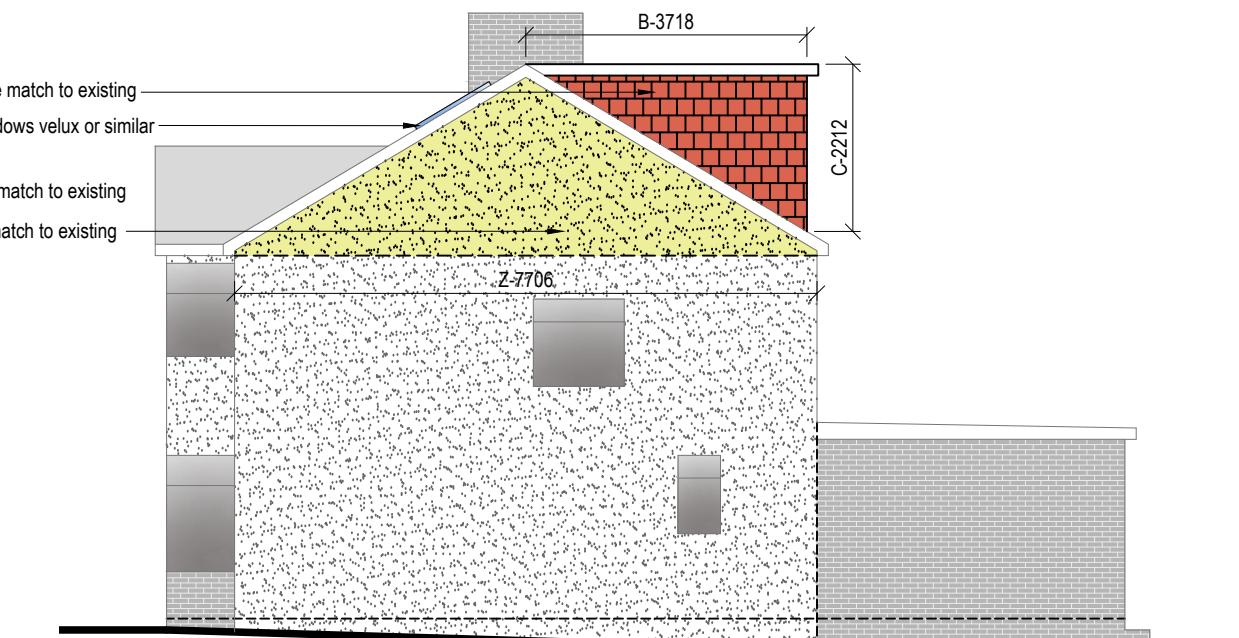


Side Elevation

0 1 2 3 4 5
metres 1:100 scale

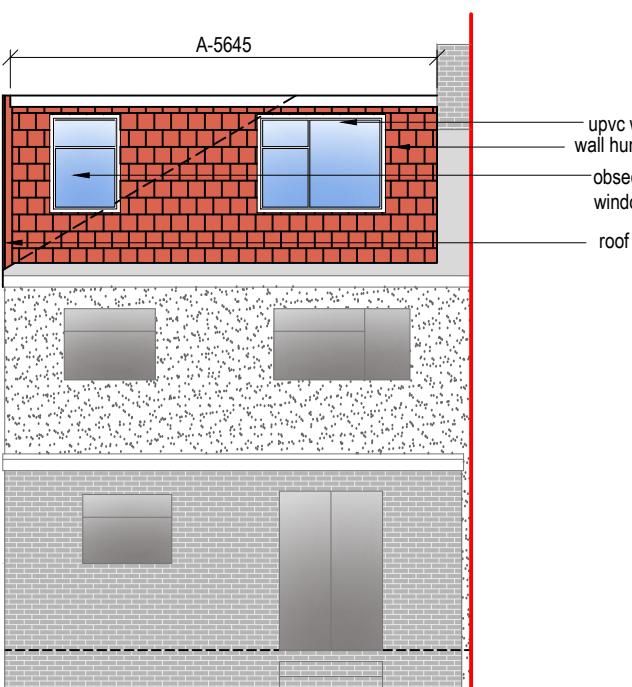

Rear Elevation

0 1 2 3 4 5
metres 1:100 scale

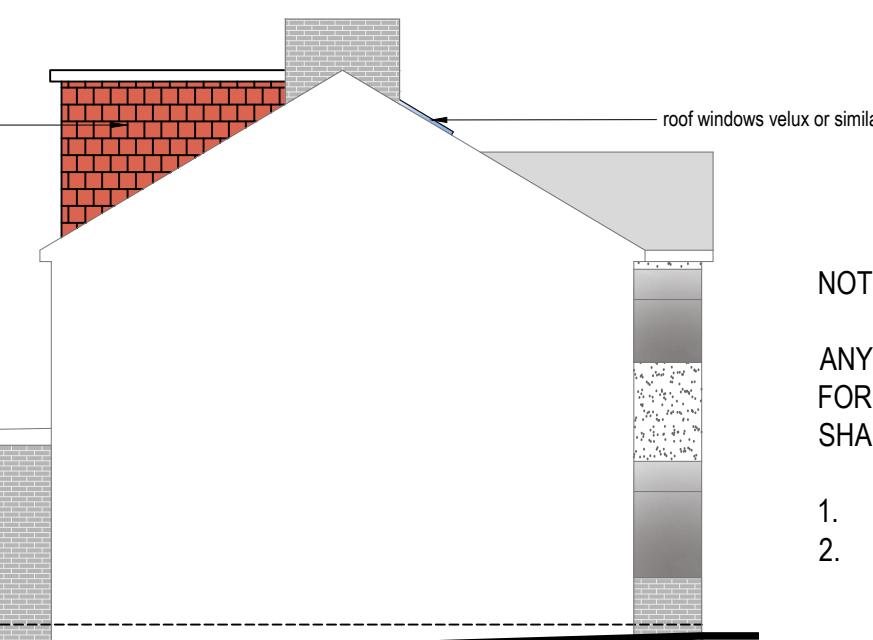

NOTE:

ANY WINDOW INSERTED ON WALL OR ROOF SLOPE FORMING A SIDE ELEVATION OF THE DWELLING SHALL BE:

1. OBSECURE P GLAZED
2. NON- OPENING UNLESS THE PARTS OF THE WINDOW WHICH CAN BE OPENED ARE MORE THAN 1.7 METERS ABOVE THE FLOOR OF THE ROOM IN WHICH THE WINDOW IS INSTALLED.
3. ROOF WINDOW WILL NOT PROTRUDE MORE THAN 150MM

Drawn By: VG

Job Ref: 24037

Date: May 2024

Drawing No. LW- 04