

VOLUME CALCULATION :-

1. HIP TO GABLE :-

$$X-4.17 \times Y-3.33 \times Z-8.32 \times \frac{1}{6} = 19.25 \text{ m}^3$$

2. DORMER :-

$$A-5.42 \times B-2.91 \times C-3.65 \times \frac{1}{2} = 28.78 \text{ m}^3$$

$$\text{TOTAL :- } 19.25 + 28.78 = 48.03 \text{ m}^3$$

Dimensions to be verified on site
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Site Address:

247 Station Road
Hayes
UB3 4JD

Title:


Proposed Elevations

Scale: 1:100

Paper Size: A3

Rev Date Comments

Drawn By: VP
Job Ref: 23034
Date: Apr 2023
Drawing No. PL - 05

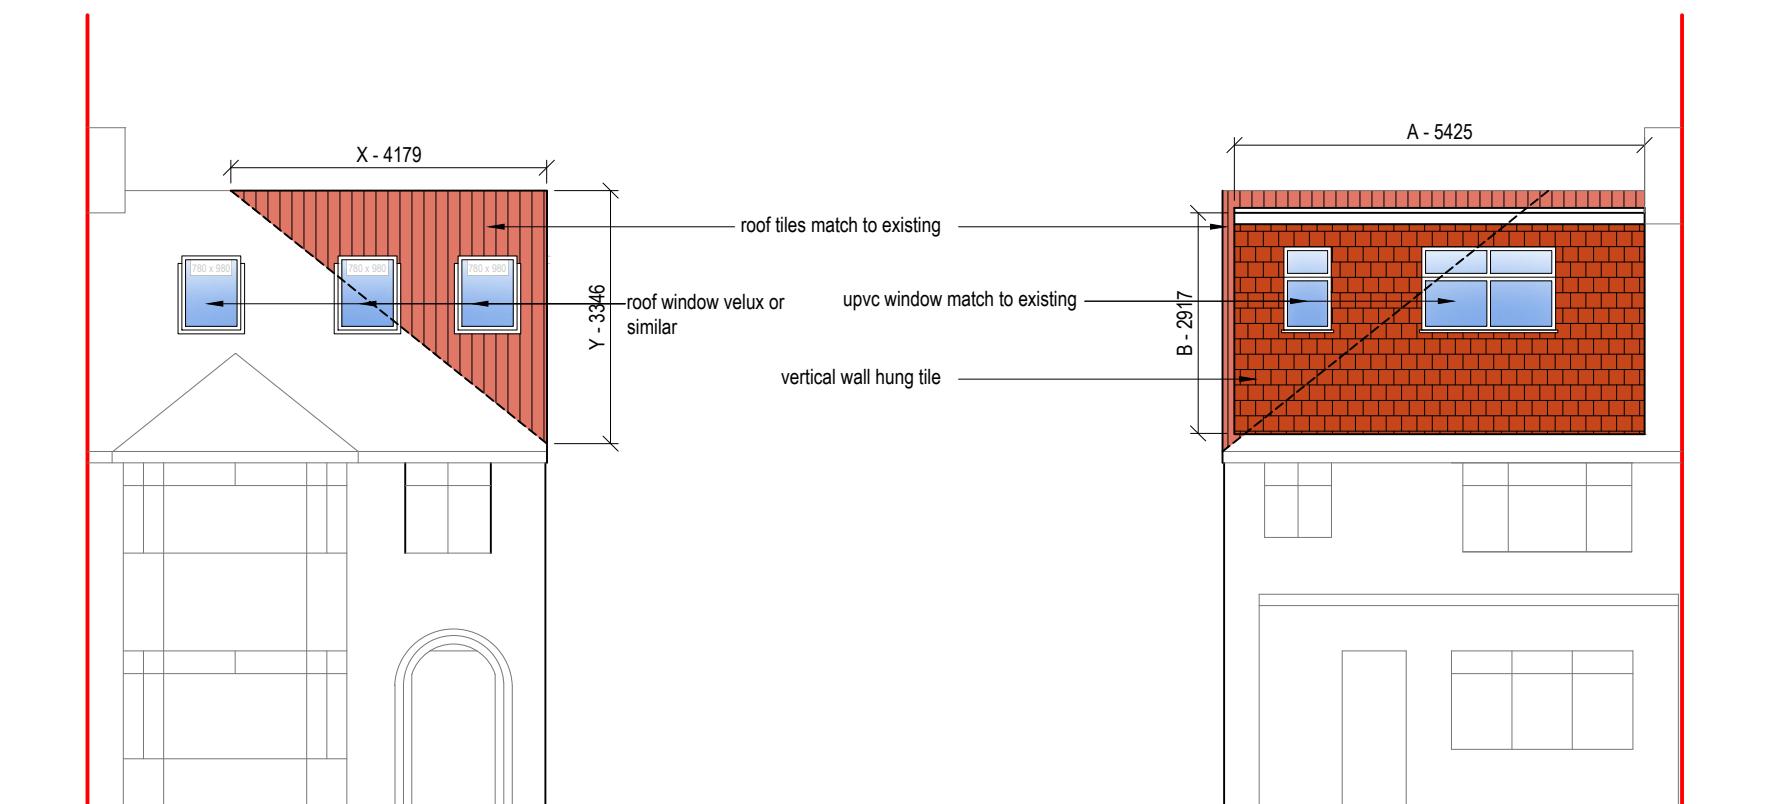

Front Elevation

0 1 2 3 4 5
metres 1:100 scale


Rear Elevation

0 1 2 3 4 5
metres 1:100 scale

NOTE:

ANY WINDOW INSERTED ON WALL OR ROOF SLOPE
FORMING A SIDE ELEVATION OF THE DWELLING SHALL BE:

1. OBSECURE P GLAZED
2. NON- OPENING UNLESS THE PARTS OF THE WINDOW
WHICH CAN BE OPENED ARE MORE THAN 1.7 METERS
ABOVE THE FLOOR OF THE ROOM IN WHICH THE
WINDOW IS INSTALLED.
3. ROOF WINDOW WILL NOT PROTRUDE MORE THAN
150MM

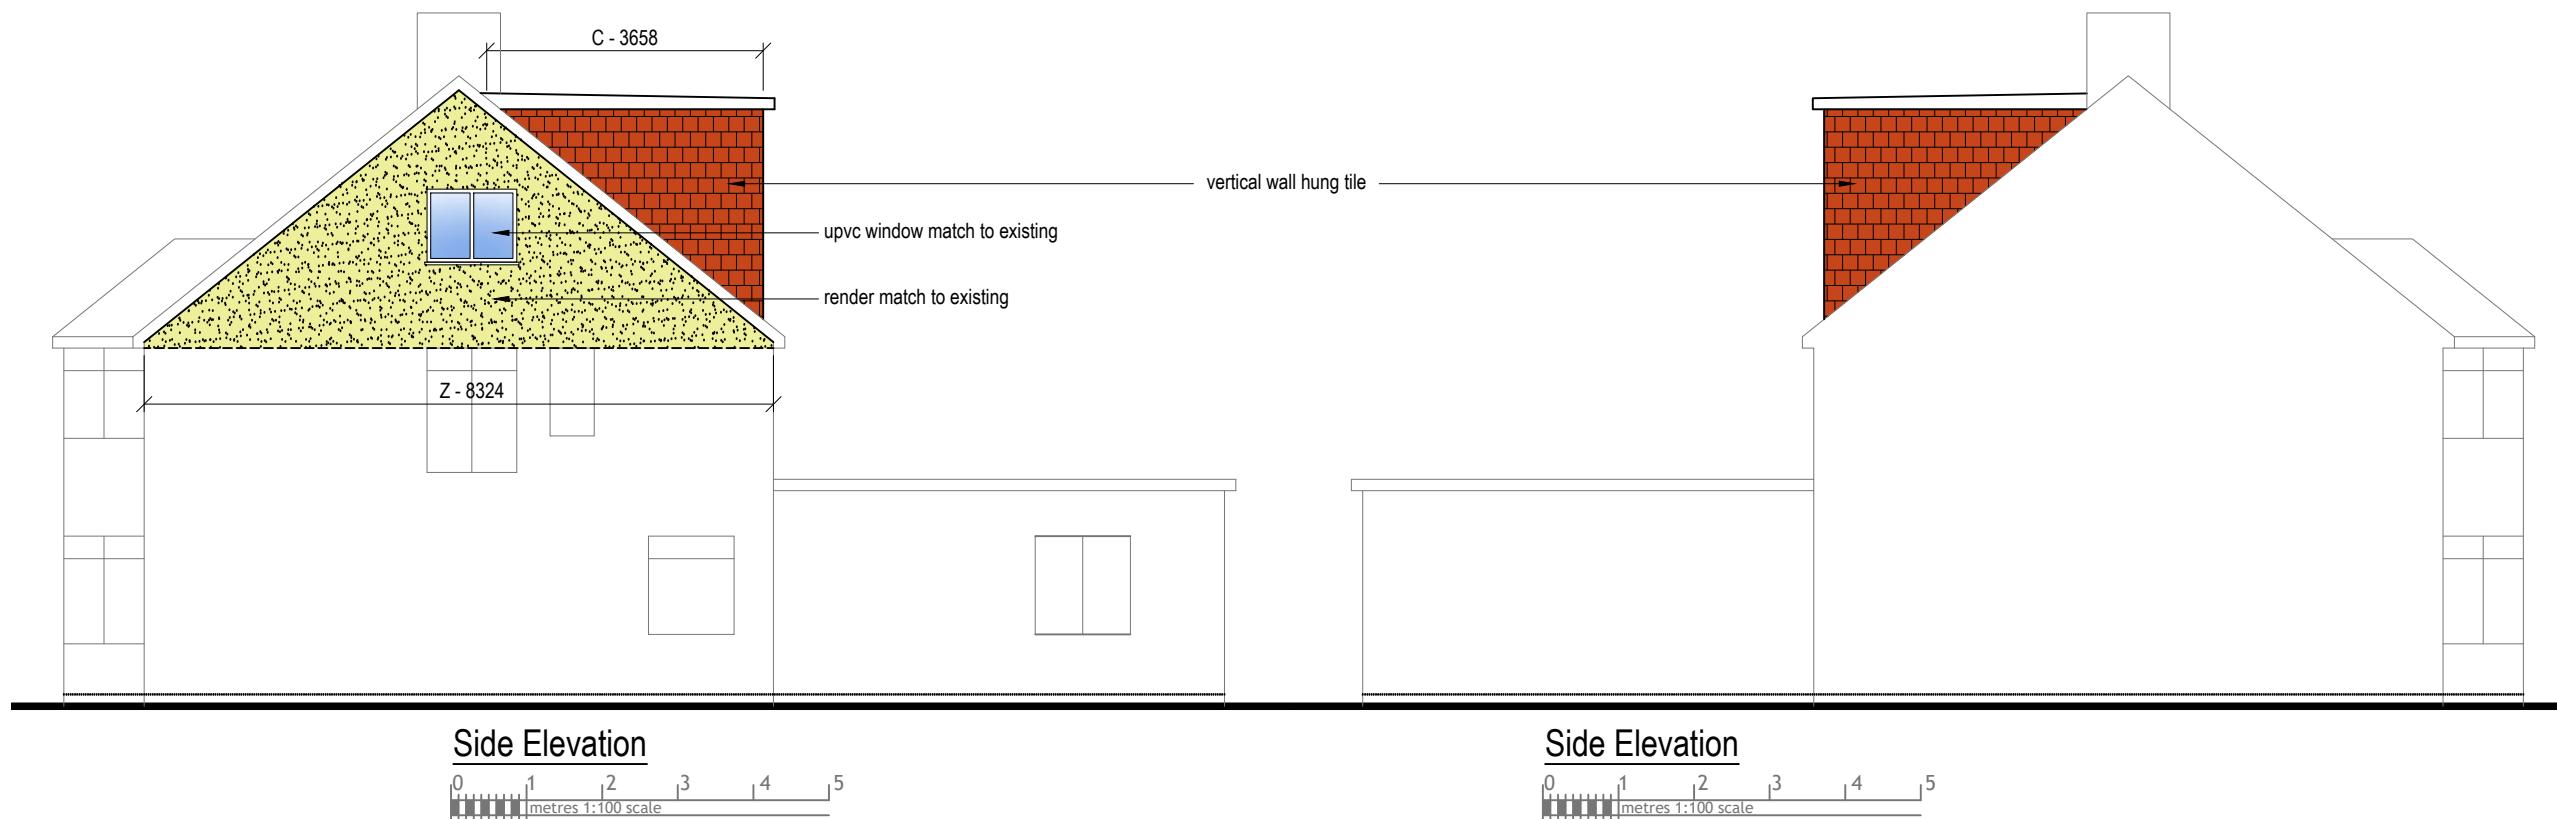

Side Elevation

0 1 2 3 4 5
metres 1:100 scale

Side Elevation

0 1 2 3 4 5
metres 1:100 scale



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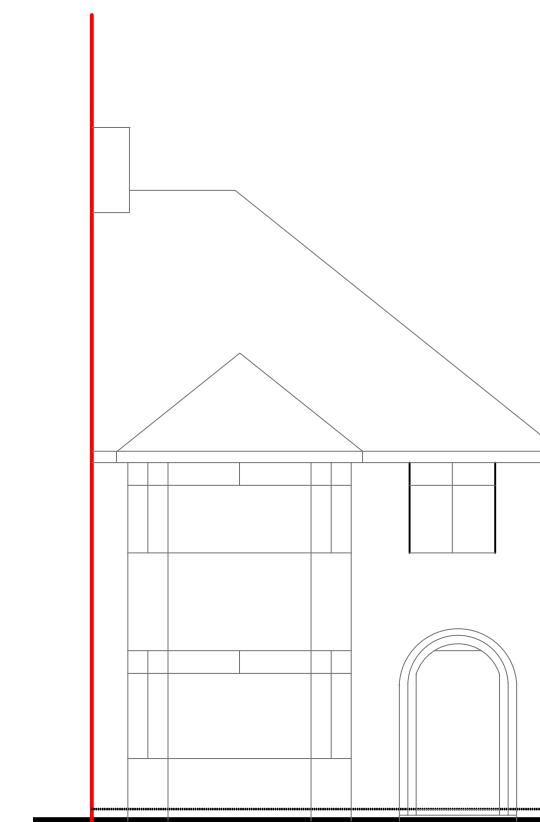
Title:

Existing Elevations


Scale: 1:100

Paper Size: A3


Rev	Date	Comments




Front Elevation

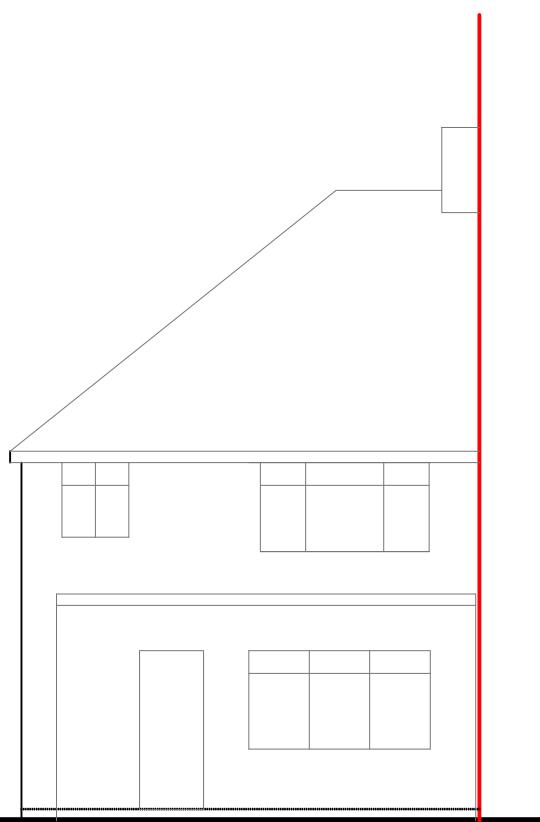

Rear Elevation

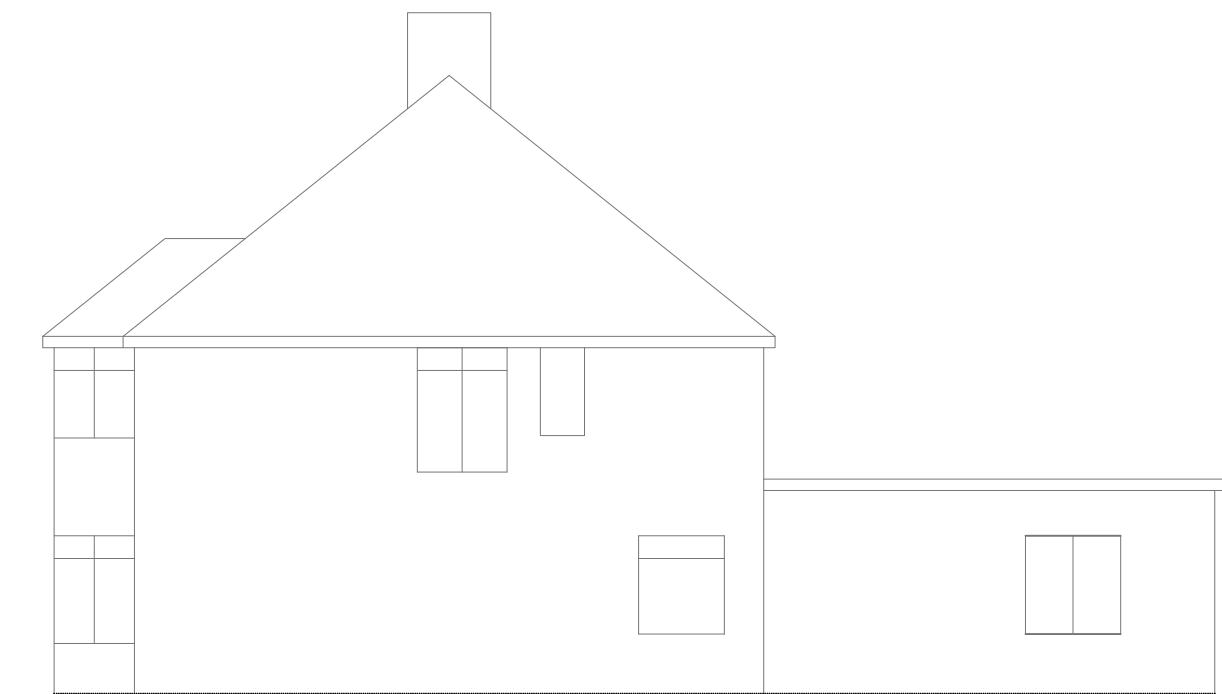


Side Elevation

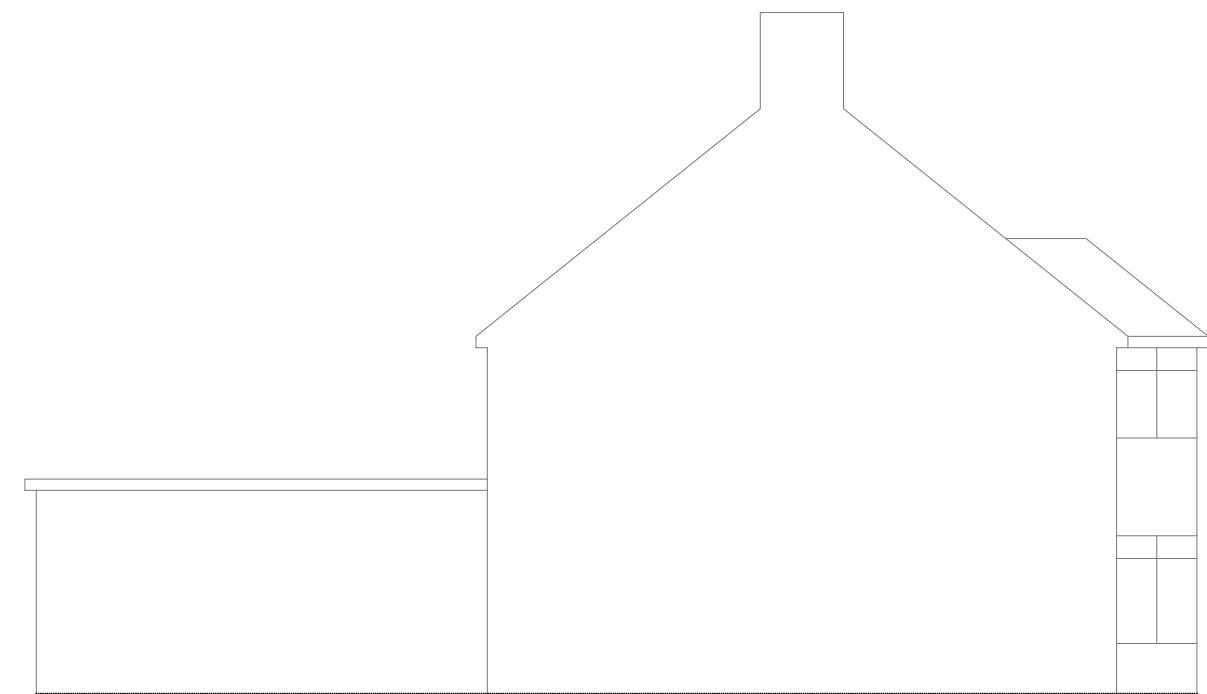

Side Elevation

Drawn By: VP
Job Ref: 23034
Date: Apr 2023
Drawing No. PL - 04

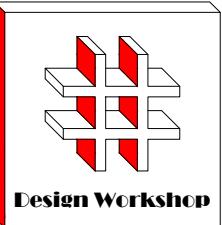

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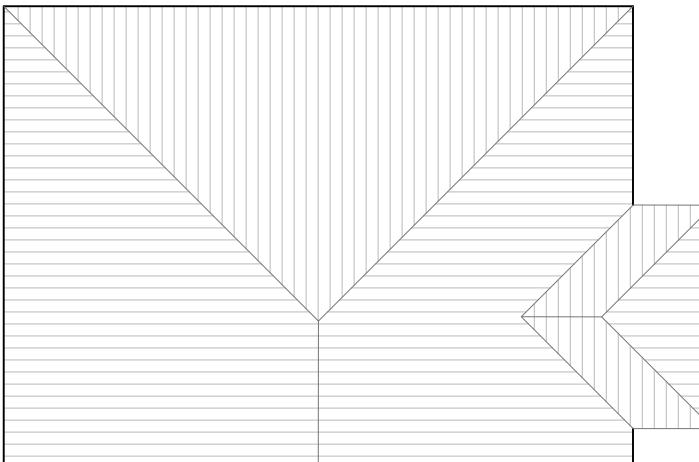
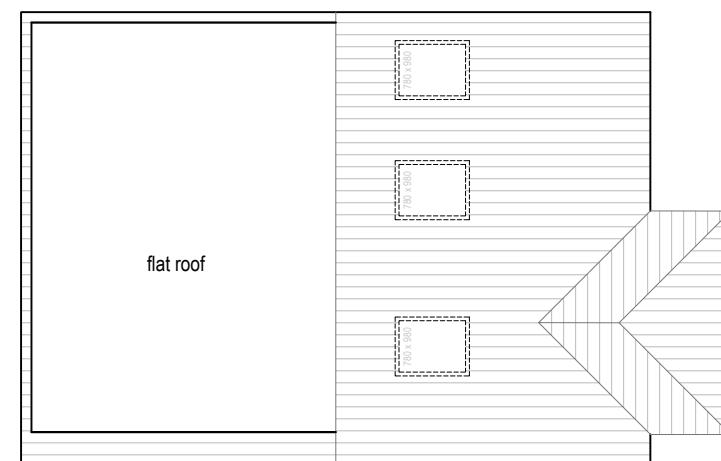
Title:

Existing & Proposed Roof and Loft Plans

Scale: 1:50, 1:100

Paper Size: A3

Rev A	Date 02.05.23	Comments roof lights added in roof plan
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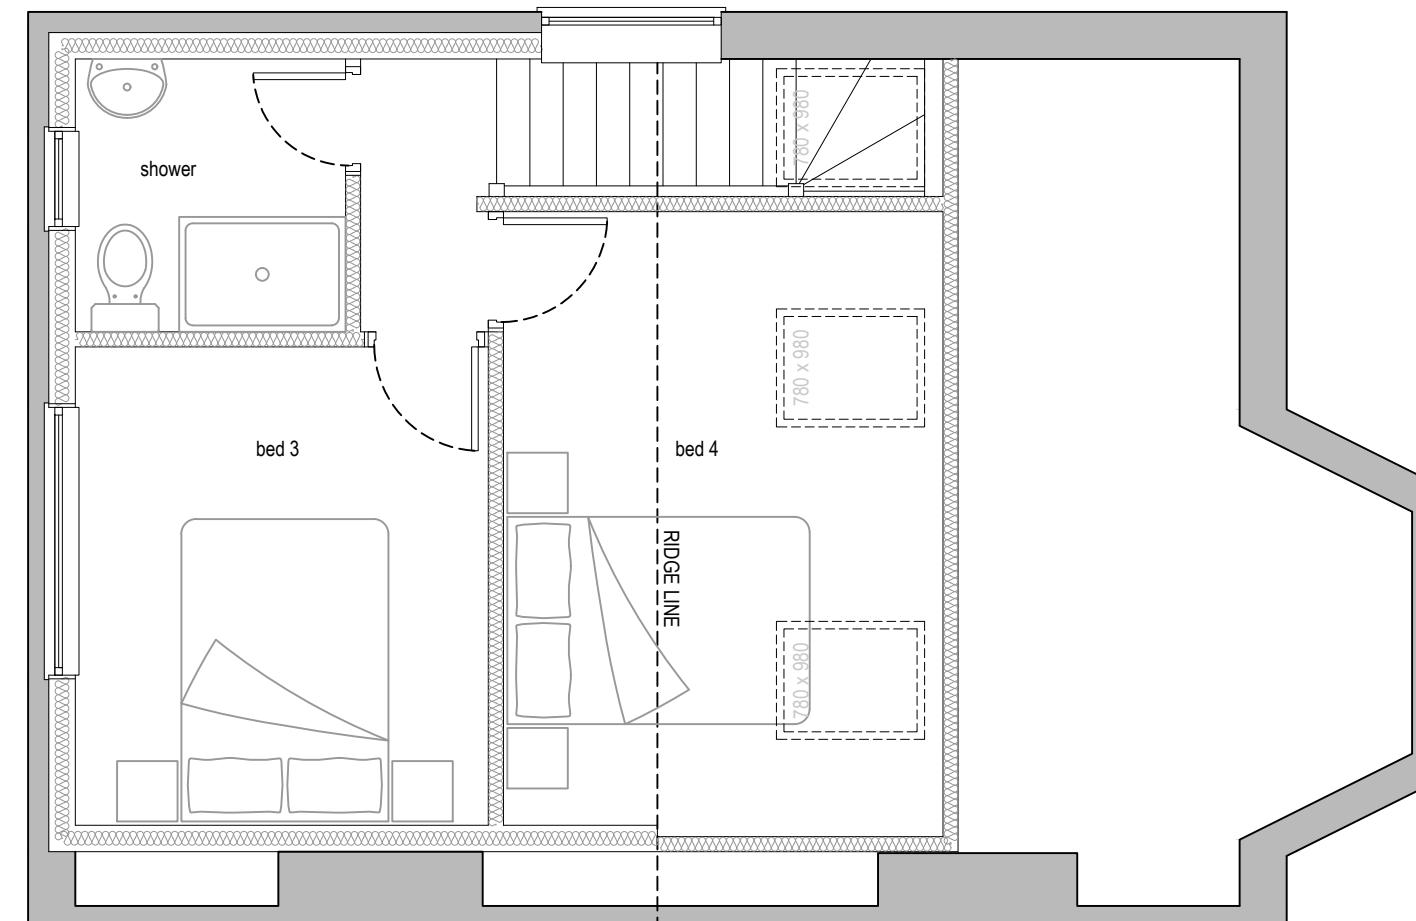


Proposed Roof Plan

0 1 2 3 4 5
metres 1:100 scale

Existing Roof Plan

0 1 2 3 4 5
metres 1:100 scale



Proposed Loft Plan


0 0.5 1.0 1.5 2.0 2.5
metres 1:50 scale

Drawn By: VP

Job Ref: 23034

Date: Apr 2023

Drawing No. PL - 03 Rev - A

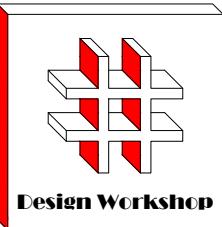

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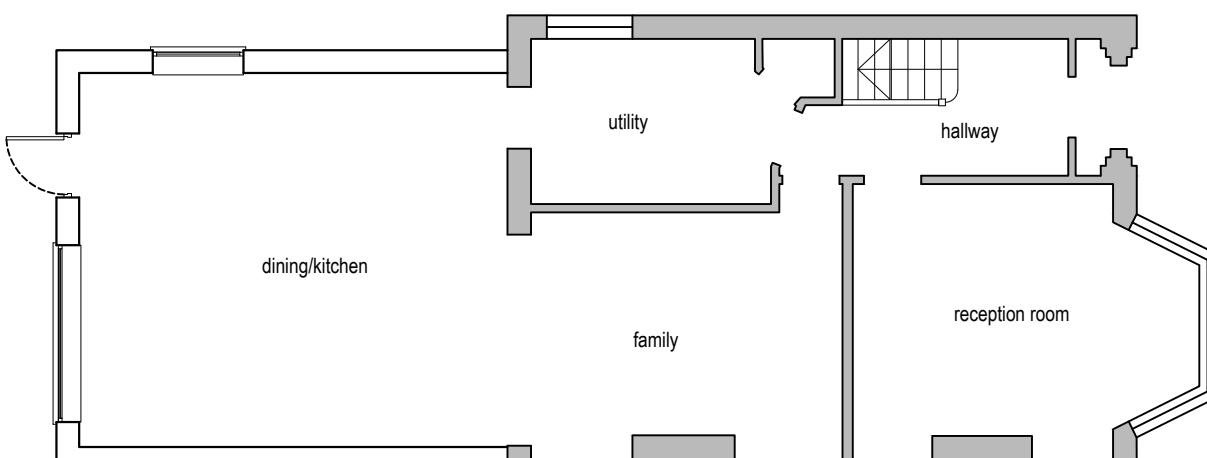
Existing & Proposed Floor Plans

Scale: 1:50, 1:100

Paper Size: A3


Rev Date Comments

Drawn By: VP
Job Ref: 23034
Date: Apr 2023
Drawing No. PL - 02




Existing Ground Floor Plan

0 1 2 3 4 5
metres 1:100 scale

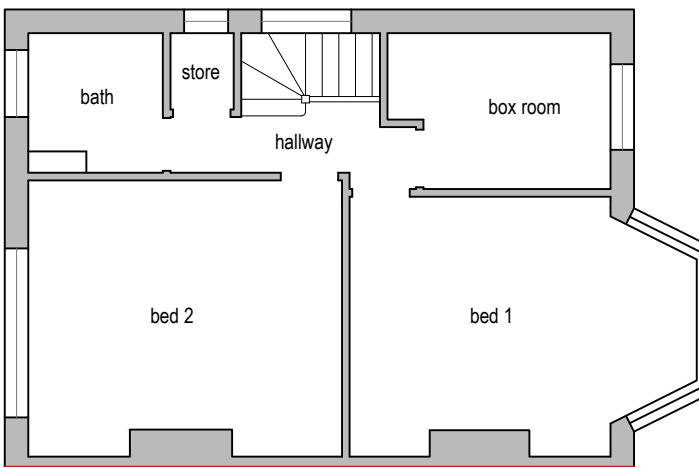


Existing First Floor Plan

0 1 2 3 4 5
metres 1:100 scale

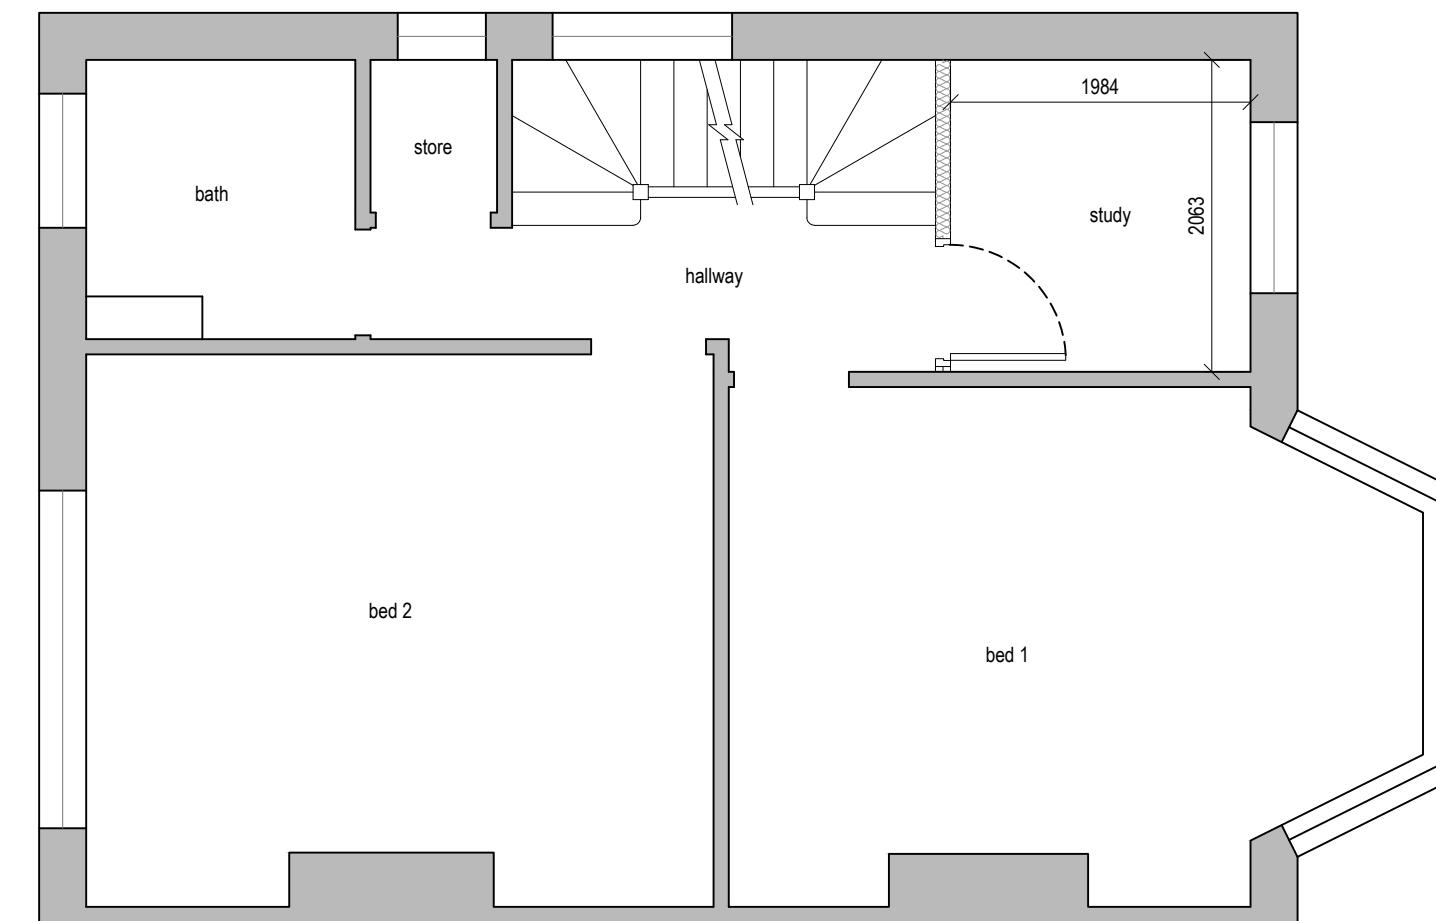

Proposed First Floor Plan

0 0.5 1.0 1.5 2.0 2.5
metres 1:50 scale

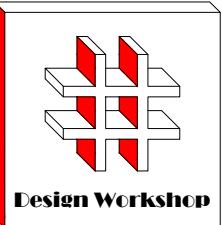

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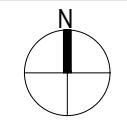
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Title:

Block and Location
Plans



Scale: 1:500, 1:1250

Paper Size: A3

Rev Date Comments



Block Plan

0 5 10 15 20 25
metres 1:500 scale



Site Location

0 10 20 30 40 50
metres 1:1250 scale

Drawn By: VP

Job Ref: 23034

Date: Apr 2023

Drawing No. PL - 01