

### VOLUME CALCULATION :-

#### 1. HIP TO GABLE :-

$$X-4.17 \times Y-3.33 \times Z-8.32 \times \frac{1}{6} = 19.25 \text{ m}^3$$

#### 2. DORMER :-

$$A-5.42 \times B-2.91 \times C-3.65 \times \frac{1}{2} = 28.78 \text{ m}^3$$

$$\text{TOTAL :- } 19.25 + 28.78 = 48.03 \text{ m}^3$$

Dimensions to be verified on site  
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Site Address:

247 Station Road  
Hayes  
UB3 4JD

Title:


Proposed Elevations

Scale: 1:100

Paper Size: A3

Rev Date Comments

Drawn By: VP  
Job Ref: 23034  
Date: Apr 2023  
Drawing No. PL - 05

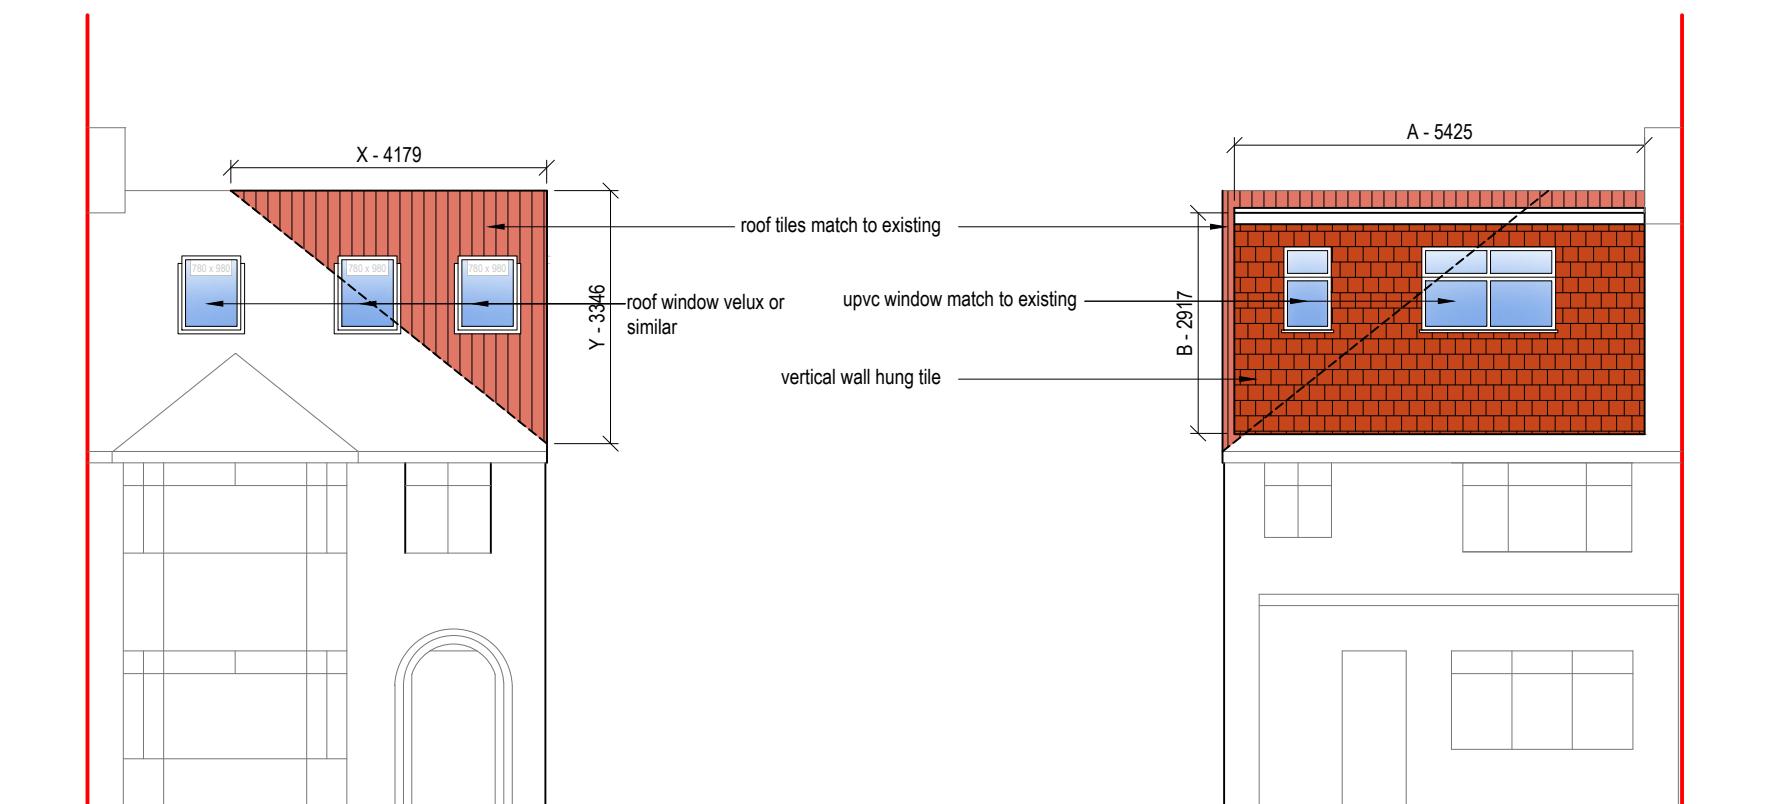

Front Elevation

0 1 2 3 4 5  
metres 1:100 scale


Rear Elevation

0 1 2 3 4 5  
metres 1:100 scale

### NOTE:

ANY WINDOW INSERTED ON WALL OR ROOF SLOPE FORMING A SIDE ELEVATION OF THE DWELLING SHALL BE:

1. OBSECURE P GLAZED
2. NON- OPENING UNLESS THE PARTS OF THE WINDOW WHICH CAN BE OPENED ARE MORE THAN 1.7 METERS ABOVE THE FLOOR OF THE ROOM IN WHICH THE WINDOW IS INSTALLED.
3. ROOF WINDOW WILL NOT PROTRUDE MORE THAN 150MM

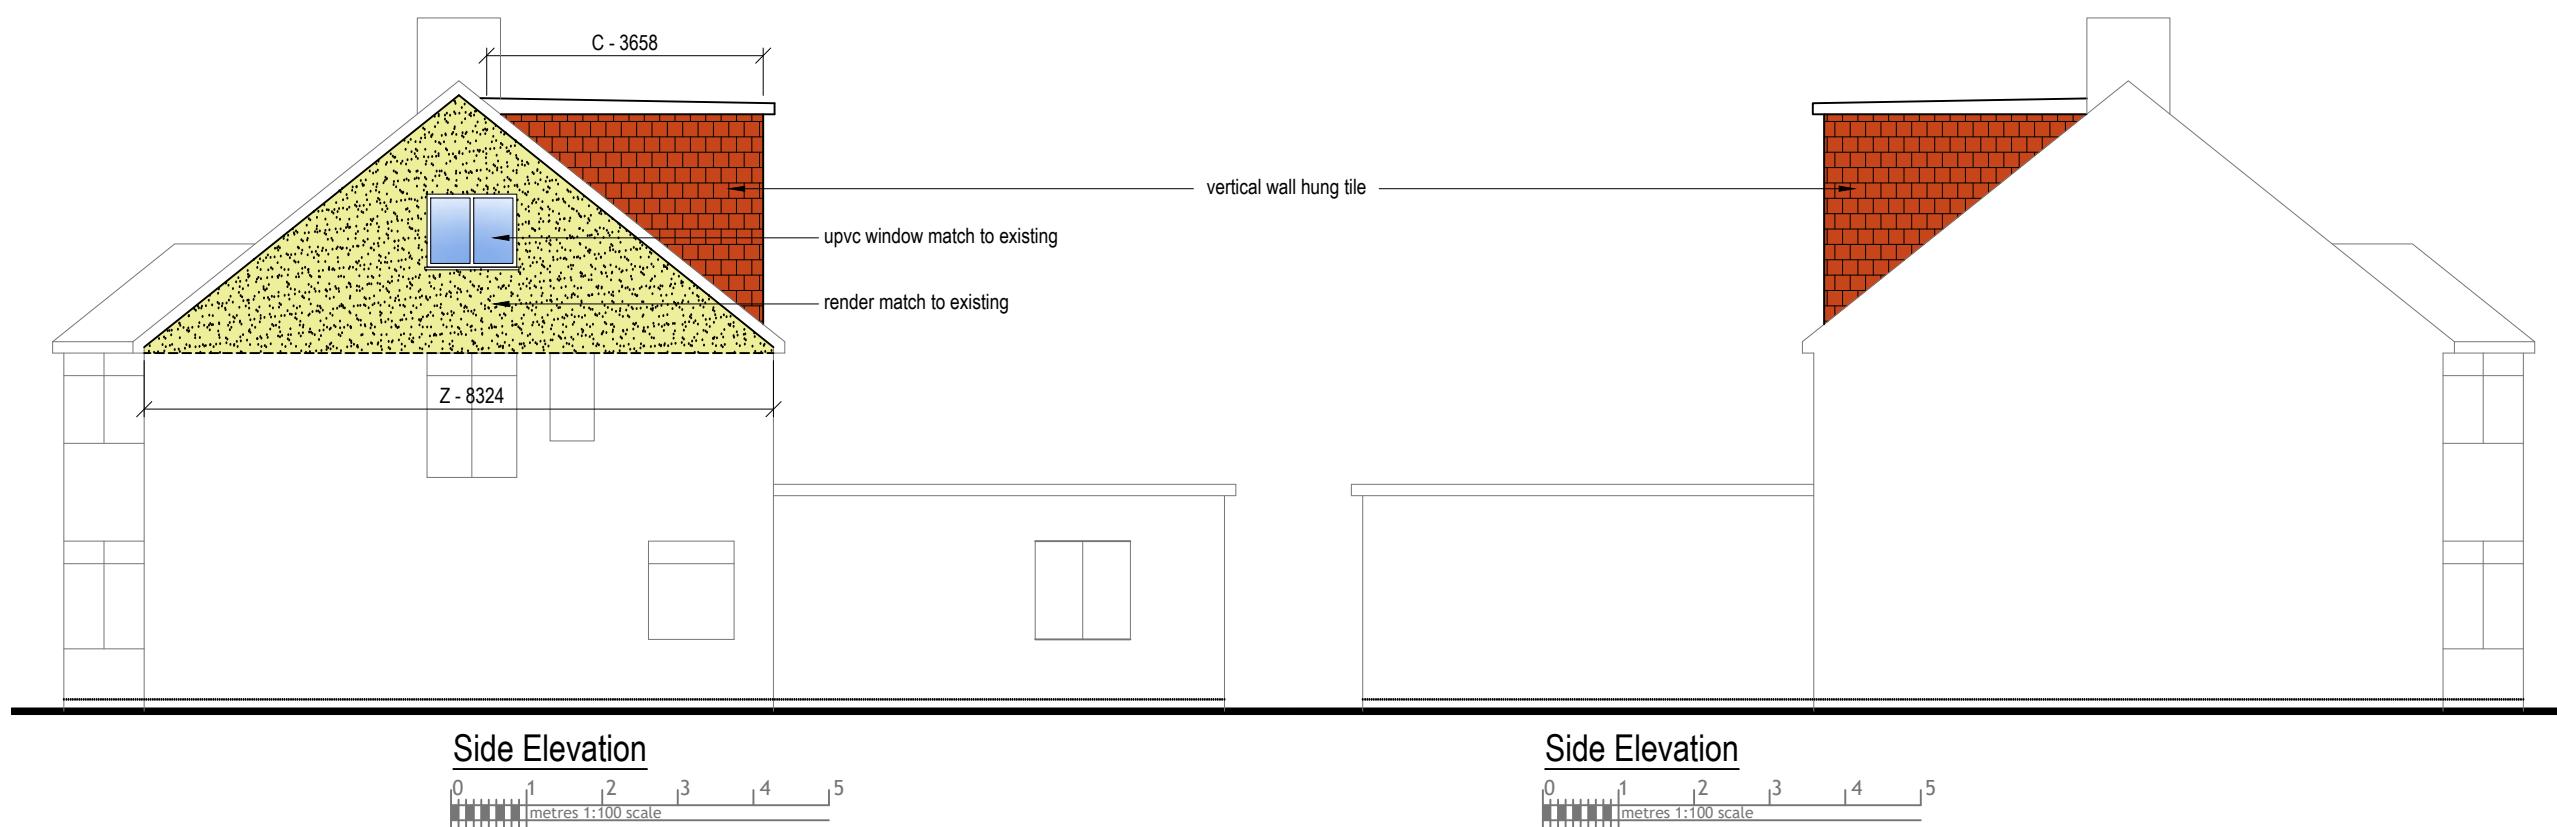

Side Elevation

0 1 2 3 4 5  
metres 1:100 scale

Side Elevation

0 1 2 3 4 5  
metres 1:100 scale



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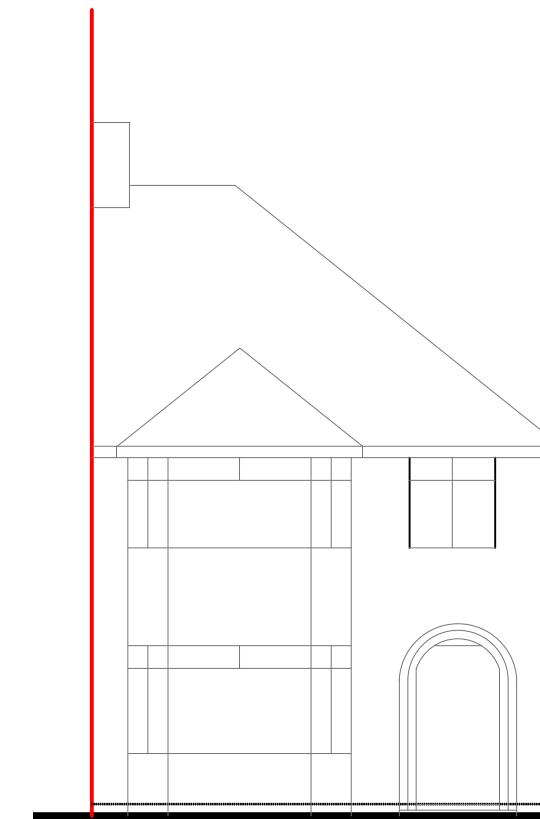
Title:

Existing Elevations

Scale: 1:100


Paper Size: A3

Rev Date Comments




Front Elevation

0 1 2 3 4 5  
metres 1:100 scale

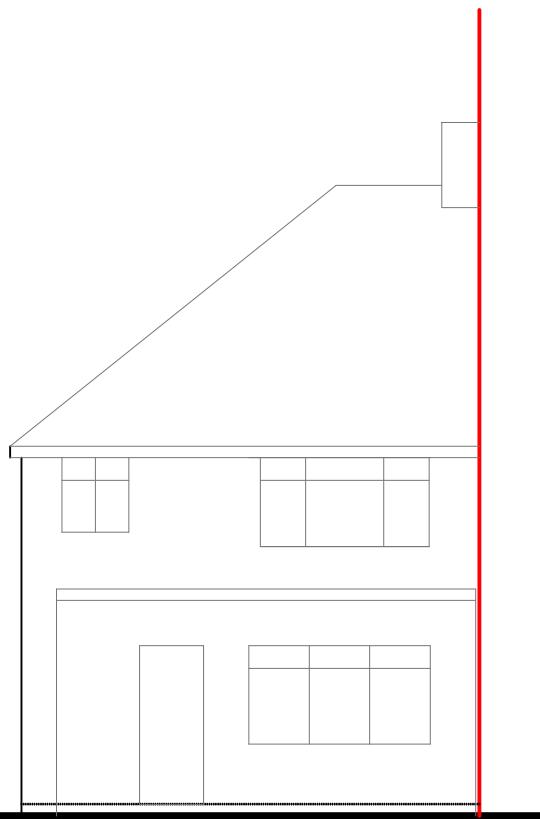


Rear Elevation

0 1 2 3 4 5  
metres 1:100 scale

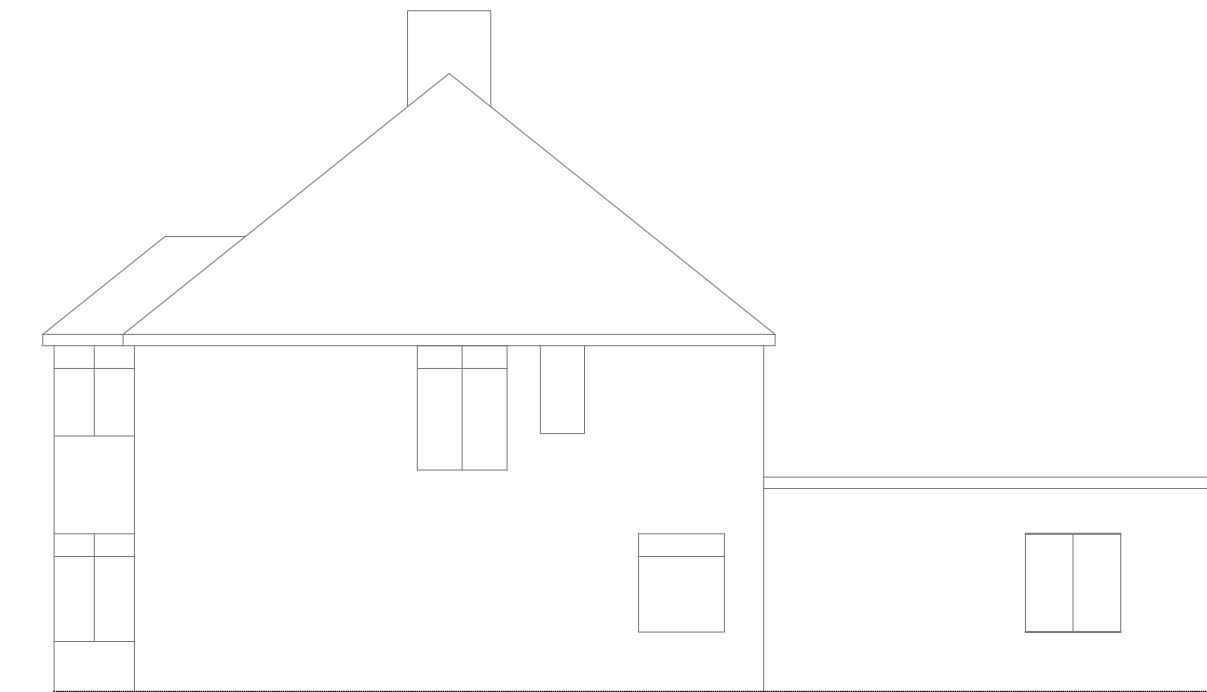

Side Elevation

0 1 2 3 4 5  
metres 1:100 scale

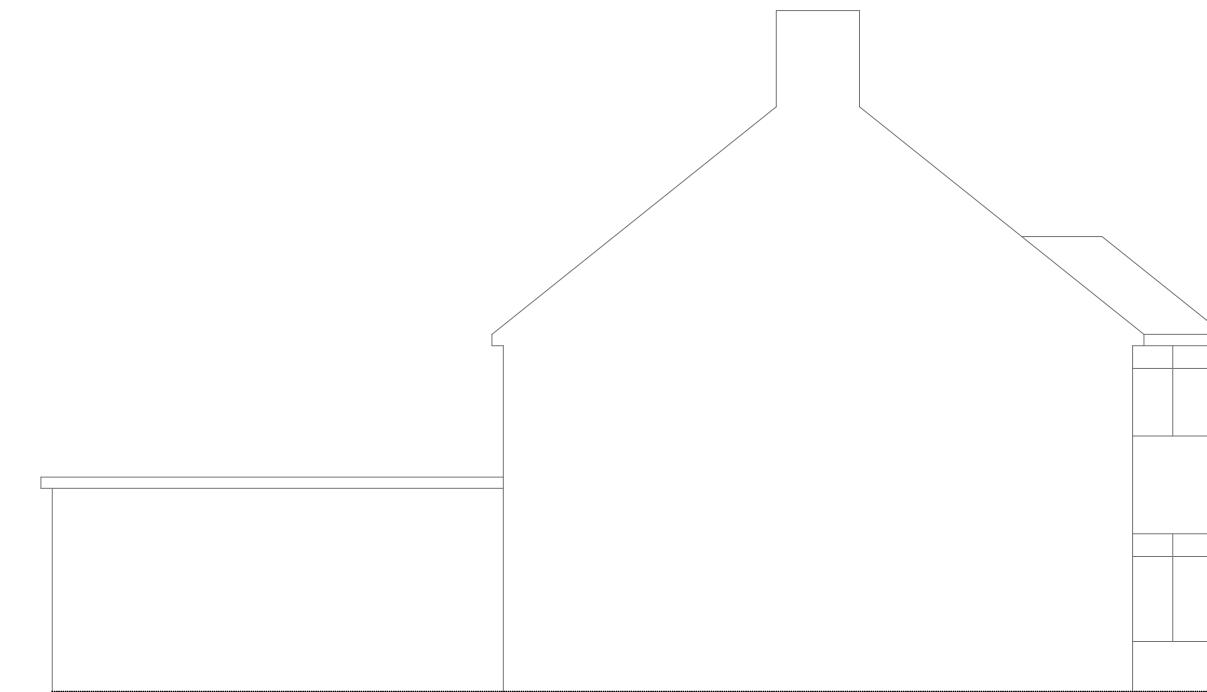

Side Elevation


0 1 2 3 4 5  
metres 1:100 scale

Drawn By: VP

Job Ref: 23034

Date: Apr 2023

Drawing No. PL - 04

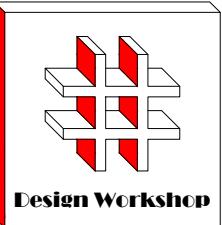

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Title:


Existing & Proposed Roof and Loft Plans

Scale: 1:50, 1:100

Paper Size: A3


Rev Date Comments

Drawn By: VP  
Job Ref: 23034  
Date: Apr 2023  
Drawing No. PL - 03

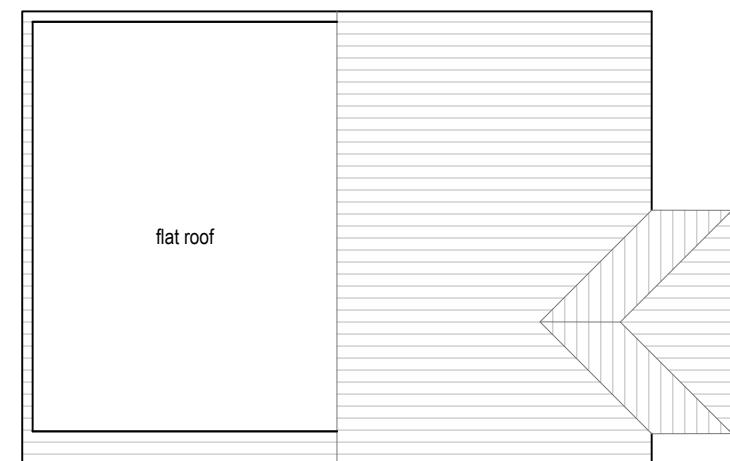


Proposed Roof Plan

0 1 2 3 4 5  
metres 1:100 scale

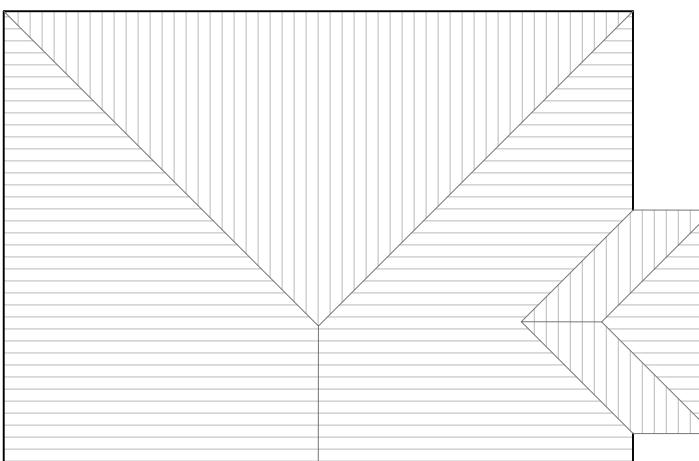


Existing Roof Plan

0 1 2 3 4 5  
metres 1:100 scale

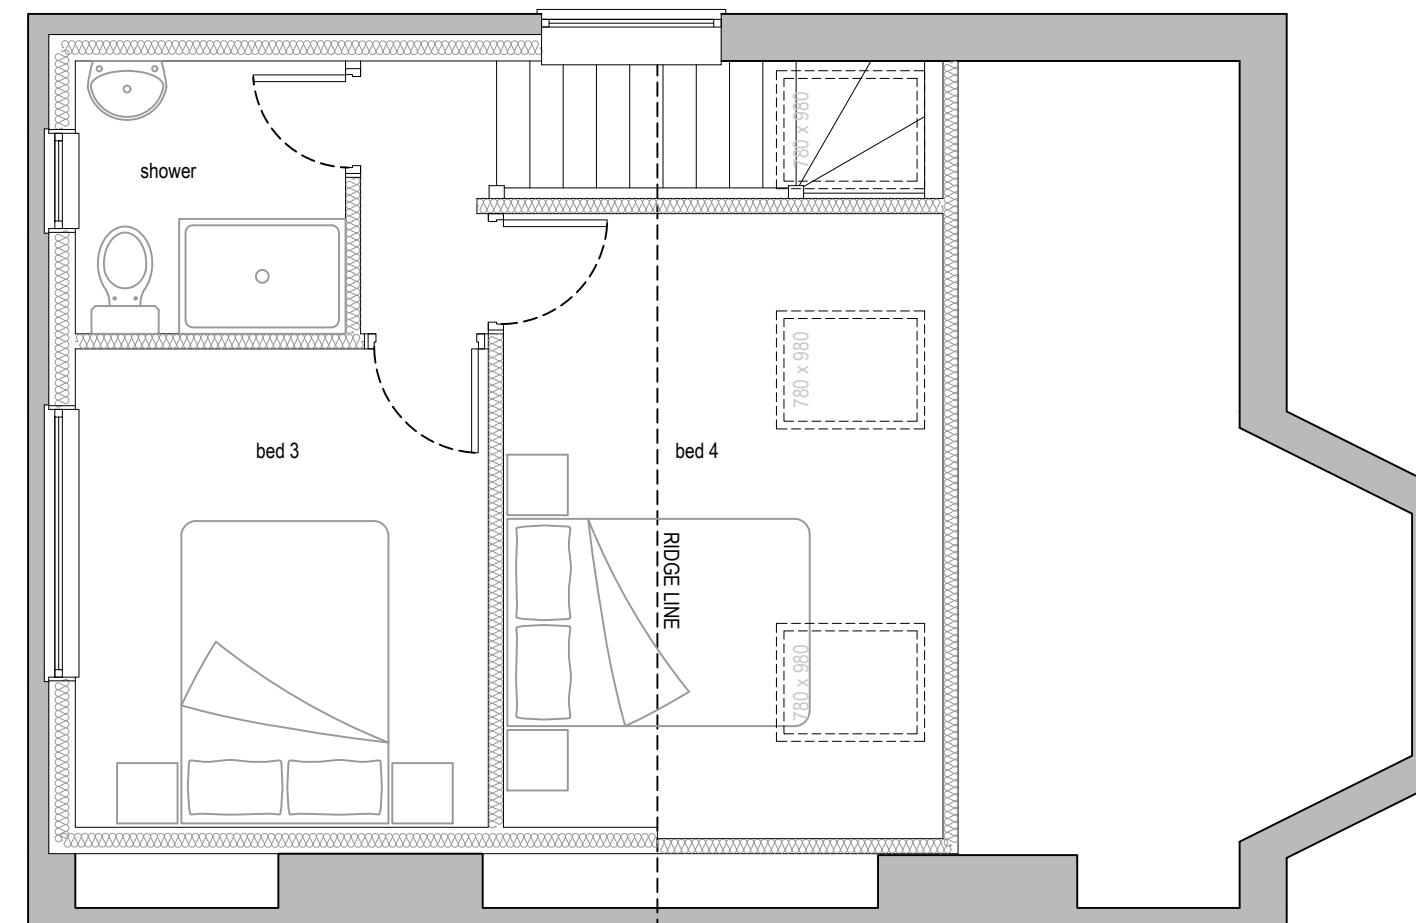

Proposed Loft Plan

0 0.5 1.0 1.5 2.0 2.5  
metres 1:50 scale

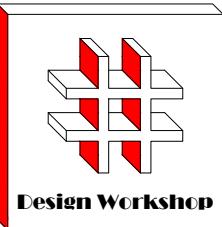

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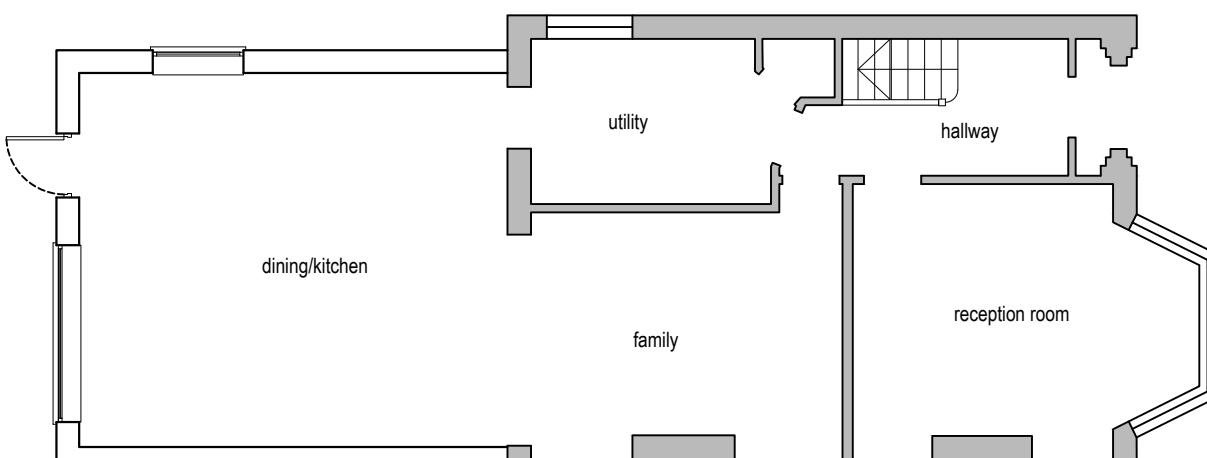
Existing & Proposed Floor Plans

Scale: 1:50, 1:100

Paper Size: A3


Rev Date Comments

Drawn By: VP  
Job Ref: 23034  
Date: Apr 2023  
Drawing No. PL - 02




Existing Ground Floor Plan

0 1 2 3 4 5  
metres 1:100 scale

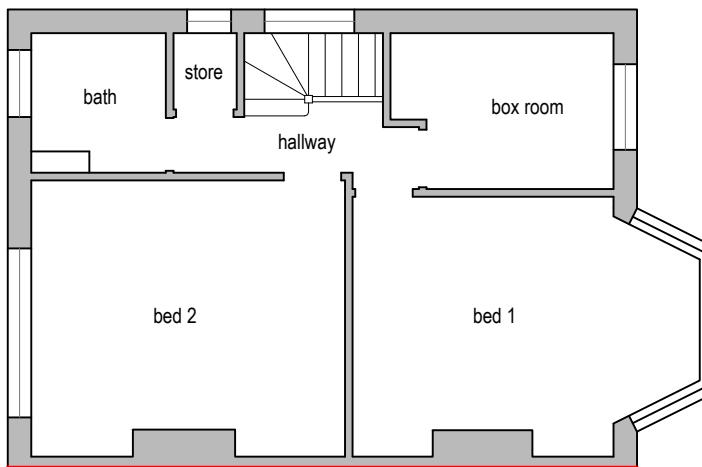


Existing First Floor Plan

0 1 2 3 4 5  
metres 1:100 scale

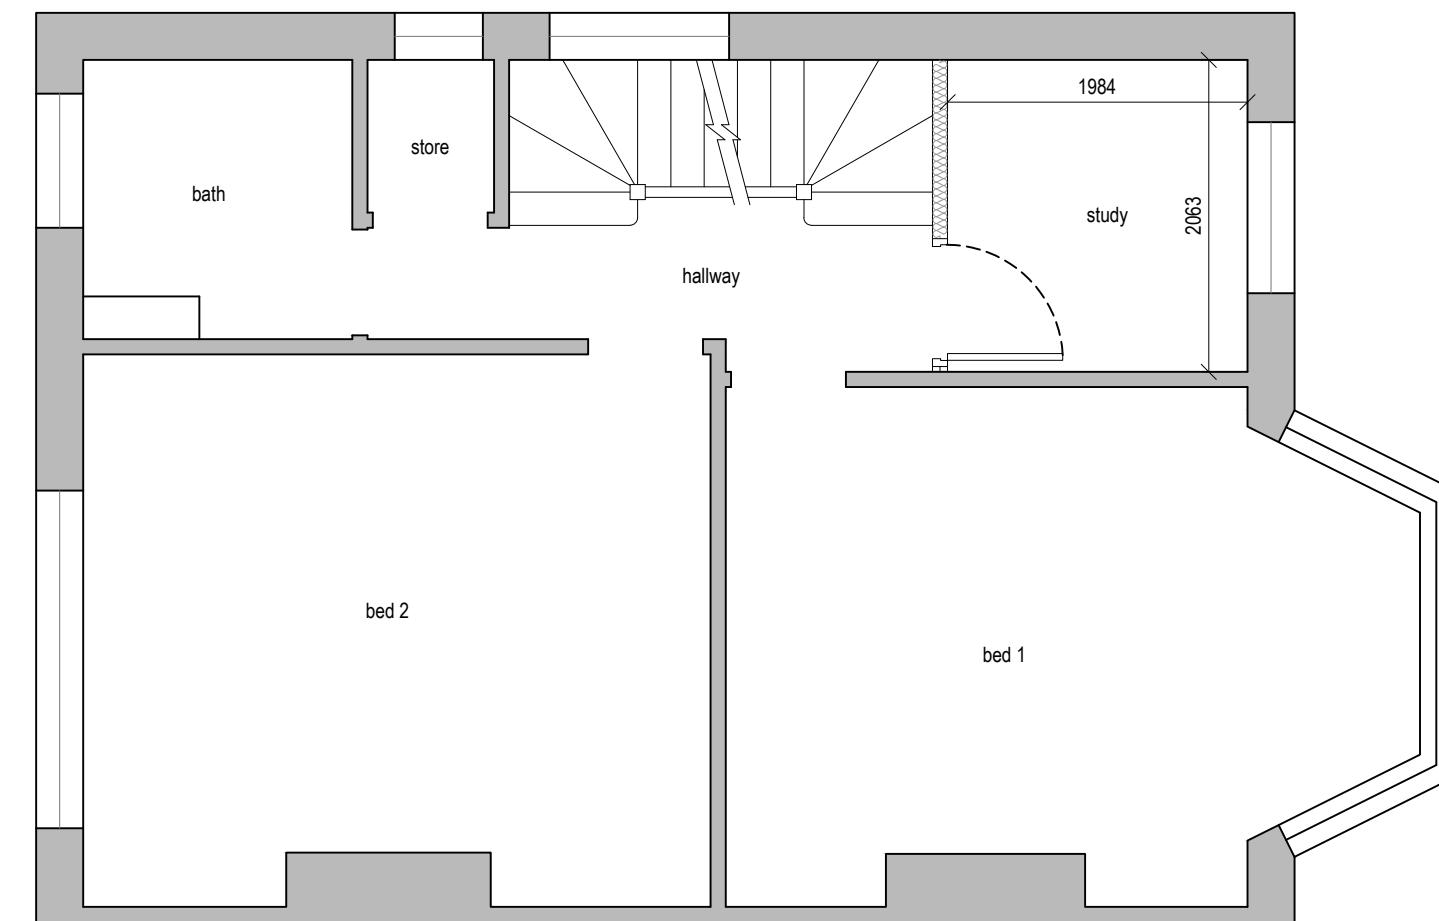

Proposed First Floor Plan

0 0.5 1.0 1.5 2.0 2.5  
metres 1:50 scale

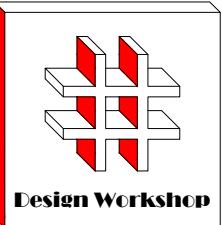

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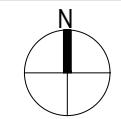
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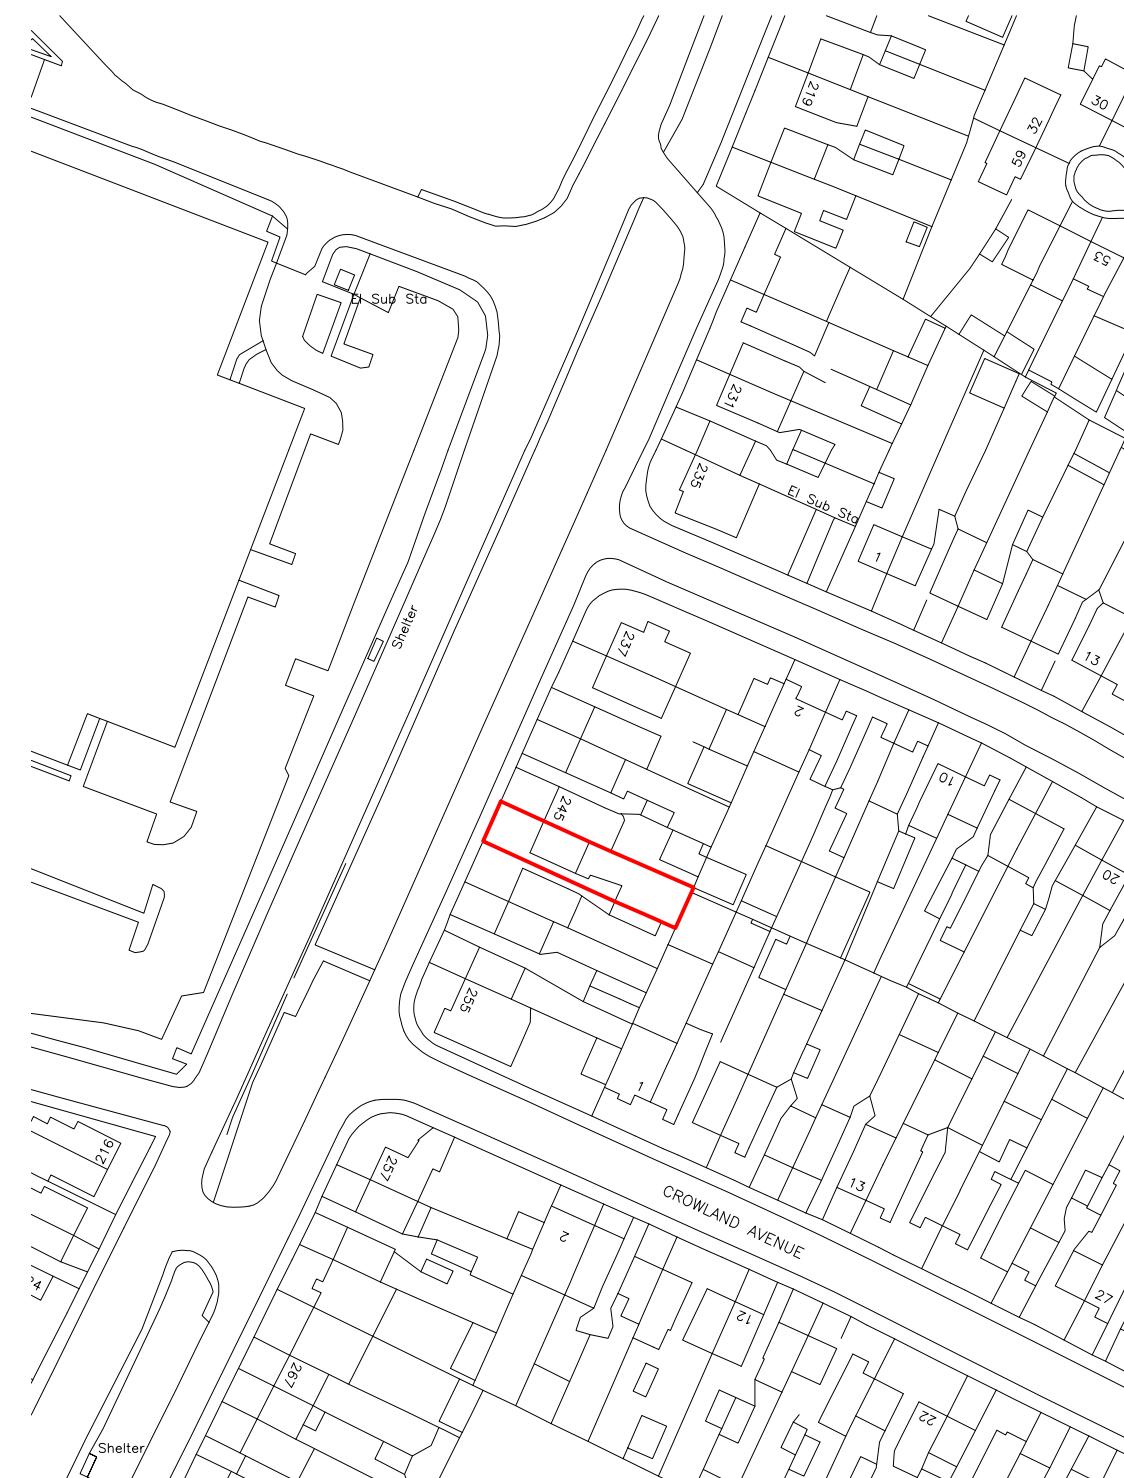
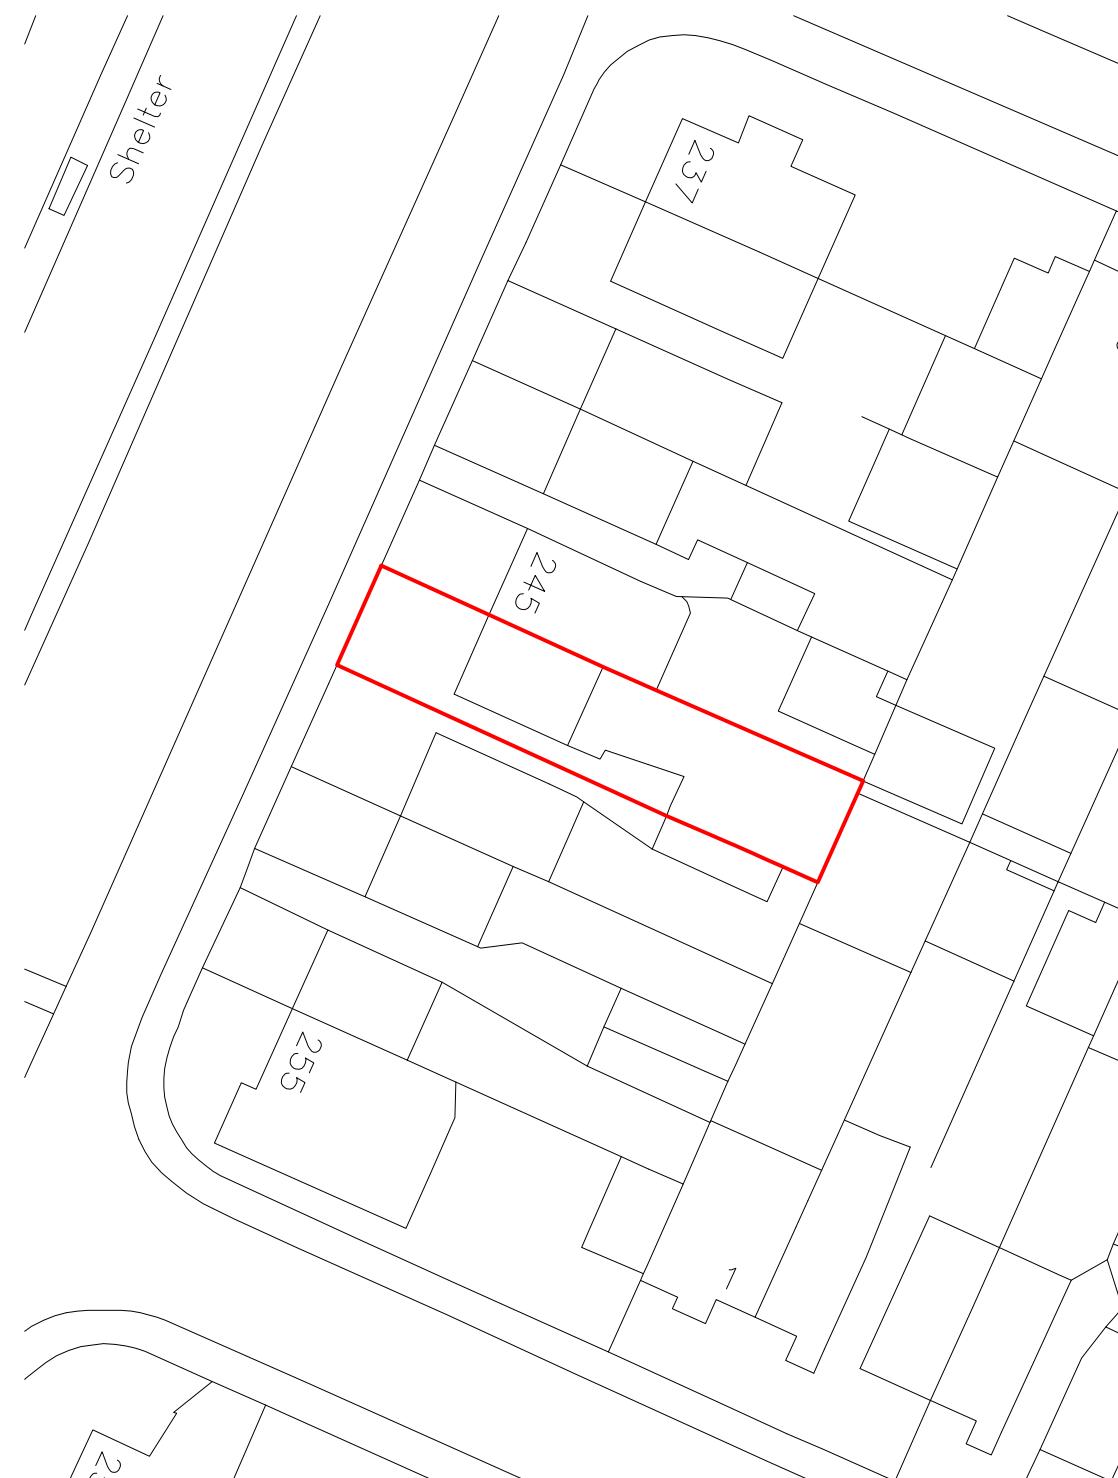
Block and Location  
Plans



Scale: 1:500, 1:1250

Paper Size: A3

Rev Date Comments



Drawn By: VP  
Job Ref: 23034  
Date: Apr 2023  
Drawing No. PL - 01