


Existing Ground Floor Plan

Scale 1:100

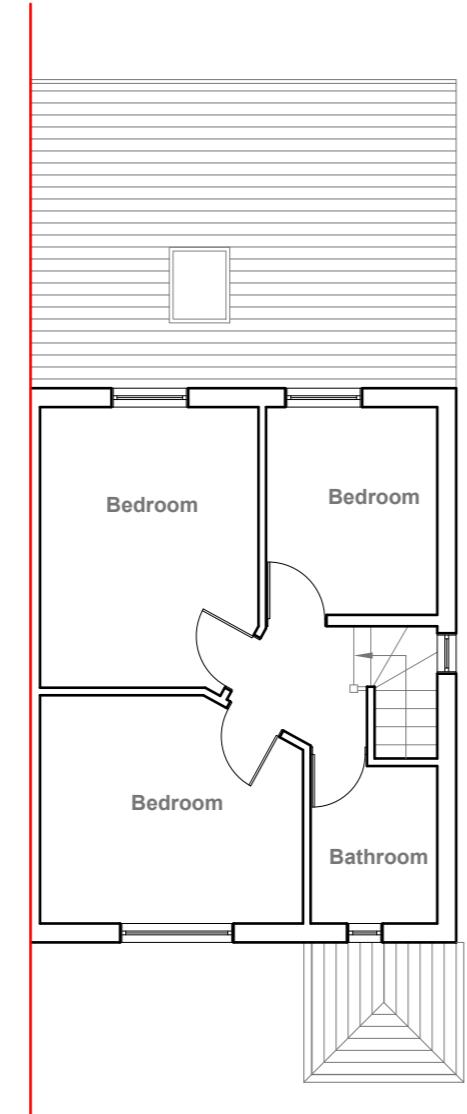

Existing First Floor Plan


Scale 1:100

1:100 0 1 2 5 10 Meter



Existing Front Elevation

Scale 1:100

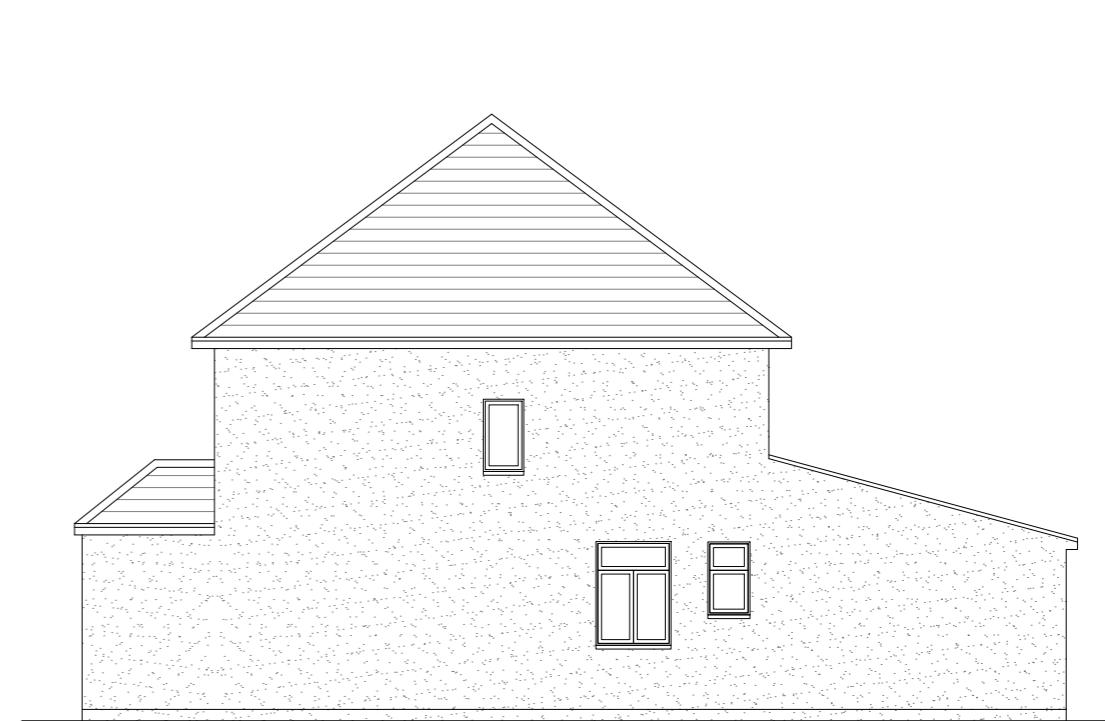


Existing Side Elevation

Scale 1:100



Existing Rear Elevation

Scale 1:100

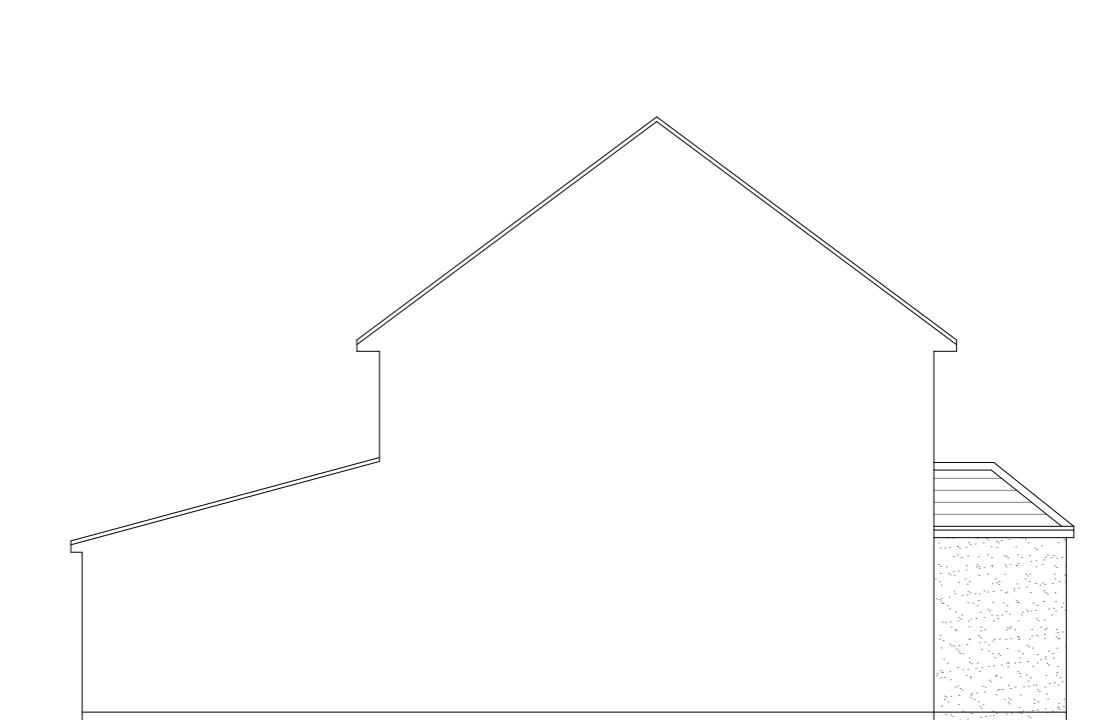

Existing Side Elevation

Scale 1:100

GENERAL NOTES:

1. ALL DIMENSIONS ARE IN MILLIMETER.
2. VERIFY ALL DIMENSIONS AND CONDITIONS BEFORE BUILDING OR STARTING CONSTRUCTION. NOTIFY THE DESIGNER IMMEDIATELY OF ANY DISCREPANCY OR VARIATION.
3. ALL WORK TO COMPLY WITH CURRENT BUILDING REGULATIONS AND CODES OF PRACTICE

Title:

Existing Floor Plans & Elevations

Site Address



32 Browngraves
Road,
Hayes, Middx.
UB3 5BN

Scale: 1:100 @A3

Date: 19/10/2022
Drawing No.: 2022/141 -01
Drawn By: RO

Revision Date:

Faluck Patel

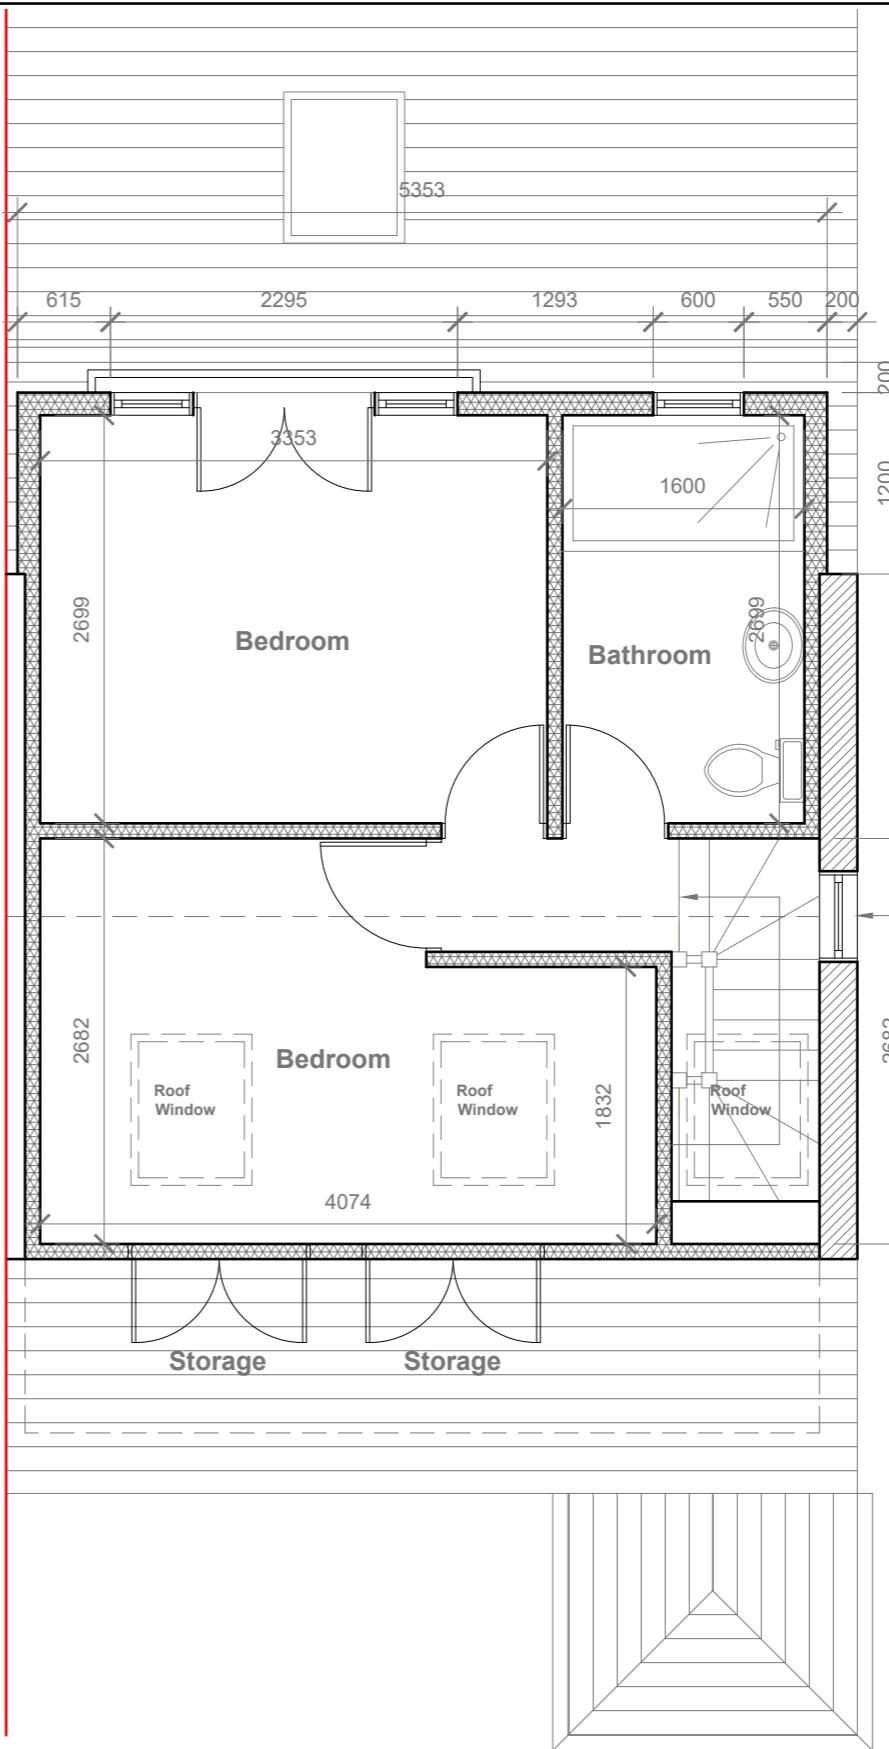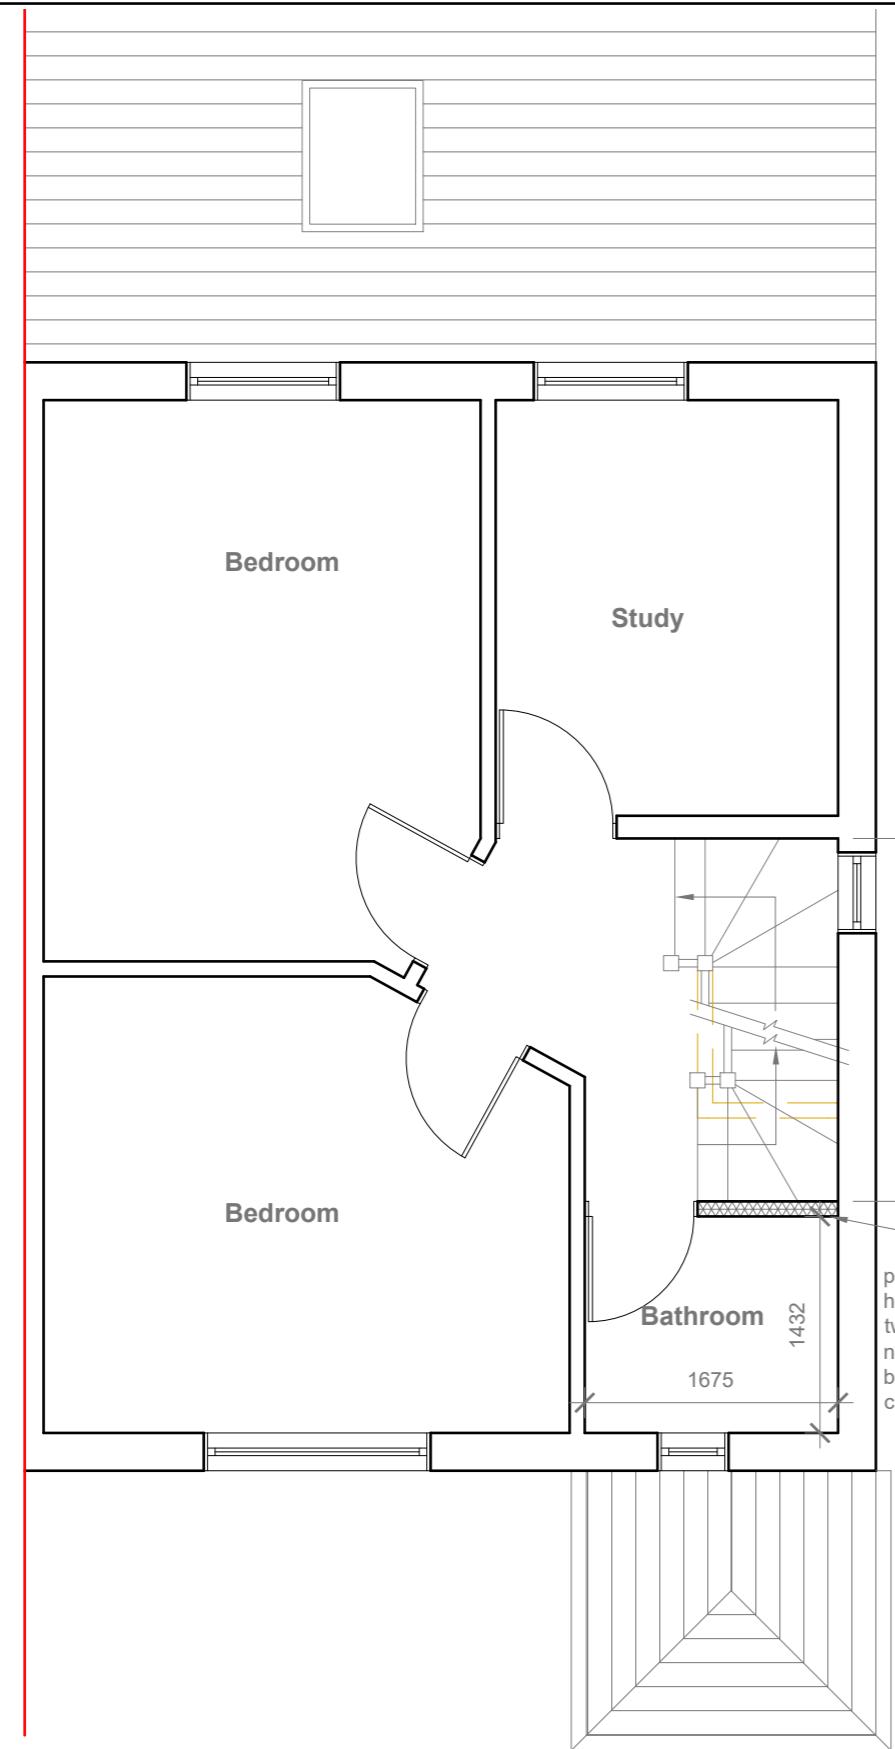

Velux Window to be installed as per manufacturer specification, not projected more than 150mm from the plane of roof slope

Proposed First Floor & Loft Plans




Proposed Front Elevation
Scale 1:100



Proposed Side Elevation
Scale 1:100



Proposed Rear Elevation
Scale 1:100

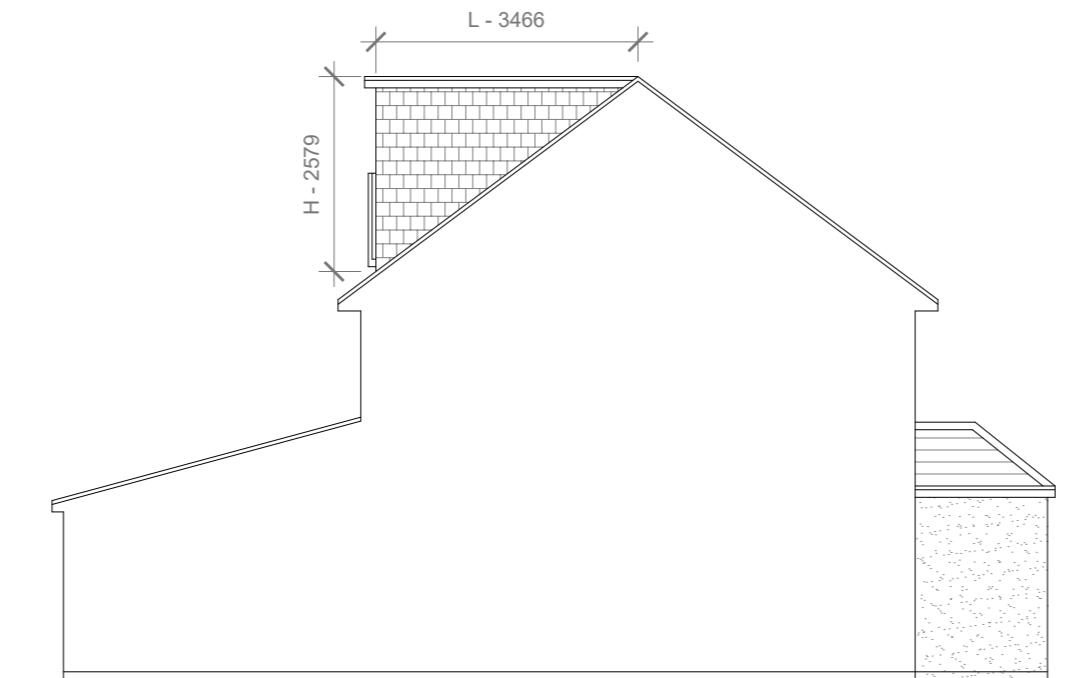

Proposed Side Elevation
Scale 1:100

Proposed External Finish
Materials to Match Existing
External Finish Materials

$$\text{REAR DORMER VOLUME} = \frac{W \times H \times L / 2}{2} \\ 5.353 \times 2.579 \times 3.466 / 2 \\ 47.84 / 2 \\ 23.92 \text{ CU.MT.}$$

$$\text{HIP TO GABLE ROOF VOLUME} = \frac{W1 \times H1 \times L1 / 6}{6} \\ 7.931 \times 3.101 \times 3.665 / 6 \\ 90.20 / 6 \\ 15.03 \text{ CU.MT.}$$

$$\text{TOTAL ROOF VOLUME} = V1 + V2 \\ 24.53 + 20.68 \\ 38.95 \text{ CU.MT.} < 50.00 \text{ CU.MT.}$$

10 Meter
5
2
1
0
1:100

GENERAL NOTES:
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AND CODES OF PRACTICE

Title:

Proposed Elevations

Site Address
32 Browngraves
Road,
Hayes, Middx.
UB3 5BN

Scale: 1:100 @A3
Date: 19/10/2022
Drawing No.: 2022/141 -03
Drawn By: RO

Revision Date:
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Patel**