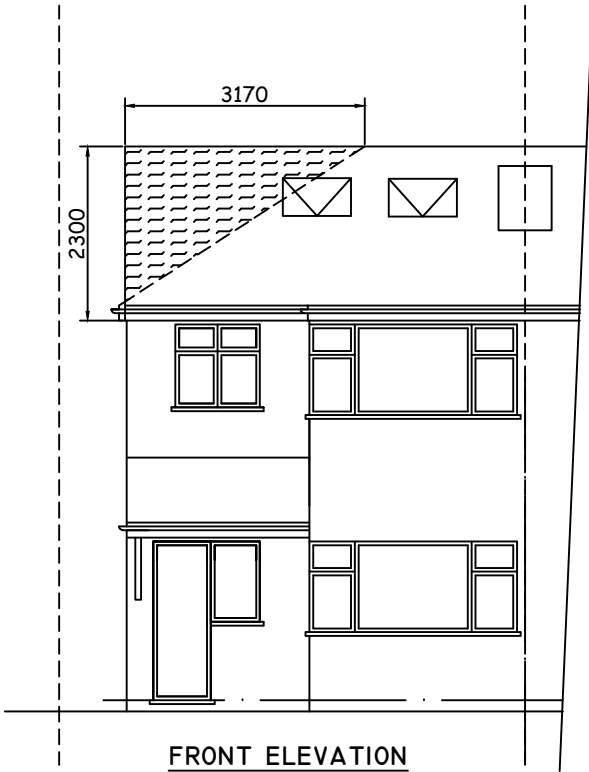


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MARKED	REVISION	DATE
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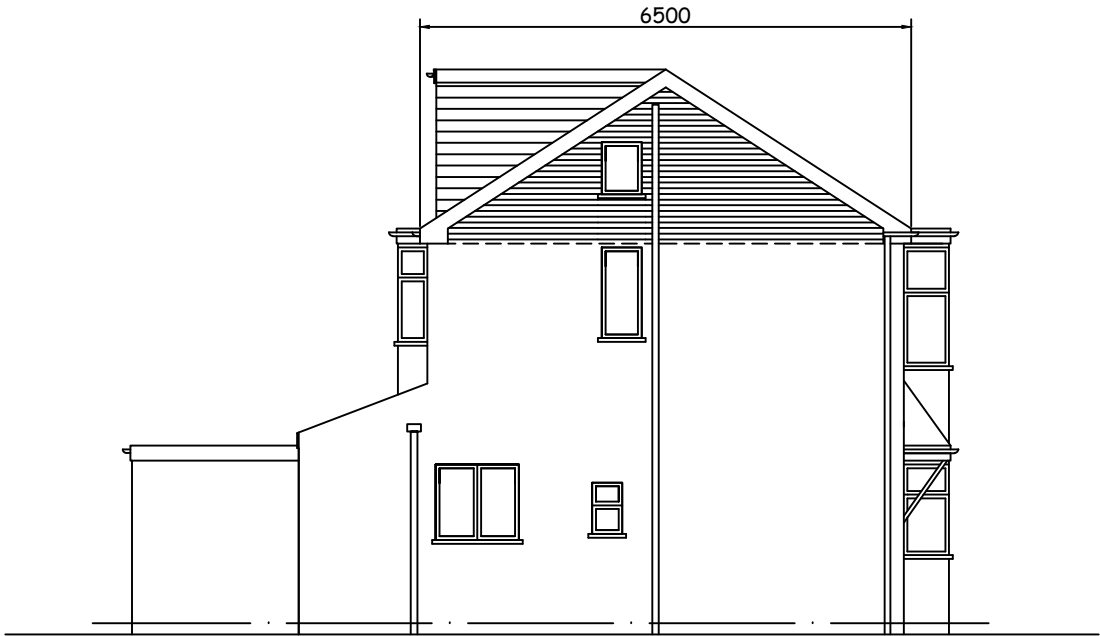


FRONT ELEVATION

ROOF LIGHT NOT TO
PROTRUDE 150MM BEYOND
THE ROOF SLOPE

TILES TO MATCH
EXISTING

RENDER TO MATCH
EXISTING




SIDE ELEVATION

- NOTES:
- 1.WINDOW IN GABLE WALL TO BE OBSCURE-GLAZED LEVEL 3,
AND FIXED SHUT TO 1.7M ABOVE STAIRS - MEASURED AT CENTRE
LINE OF THE WINDOW AND THE STEP BELOW THAT CENTRE LINE
 - 2.EXTERNAL MATERIALS TO MATCH EXISTING
 - 3.ROOF LIGHT NOT TO PROTRUDE 150MM BEYOND THE ROOF SLOPE

VOLUME OF LOFT
= $6.500 \times 3.170 \times 2.300 / 6 + 4.960 \times 3.035 \times 1.970 / 2$
= $22.7\text{M}^3 < 50.0\text{M}^3$ COMPLIES WITH GENERAL PERMITTED
DEVELOPMENT ORDER (NO.2) ORDER 2008



REAR ELEVATION

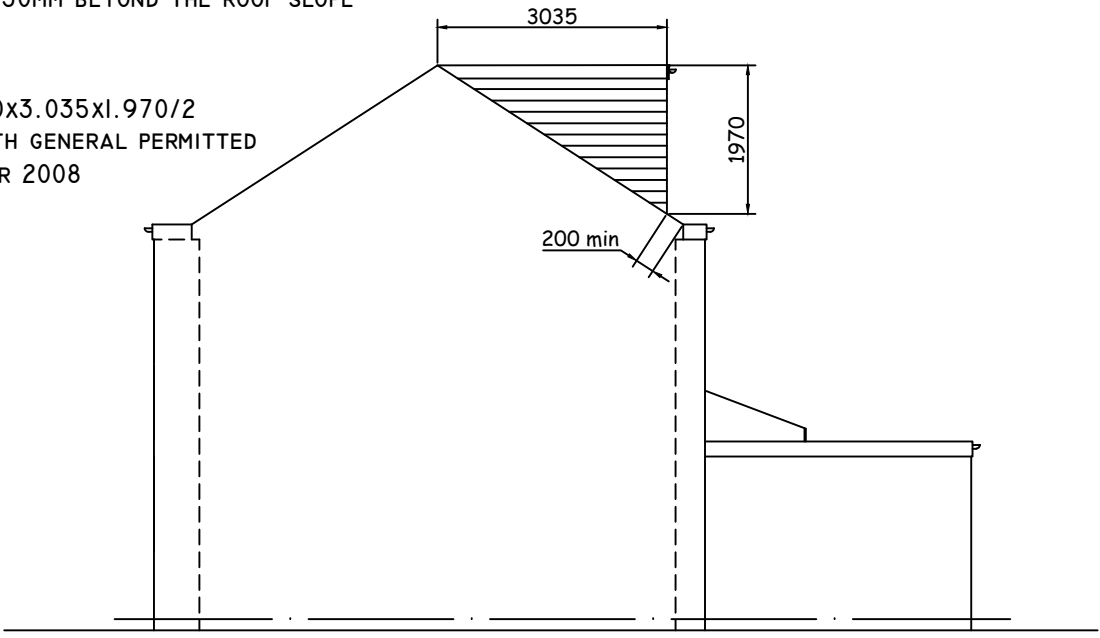

FLANK ELEVATION

0 10M

	CHECKED:	DATE: FEB 2024	DRAWING TITLE: PROPOSED ELEVATIONS	PROJECT: 223 LANSBURY DRIVE HAYES UB4 8RT	
	DRAWN:	SCALE: 1:100			
	DRAWING NUMBER: L5				