

### VOLUME CALCULATION

PROPOSED GABLE EXTENSION

$$\text{Vol 1} = \frac{(8.21 \times 3.3 \times 0.5 \times 4.1)}{3} = 18.5 \text{m}^3$$

PROPOSED DORMER

$$\text{Vol 2} = 3.57 \times 2.69 \times 0.5 \times 4.93 = 23.7 \text{m}^3$$

TOTAL EXTENSION

$$\text{Total Vol} = \text{Vol 1} + \text{Vol 2}$$


$$= 18.5 + 23.7$$

$$= 42.2 \text{m}^3$$

TOTAL VOLUME PROPOSED = 42.2m<sup>3</sup>  
LESS THAN THE 50m<sup>3</sup> ALLOWED UNDER PERMITTED  
DEVELOPMENT FOR LOFT EXTENSIONS



North East Elevation

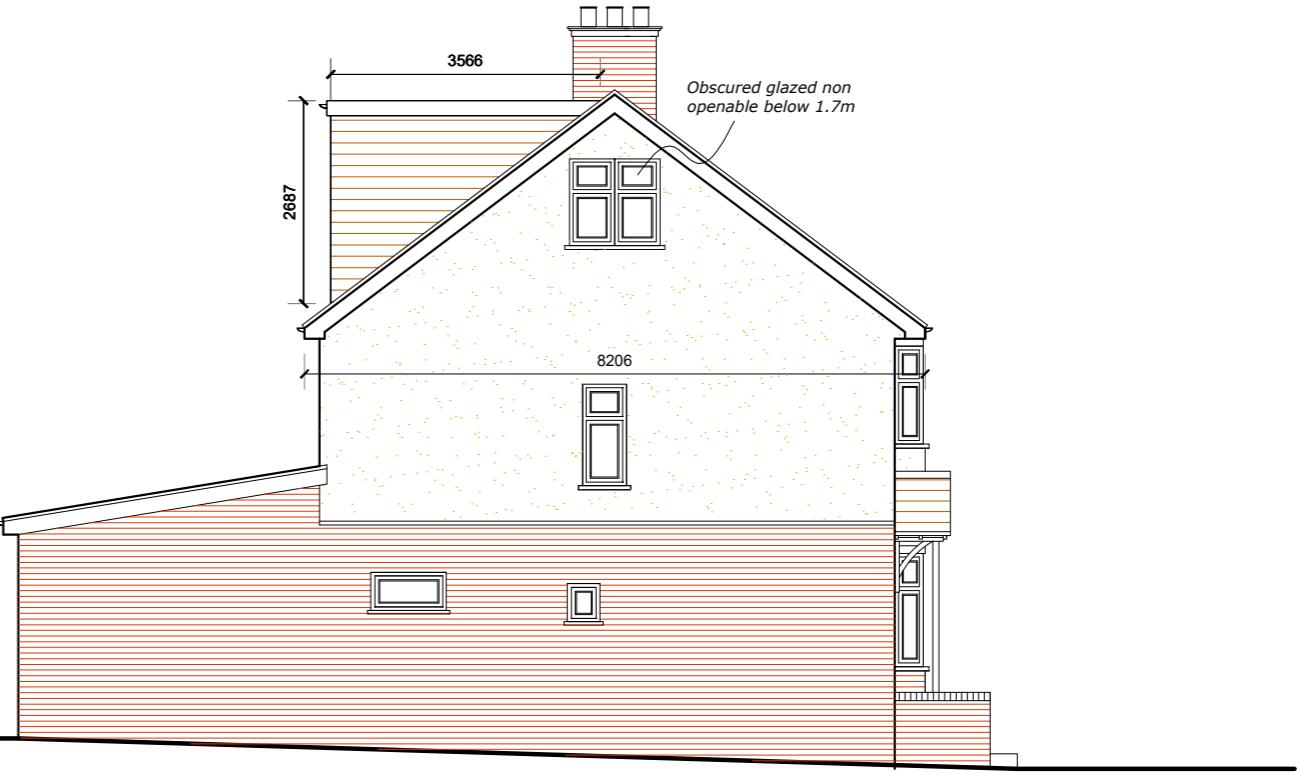


South East Elevation



South West Elevation

ALL MATERIALS TO MATCH EXISTING

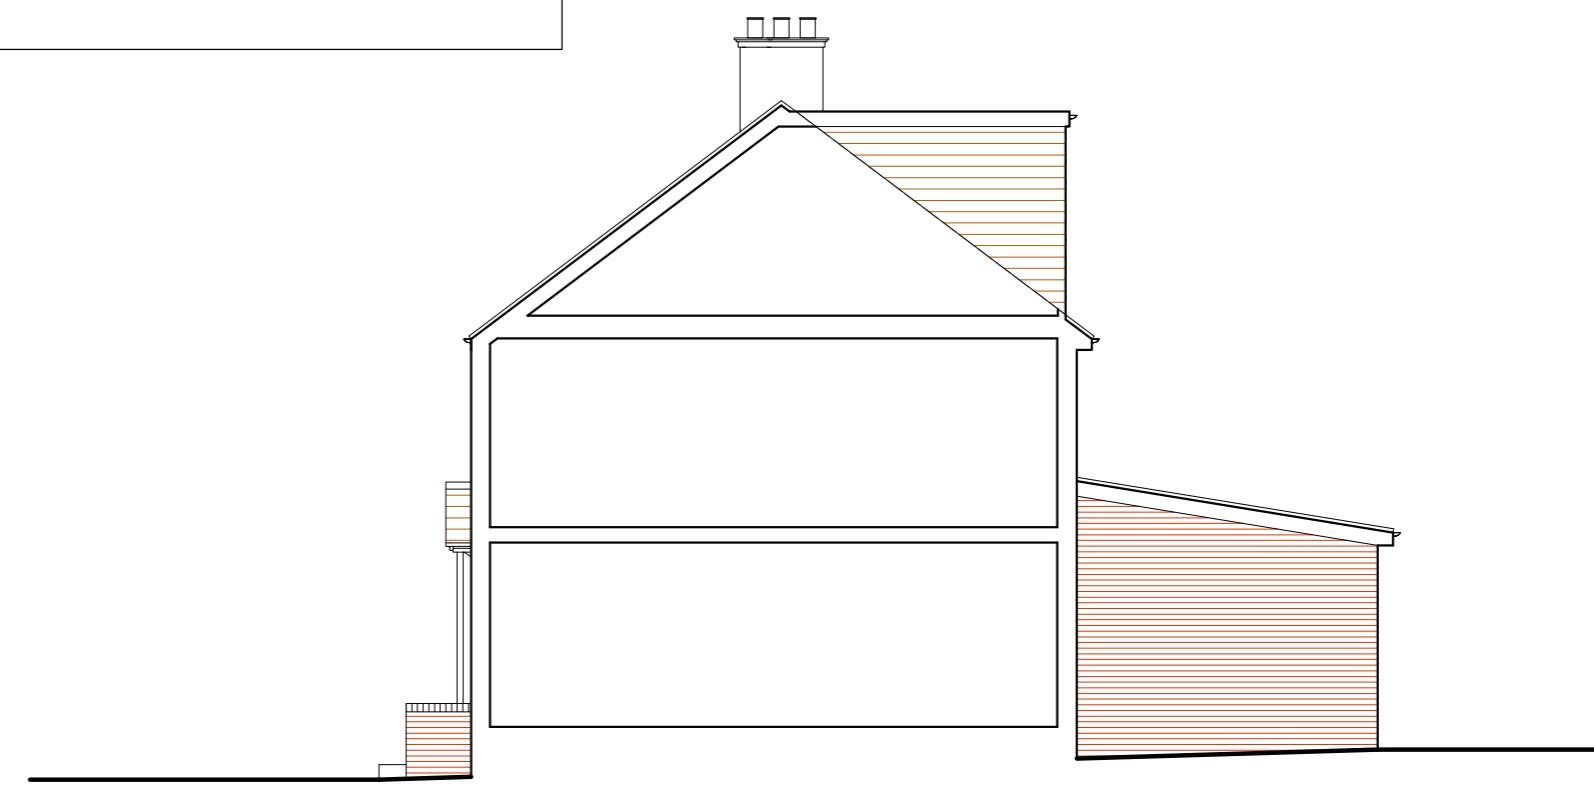

North West Elevation

### PROPOSED ELEVATIONS

73 Hayes End Road, Hayes, UB4 8EJ

Scale Bar

1:100 @ A2  
0 1 2 3 4 5 6 7 8 9 10 Metres



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Drg. No. 24/3607/06  
Scale 1:100  
Date 25/01/24  
Drawn by KH

REVISION

drawer

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