



Existing Ground Floor Plan
Scale 1:100



Existing First Floor Plan
Scale 1:100

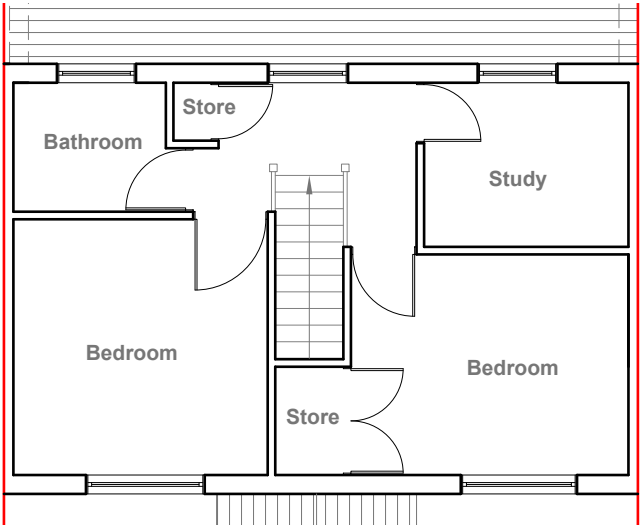


Existing Front Elevation
Scale 1:100

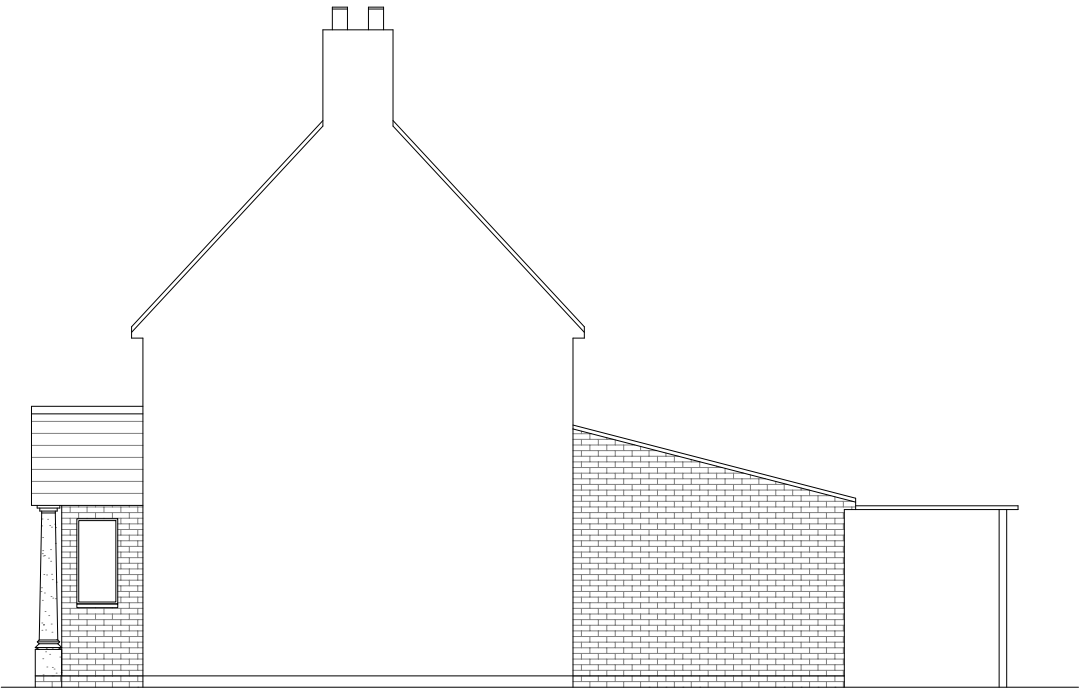

Existing Side Elevation
Scale 1:100



Existing Rear Elevation
Scale 1:100

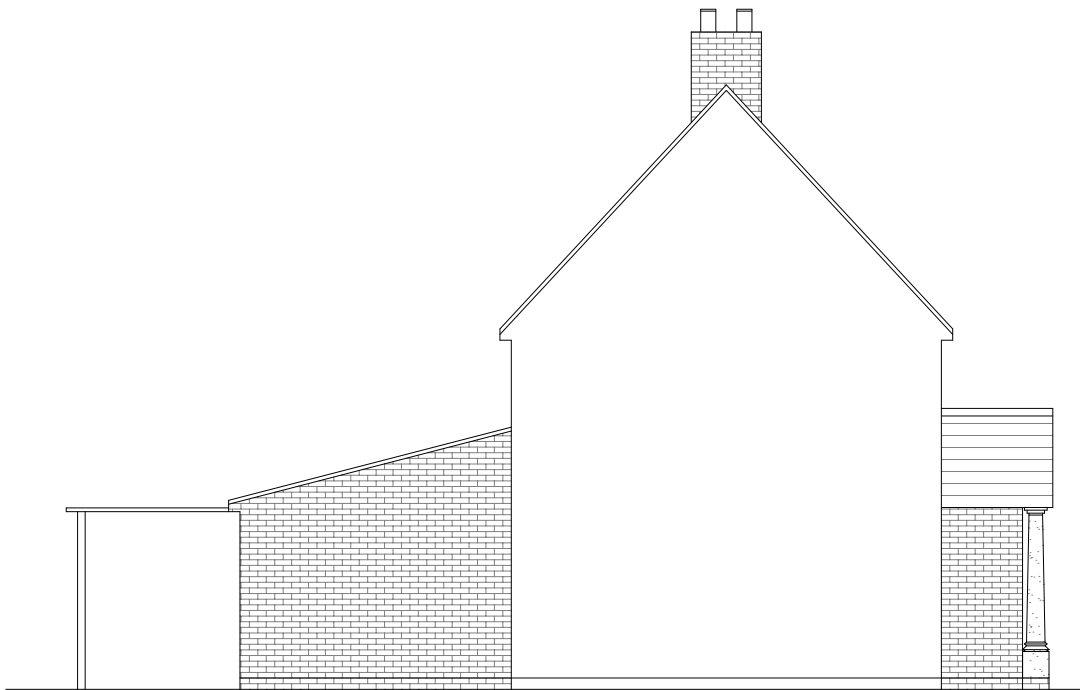

Existing Side Elevation
Scale 1:100



GENERAL NOTES:
1. ALL DIMENSIONS ARE IN MILLIMETER.
2. VERIFY ALL DIMENSIONS AND CONDITIONS BEFORE BUILDING OR STARTING CONSTRUCTION. NOTIFY THE DESIGNER IMMEDIATELY OF ANY DISCREPANCY OR VARIATION.
3. ALL WORK TO COMPLY WITH CURRENT BUILDING REGULATIONS AND CODES OF PRACTICE

Title:

Existing Ground Floor Plan & Elevations


Site Address
50 Kingsway,
Hayes,
UB3 2TY

Scale: 1:100 @A3
Date: 27/06/2022
Drawing No.: 2022/085 -01
Drawn By: RO


Revision Date:
e:mail -
faluckpatel@yahoo.com
(M) +44 (0) 7871 466 254



Velux Window to be installed as per manufacturer specification, not projected more than 150mm from the plane of roof slope
Provide 2m headheight between two Staircases

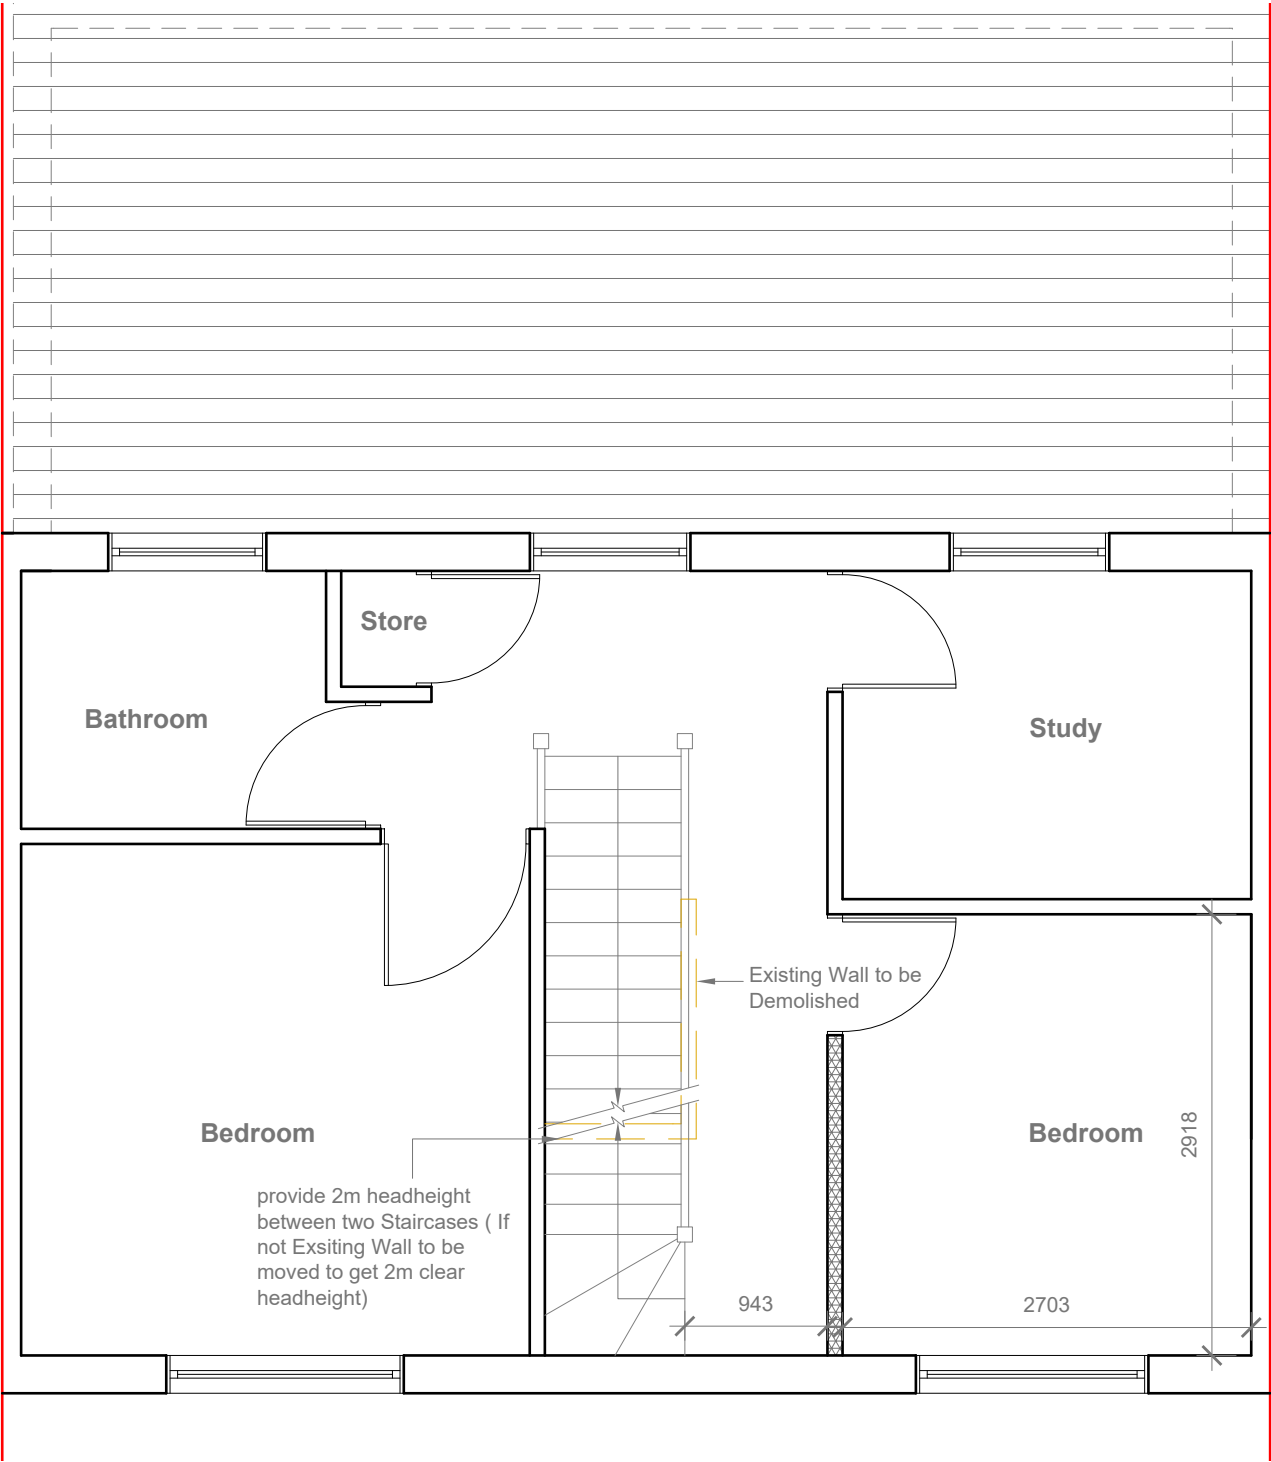

Proposed First Floor Plan
Scale 1:50

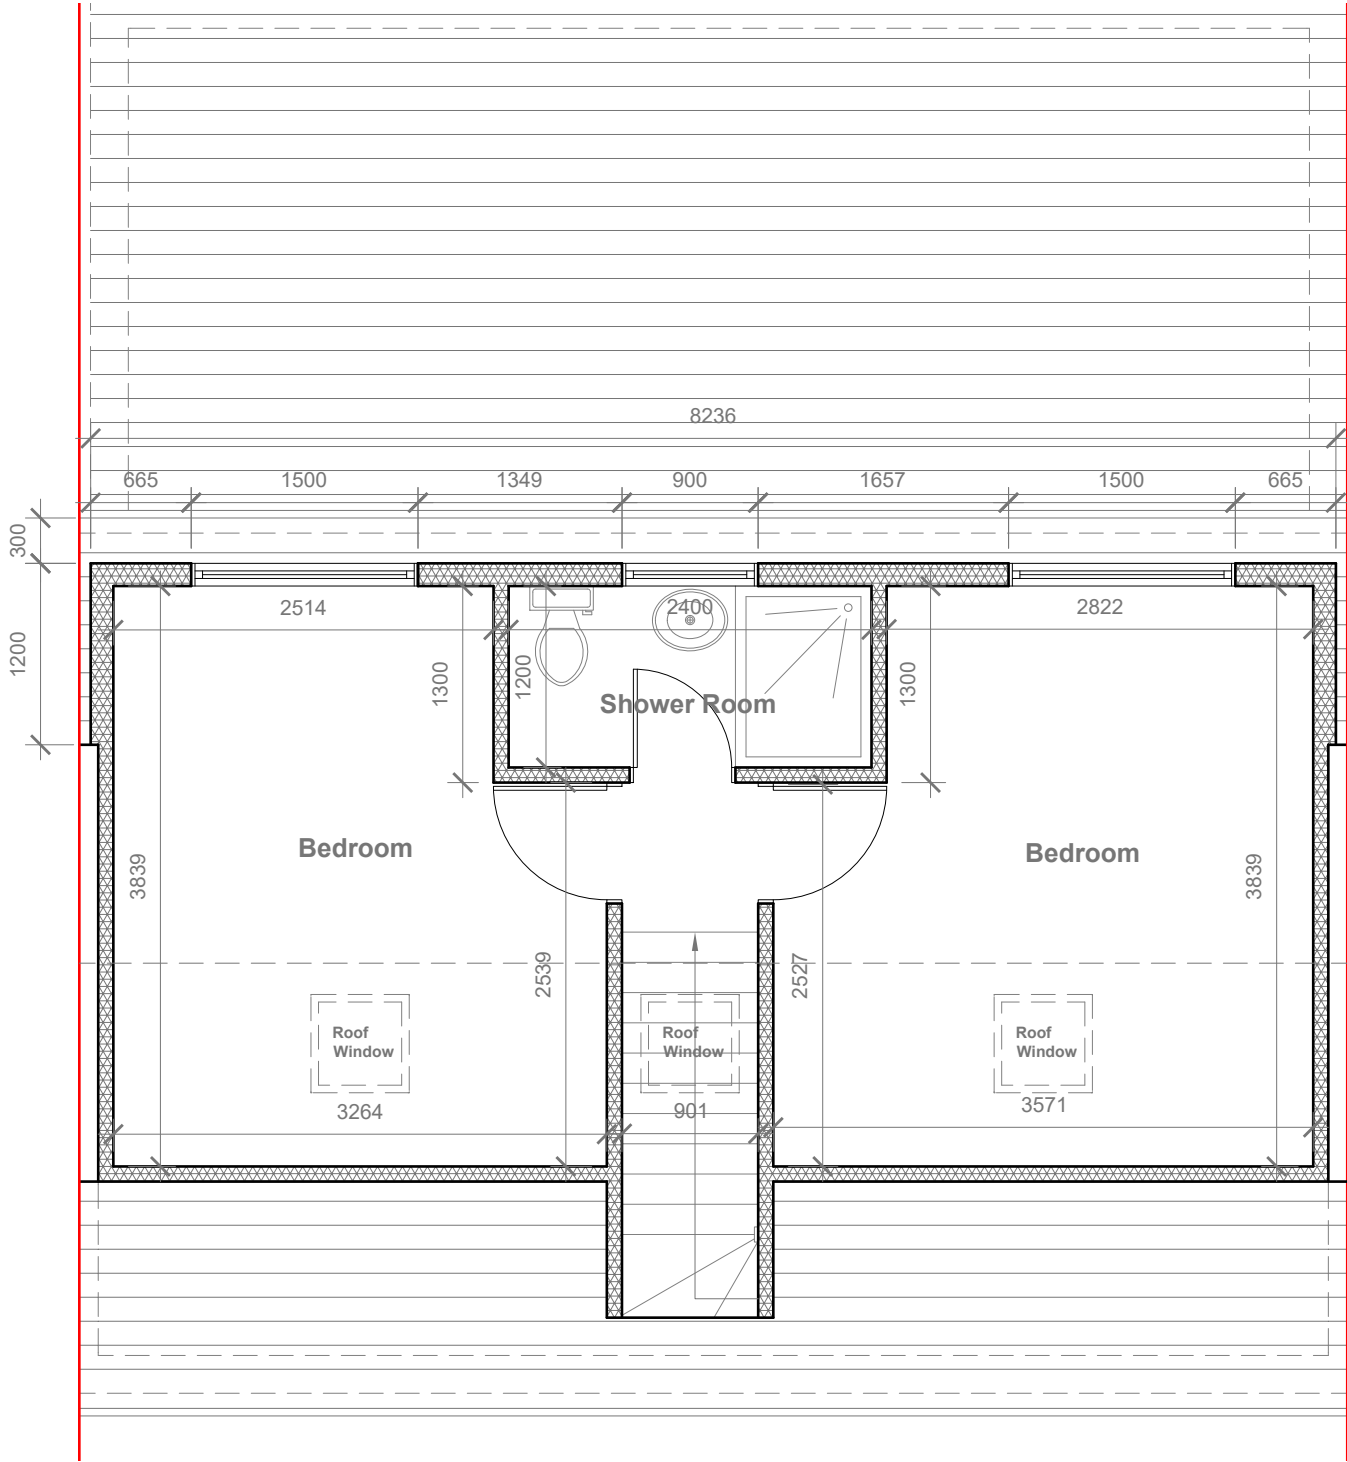

Proposed Loft Floor Plan
Scale 1:50



GENERAL NOTES:
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3. ALL WORK TO COMPLY WITH CURRENT BUILDING REGULATIONS AND CODES OF PRACTICE

Title:

Proposed First Floor & Loft Plans

Site Address
50 Kingsway,
Hayes,
UB3 2TY

Scale: 1:50 @A3
Date: 27/06/2022
Drawing No.: 2022/085 -02
Drawn By: RO


Revision Date:
e:mail - faluckpatel@yahoo.com
(M) +44 (0) 7871 466 254



Proposed External Finish
Materials to Match Existing
External Finish Materials



Velux Window to be installed
as per manufacturer
specification, not projected
more than 150mm from the
plane of roof slope

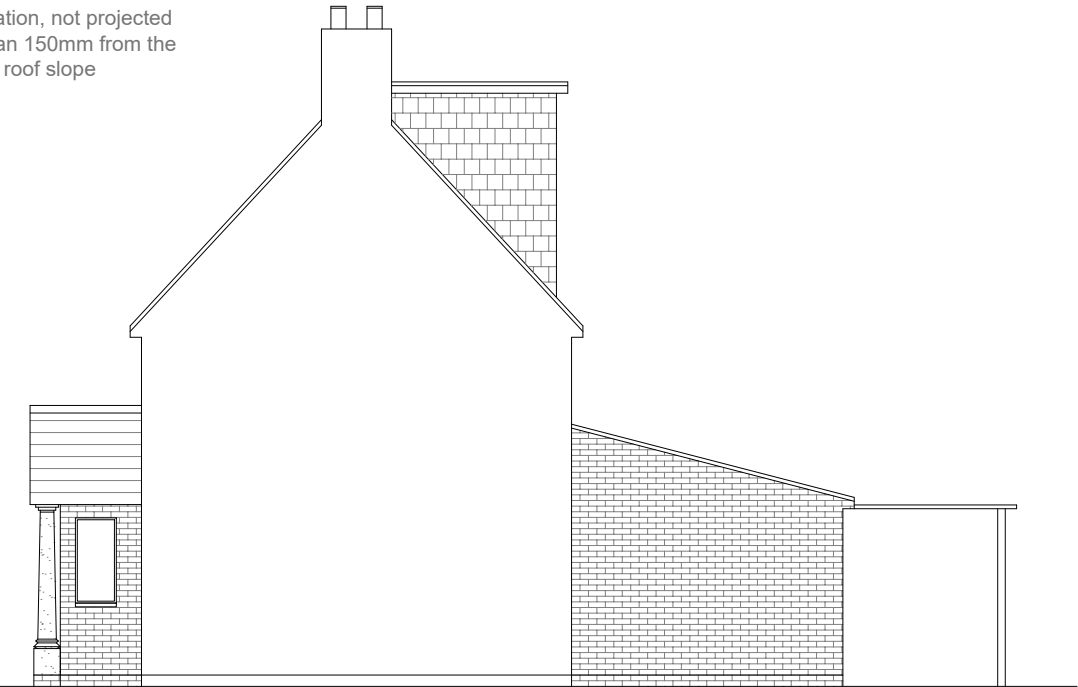

REAR DORMER VOLUME = $W \times H \times L / 2$
 $8.236 \times 2.851 \times 2.795 / 2$
 $65.62 / 2$
 32.81 CU.MT.

V =


TOTAL ROOF VOLUME = V
 32.81
 $32.81 \text{ CU.MT.} < 40.00 \text{ CU.MT}$

Proposed Front Elevation
Scale 1:100

Proposed Side Elevation
Scale 1:100



Proposed Rear Elevation
Scale 1:100

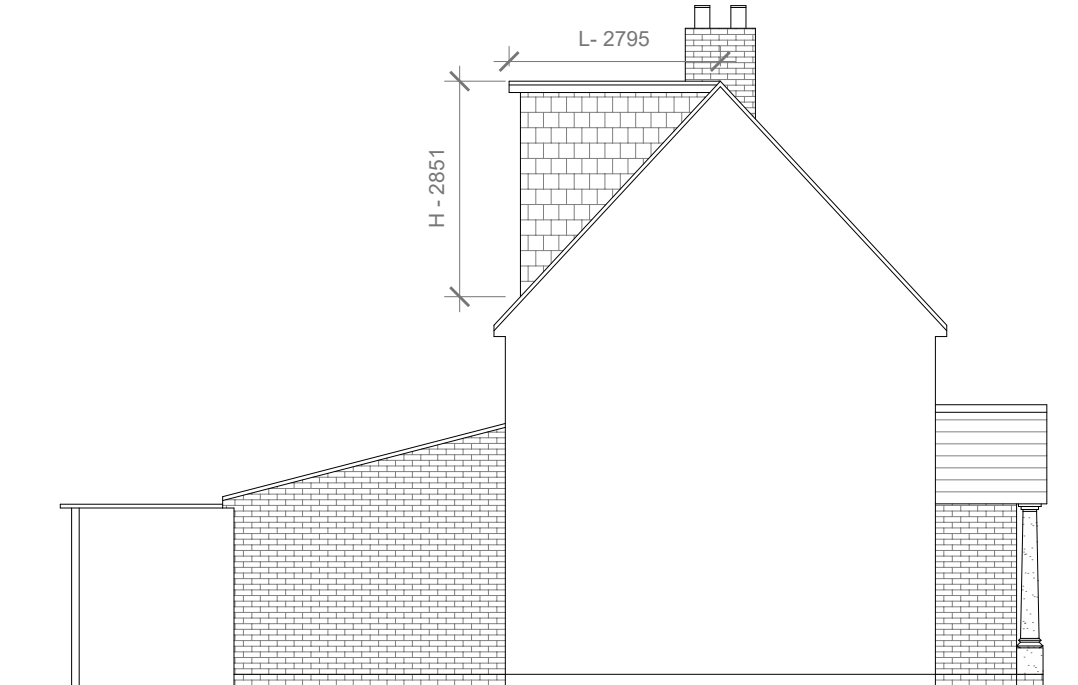

Proposed Side Elevation
Scale 1:100



GENERAL NOTES:
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3. ALL WORK TO COMPLY WITH CURRENT BUILDING REGULATIONS
AND CODES OF PRACTICE

Title:

Proposed Elevations

Site Address	Scale: 1:100 @A3	Revision Date:
50 Kingsway, Hayes, UB3 2TY	Date: 27/06/2022	
	Drawing No.: 2022/085 -03	
	Drawn By: RO	e:mail - faluckpatel@yahoo.com (M) +44 (0) 7871 466 254

