


Existing Ground Floor Plan

Scale 1:100

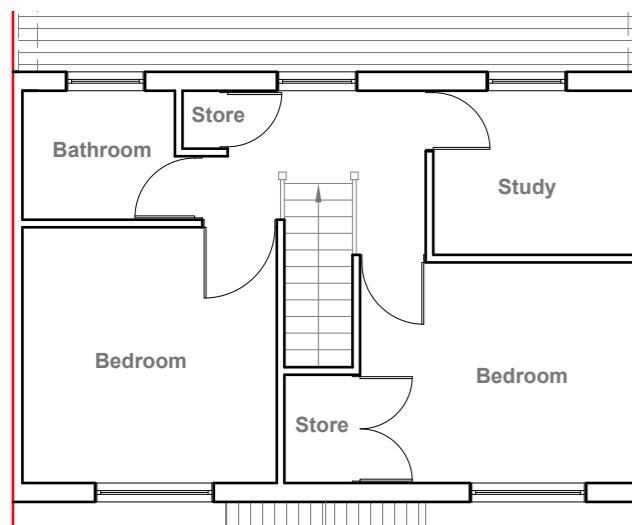

Existing First Floor Plan

Scale 1:100

GENERAL NOTES:
 1. ALL DIMENSIONS ARE IN MILLIMETER.
 2. VERIFY ALL DIMENSIONS AND CONDITIONS BEFORE BUILDING OR
 STARTING CONSTRUCTION. NOTIFY THE DESIGNER IMMEDIATELY OF ANY
 DISCREPANCY OR VARIATION.
 3. ALL WORK TO COMPLY WITH CURRENT BUILDING REGULATIONS
 AND CODES OF PRACTICE


Title:

Existing Ground Floor Plan & Elevations



Existing Front Elevation

Scale 1:100

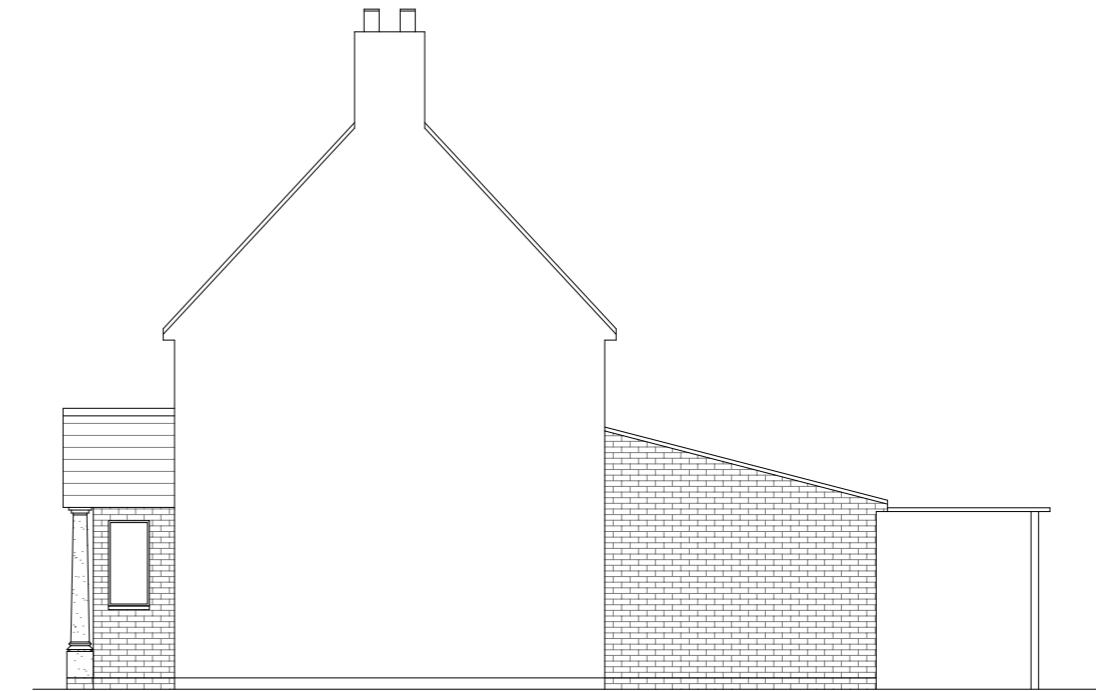


Existing Side Elevation

Scale 1:100



Existing Rear Elevation

Scale 1:100


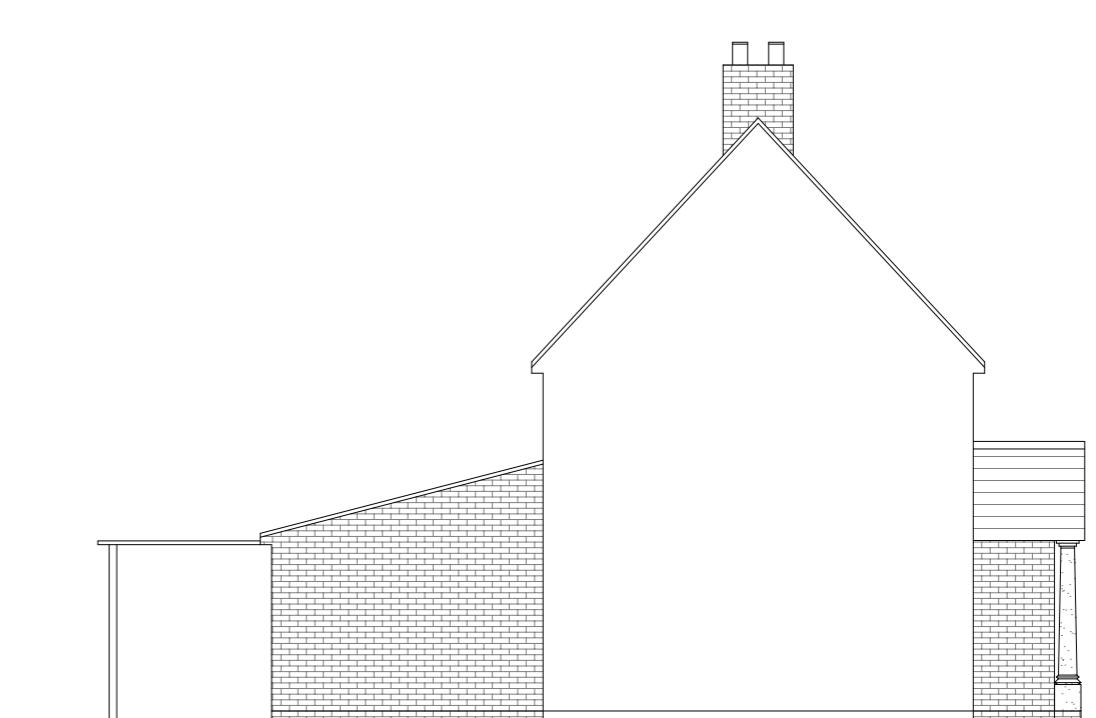


Existing Side Elevation

Scale 1:100

10 Meter
5
2
1
0
1:100

Velux Window to be installed as per manufacturer specification, not projected more than 150mm from the plane of roof slope
Provide 2m headheight between two Staircases

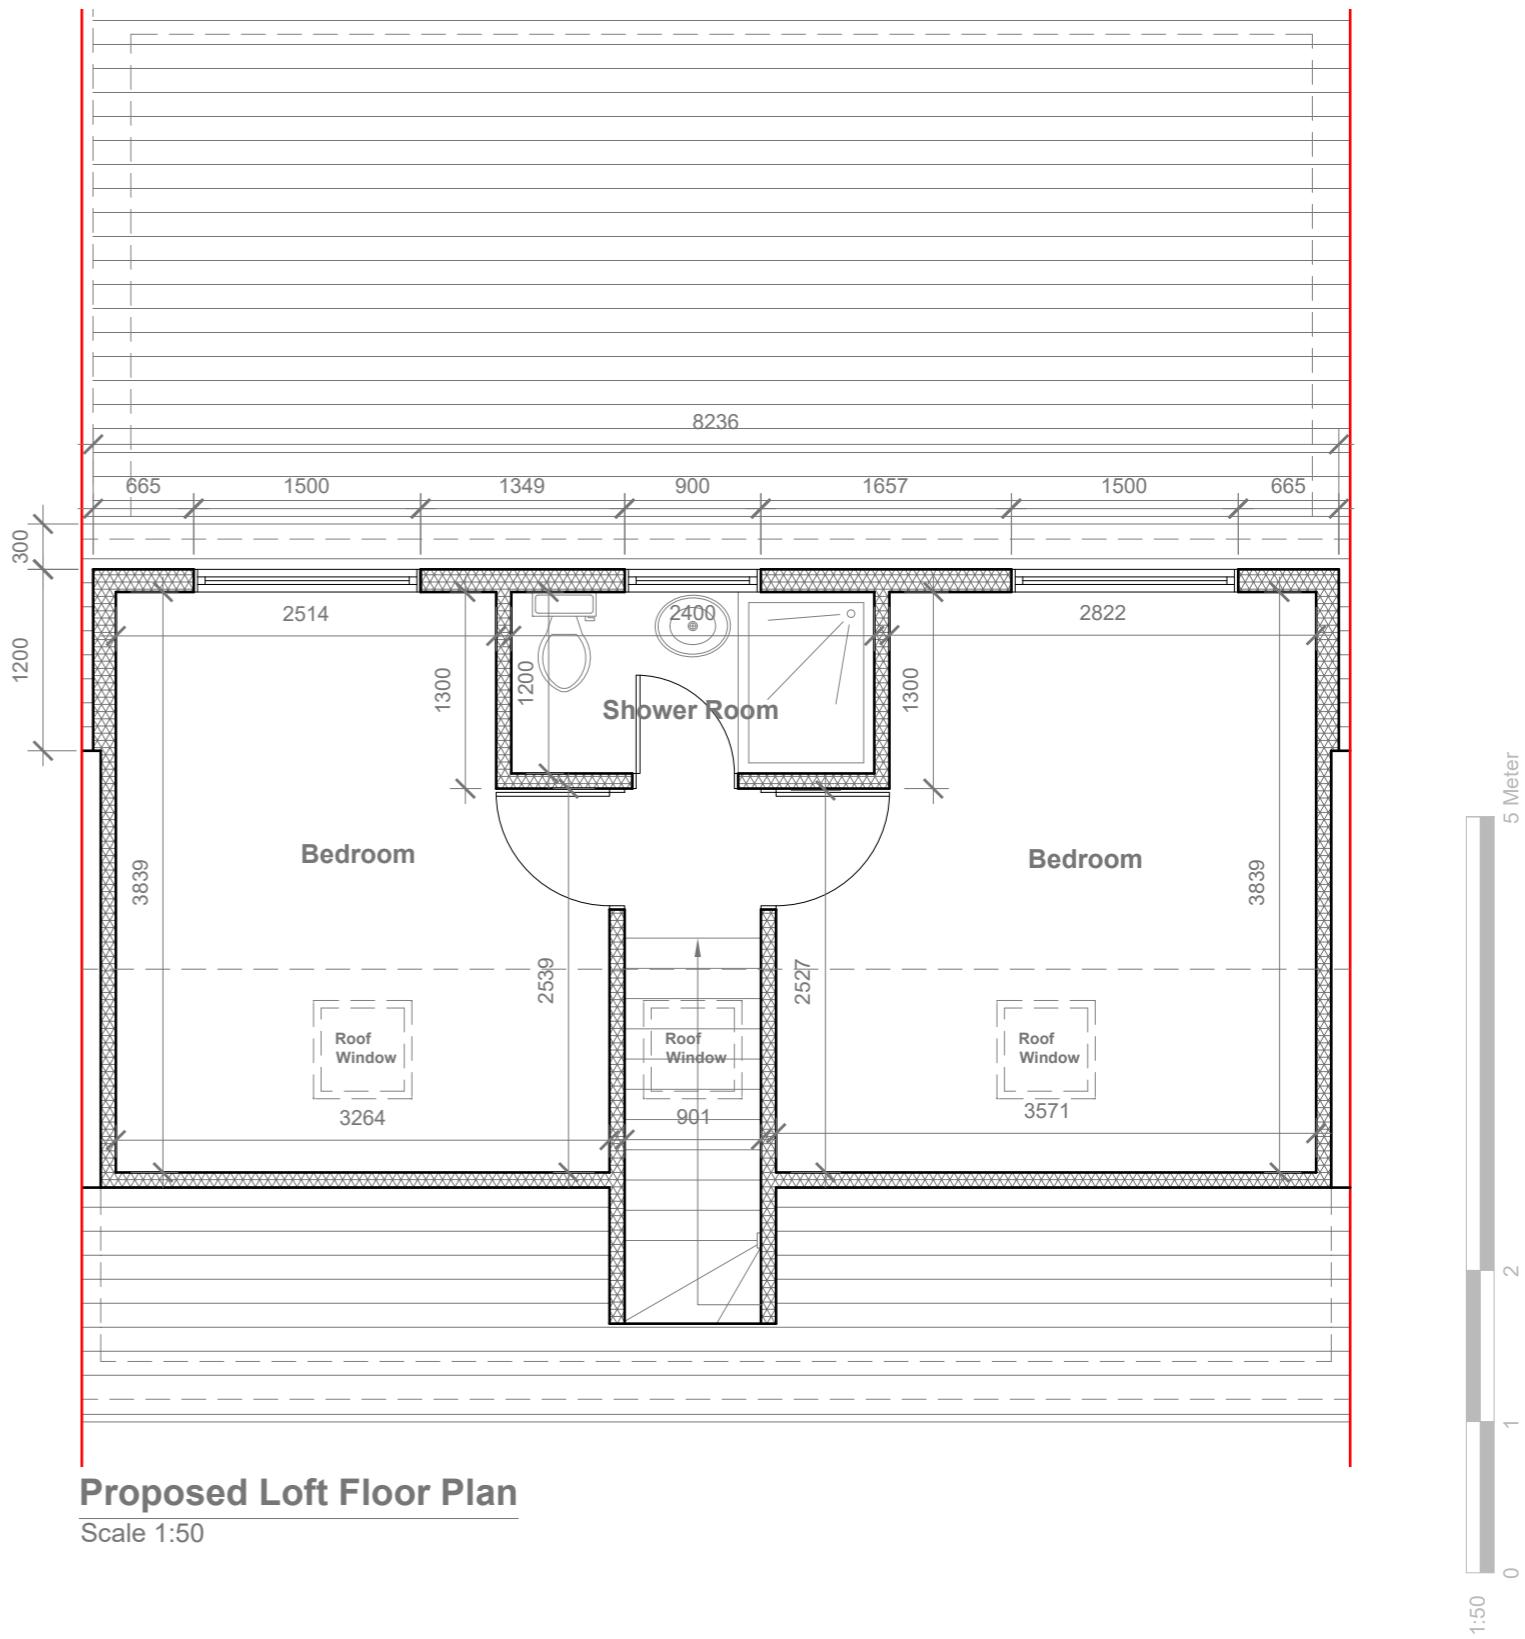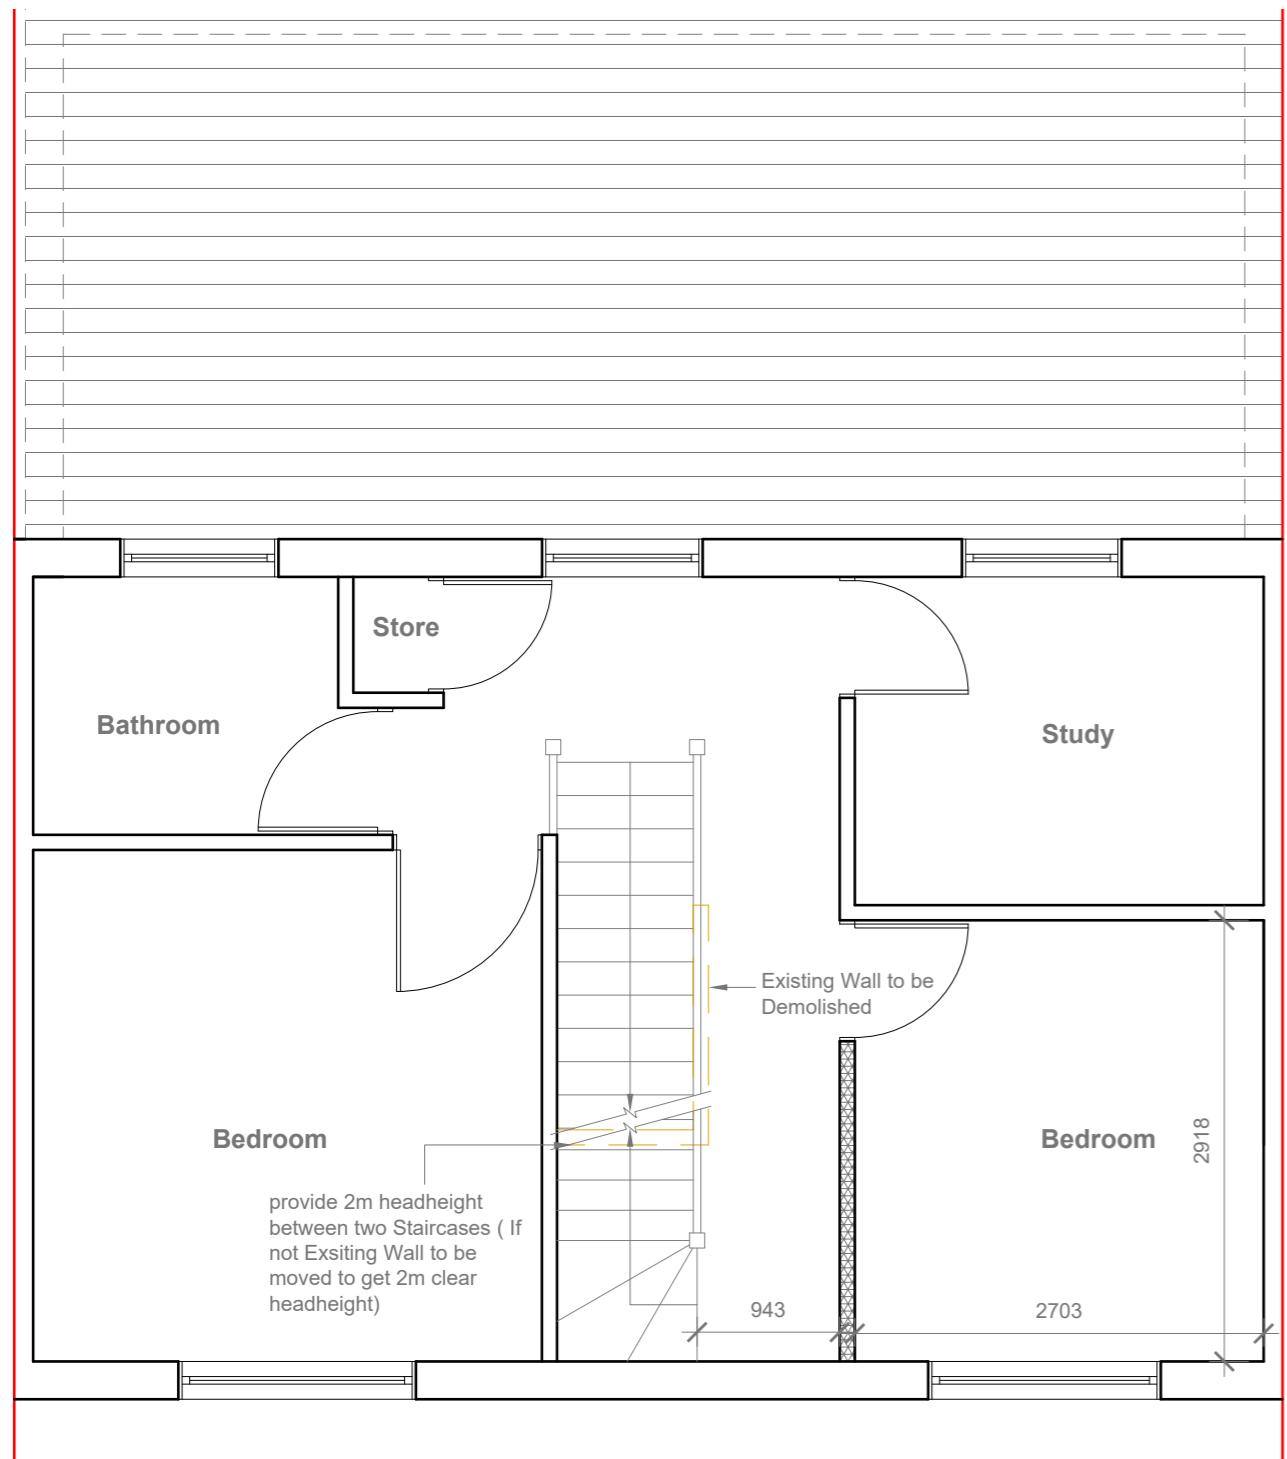


Proposed First Floor & Loft Plans



Proposed Front Elevation

Scale 1:100

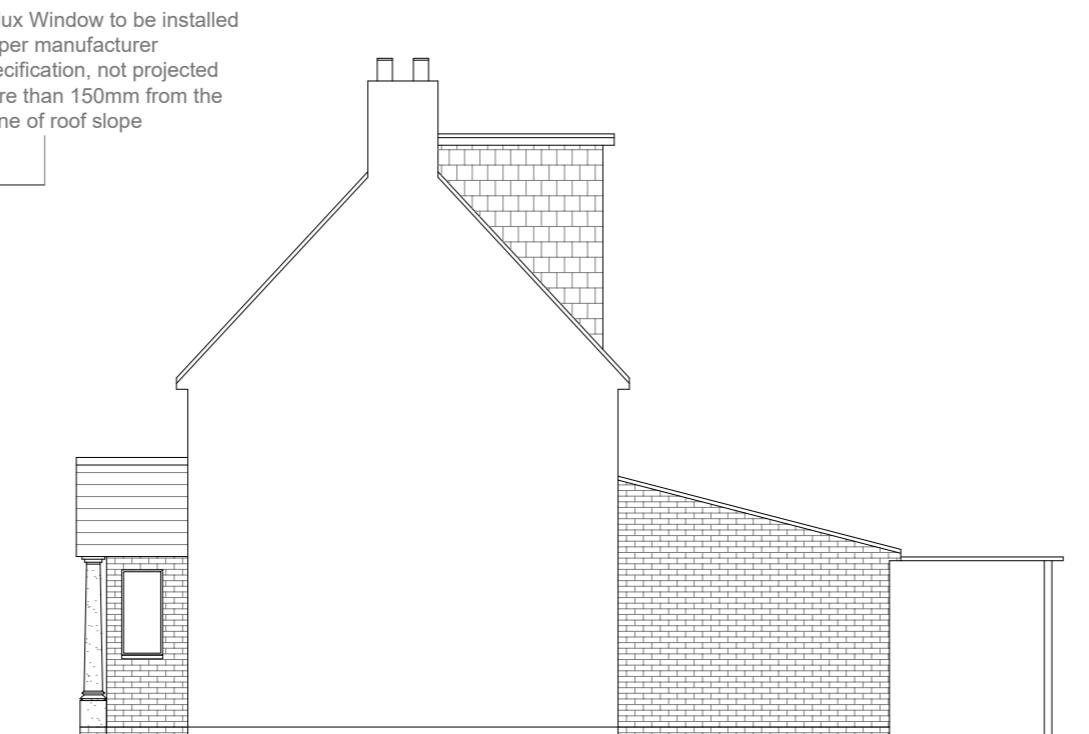


Proposed Side Elevation

Scale 1:100



Proposed Rear Elevation

Scale 1:100

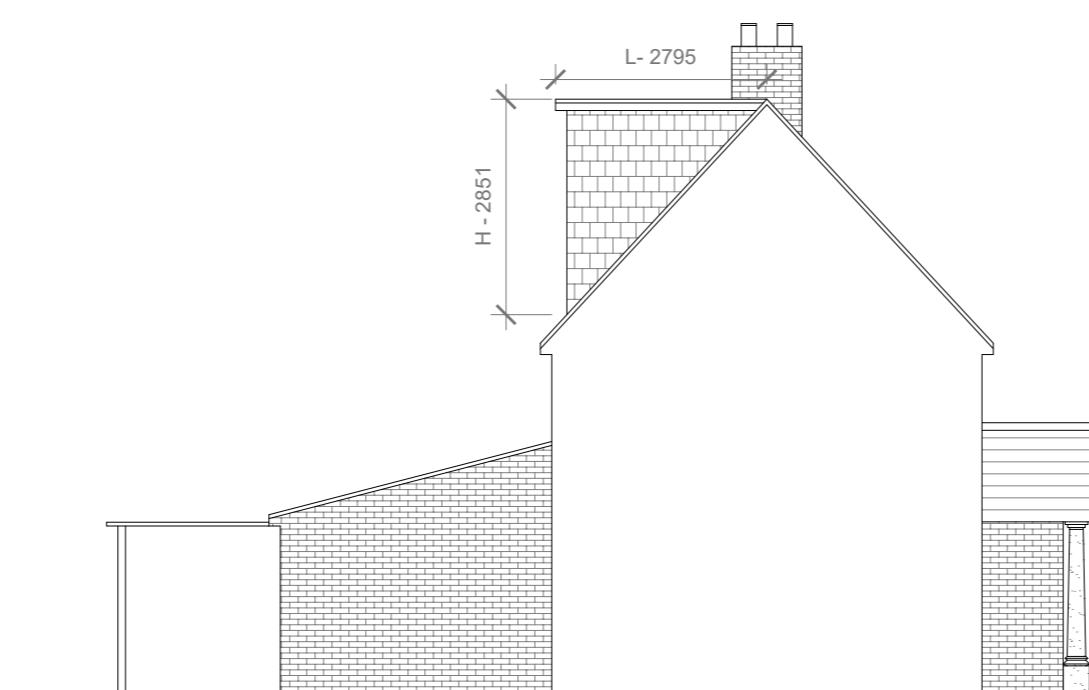

Proposed Side Elevation

Scale 1:100

Proposed External Finish
Materials to Match Existing
External Finish Materials

$$\text{REAR DORMER VOLUME} = \frac{W \times H \times L}{2}$$

$$8.236 \times 2.851 \times 2.795 / 2$$

$$65.62 / 2$$

$$32.81 \text{ CU.MT.}$$

$$\text{TOTAL ROOF VOLUME} = V$$

$$32.81$$

$$32.81 \text{ CU.MT.} < 40.00 \text{ CU.MT}$$

10 Meter
5
2
1
0
1:100

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AND CODES OF PRACTICE

Title:

Proposed Elevations

Site Address
50 Kingsway,
Hayes,
UB3 2TY

Scale: 1:100 @A3
Date: 27/06/2022
Drawing No.: 2022/085 -03
Drawn By: RO

Revision Date:

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**Faluck
Patel**