



Existing Ground Floor Plan  
Scale 1:100



Existing First Floor Plan  
Scale 1:100

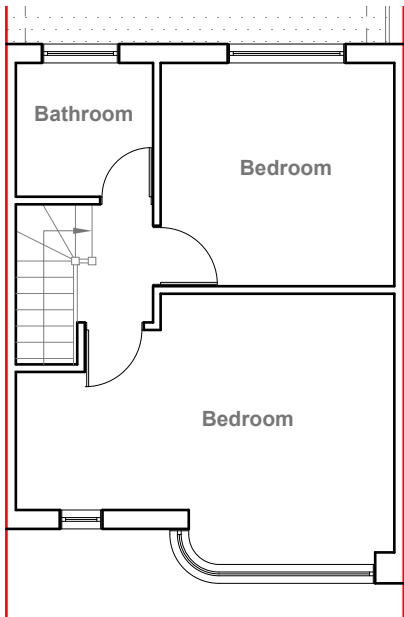


Existing Front Elevation  
Scale 1:100

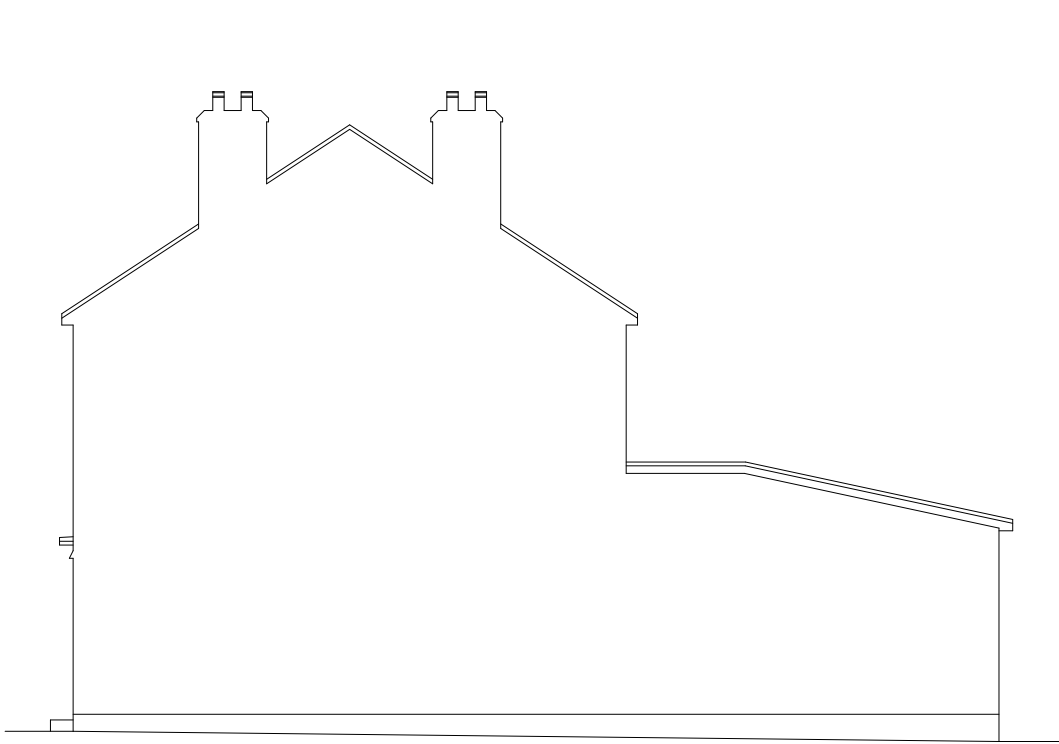

Existing Side Elevation  
Scale 1:100



Existing Rear Elevation  
Scale 1:100

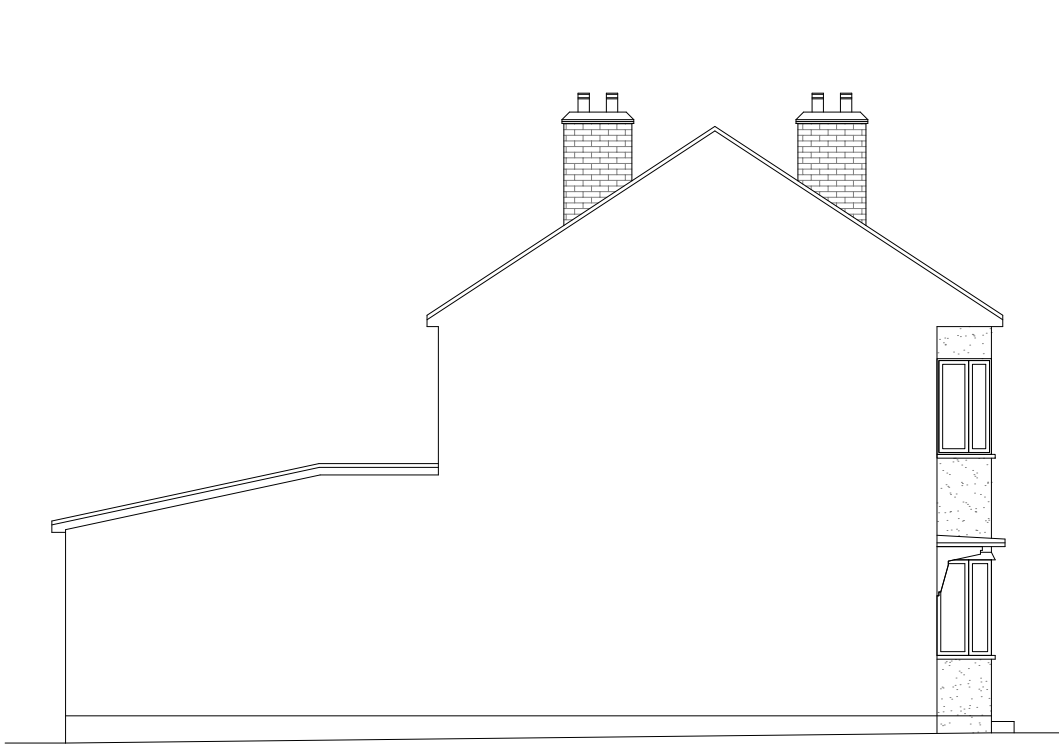

Existing Side Elevation  
Scale 1:100




GENERAL NOTES:  
1. ALL DIMENSIONS ARE IN MILLIMETER.  
2. VERIFY ALL DIMENSIONS AND CONDITIONS BEFORE BUILDING OR STARTING CONSTRUCTION. NOTIFY THE DESIGNER IMMEDIATELY OF ANY DISCREPANCY OR VARIATION.  
3. ALL WORK TO COMPLY WITH CURRENT BUILDING REGULATIONS AND CODES OF PRACTICE

Title:


Existing Floor Plans & Elevations

Site Address	Scale: 1:100 @A3	Revision Date:
36 Cottingham Chase, Ruislip Manor, HA4 0BZ	Date: 25/08/2023	
	Drawing No.: 2023/115 -01	
	Drawn By: RO	e:mail - faluckpatel@yahoo.com (M) +44 (0) 7871 466 254



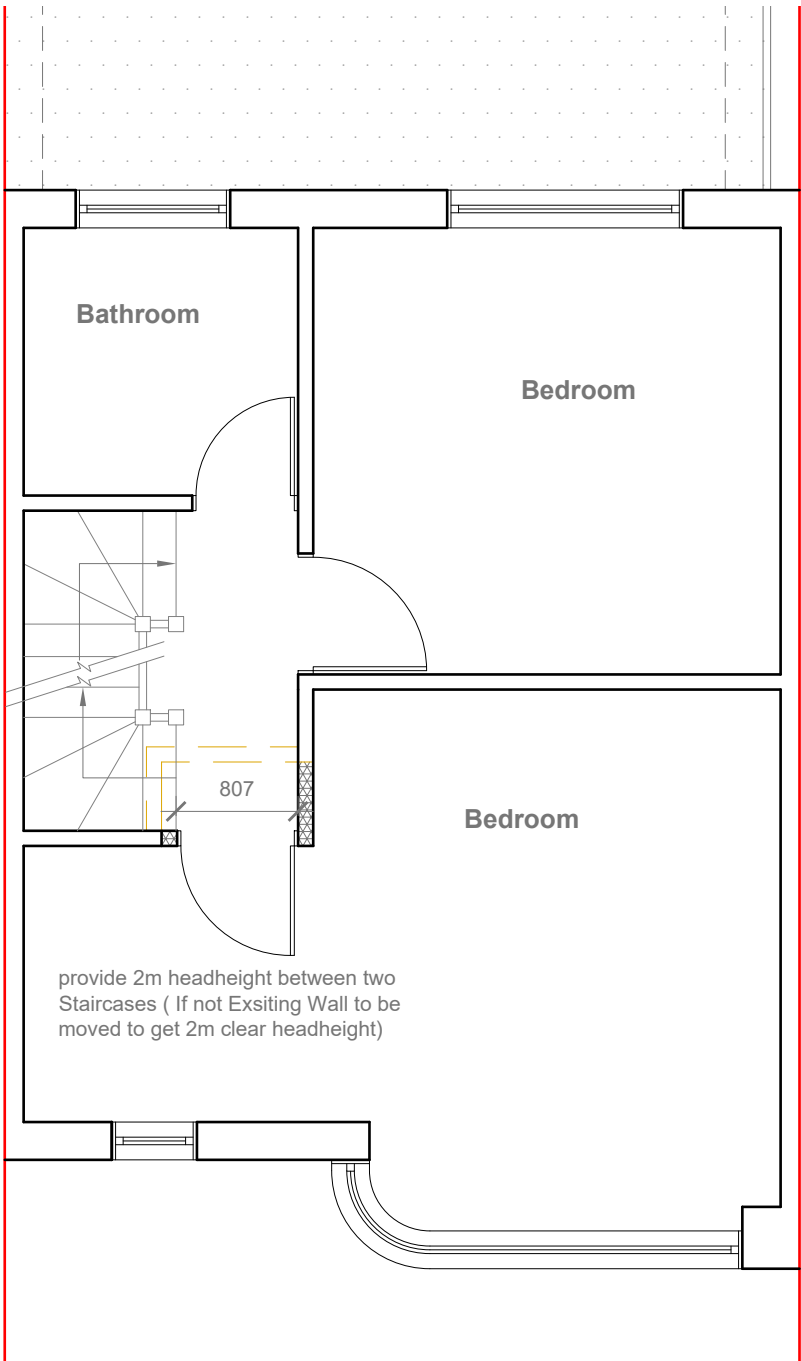

**Proposed First Floor Plan**  
Scale 1:50

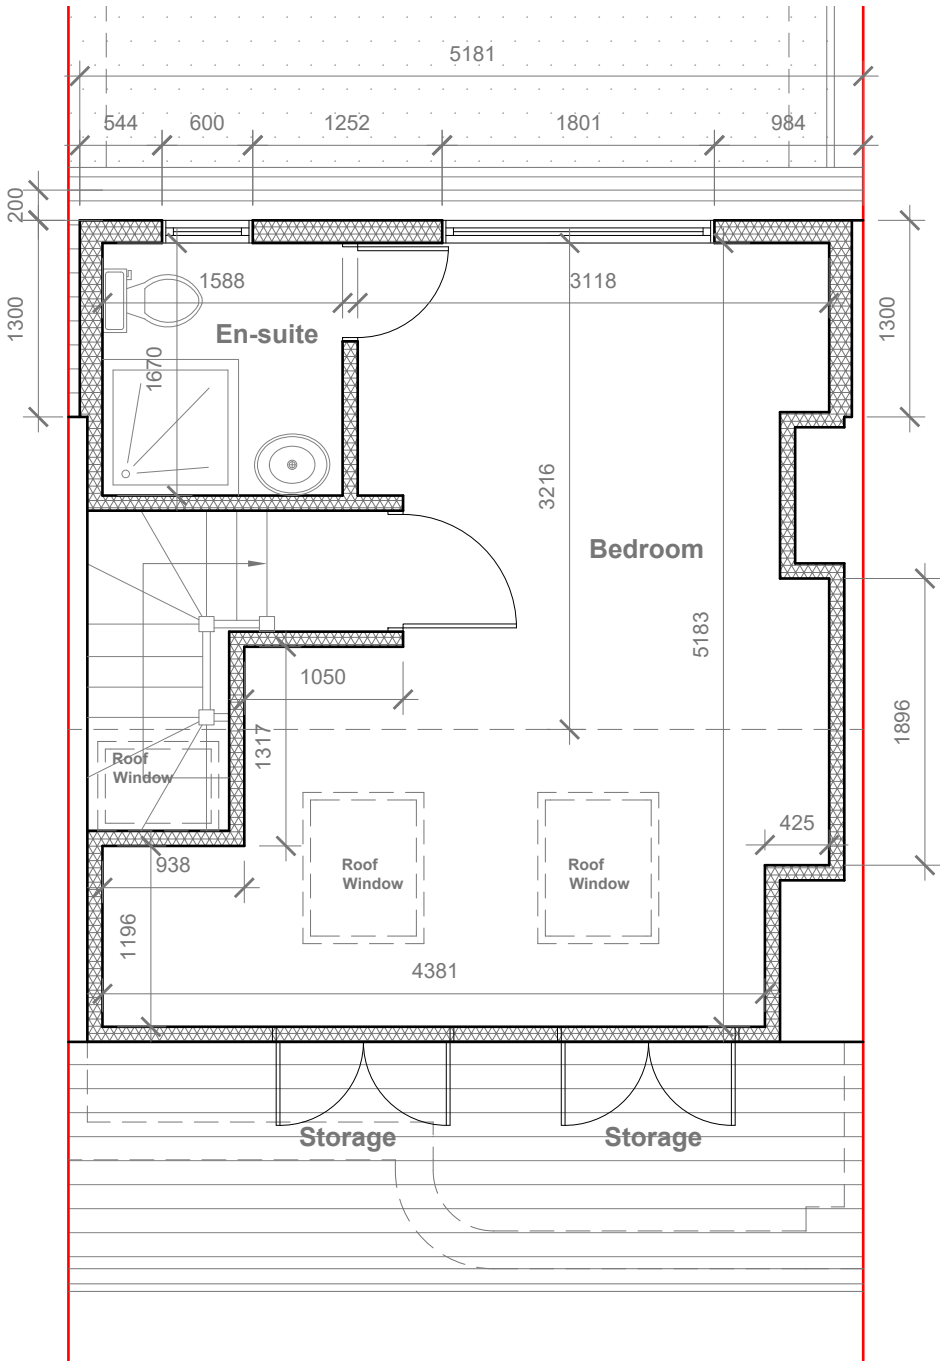

**Proposed Loft Floor Plan**  
Scale 1:50

Velux Window to be installed  
as per manufacturer  
specification, not projected  
more than 150mm from the  
plane of roof slope



GENERAL NOTES:  
1. ALL DIMENSIONS ARE IN MILLIMETER.  
2. VERIFY ALL DIMENSIONS AND CONDITIONS BEFORE BUILDING OR STARTING CONSTRUCTION. NOTIFY THE DESIGNER IMMEDIATELY OF ANY DISCREPANCY OR VARIATION.  
3. ALL WORK TO COMPLY WITH CURRENT BUILDING REGULATIONS AND CODES OF PRACTICE

Title:


Proposed First & Loft Floor Plans

Site Address  
36 Cottingham  
Chase,  
Ruislip Manor,  
HA4 0BZ

Scale: 1:50 @A3  
Date: 25/08/2023  
Drawing No.: 2023/115 -02  
Drawn By: RO


Revision Date:  
e:mail -  
faluckpatel@yahoo.com  
(M) +44 (0) 7871 466 254



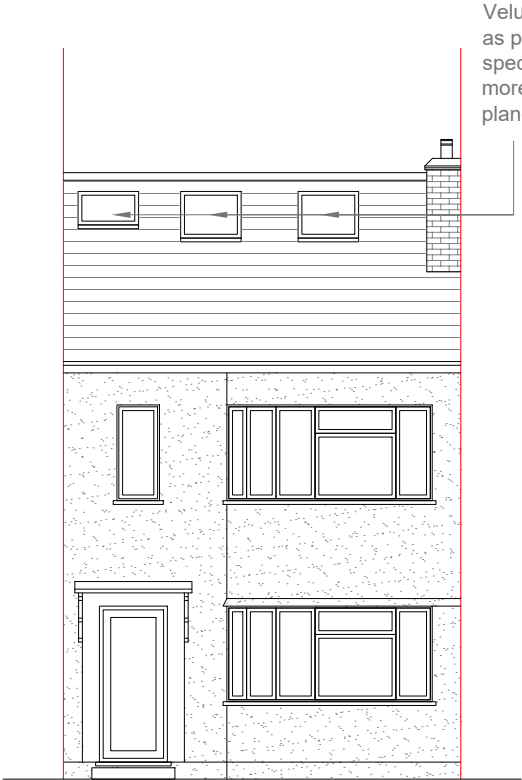


Proposed Front Elevation  
Scale 1:100


Velux Window to be installed as per manufacturer specification, not projected more than 150mm from the plane of roof slope

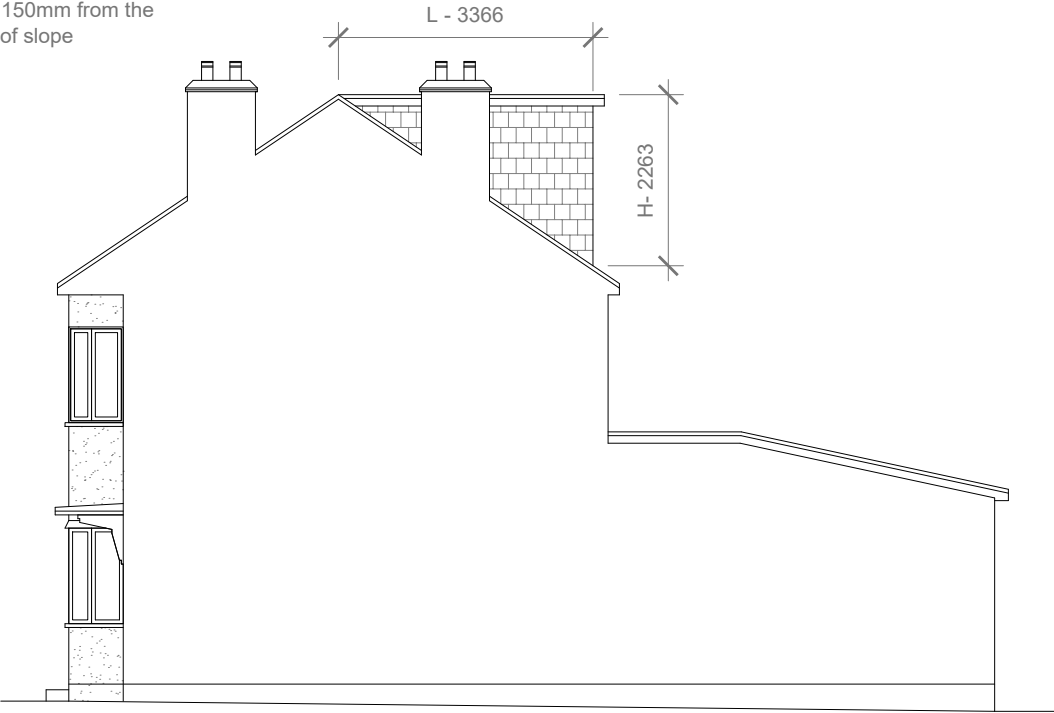

Proposed Front Elevation  
Scale 1:100

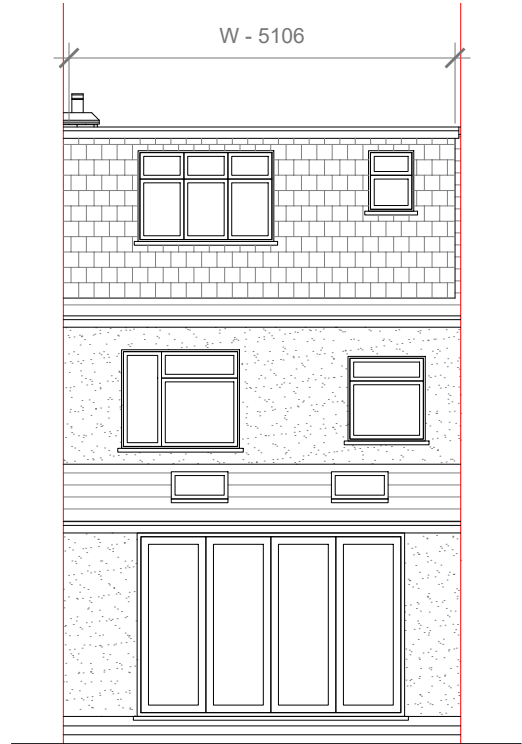

Proposed Front Elevation  
Scale 1:100

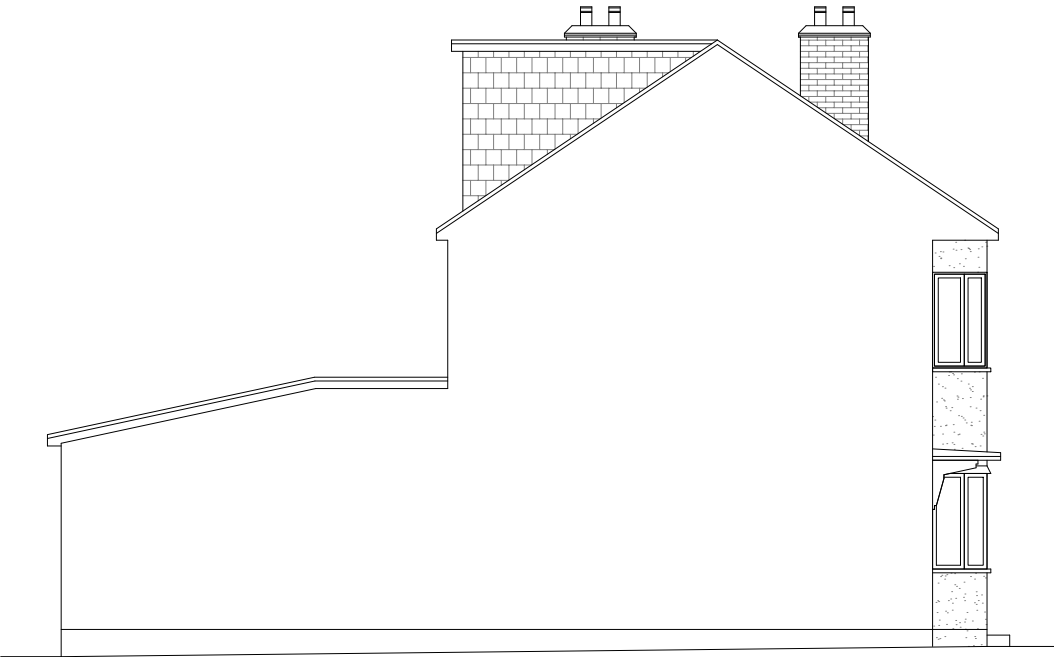

Proposed Front Elevation  
Scale 1:100

REAR DORMER VOLUME =  $W \times H \times L / 2$   
 $5.106 \times 2.263 \times 3.366 / 2$   
 $38.89 / 2$   
 $V1 = 19.44 \text{ CU.MT.}$

TOTAL ROOF VOLUME =  $V1$   
 $19.44$   
 $19.44 \text{ CU.MT.} < 40.00 \text{ CU.MT}$



GENERAL NOTES:  
1. ALL DIMENSIONS ARE IN MILLIMETER.  
2. VERIFY ALL DIMENSIONS AND CONDITIONS BEFORE BUILDING OR STARTING CONSTRUCTION. NOTIFY THE DESIGNER IMMEDIATELY OF ANY DISCREPANCY OR VARIATION.  
3. ALL WORK TO COMPLY WITH CURRENT BUILDING REGULATIONS AND CODES OF PRACTICE

Title:  
  
Proposed Elevations

Site Address	Scale: 1:100 @A3	Revision Date:
36 Cottingham Chase, Ruislip Manor, HA4 0BZ	Date: 25/08/2023	
	Drawing No.: 2023/115 -03	
	Drawn By: RO	e:mail - faluckpatel@yahoo.com (M) +44 (0) 7871 466 254

