

V - Design


Company: V-Design CAD Services Ltd
Website: www.vdesigncad.co.uk
Email Address: info@vdesigncad.co.uk
Tel : +44 20 3488 4890
Mobile: +44 7312015617

IMPORTANT NOTES:

Dimensions to be verified on site
DO NOT SCALE FROM THIS DRAWING.
Any areas indicated on this drawing are for guidance only.
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ADDRESS: 84, Adelphi Crescent, Hayes, UB4 8NA



LEGENDS:

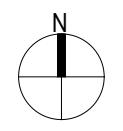EXISTING:	PROPOSED:
Existing Wall	Cavity Wall
Internal Wall	Internal Wall
Site Boundary	Site Boundary
Windows	Windows
Doors	Doors

Drawing Title: Block & Location Plans
Scale: 1:500, 1:1250 Paper Size: A3

REVISION/ COMMENTS :		
No:	Comments:	Date:


Drawn By: VP
Job Ref: 24137
Date: Nov 2024
Drawing No. LW - 04




Block Plan

0 5 10 15 20 25
metres 1:500 scale




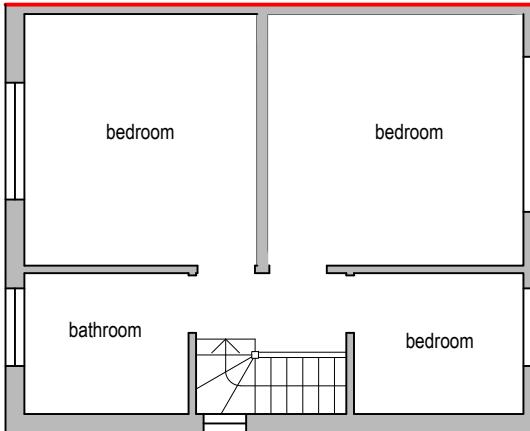


metres 1:100 scale

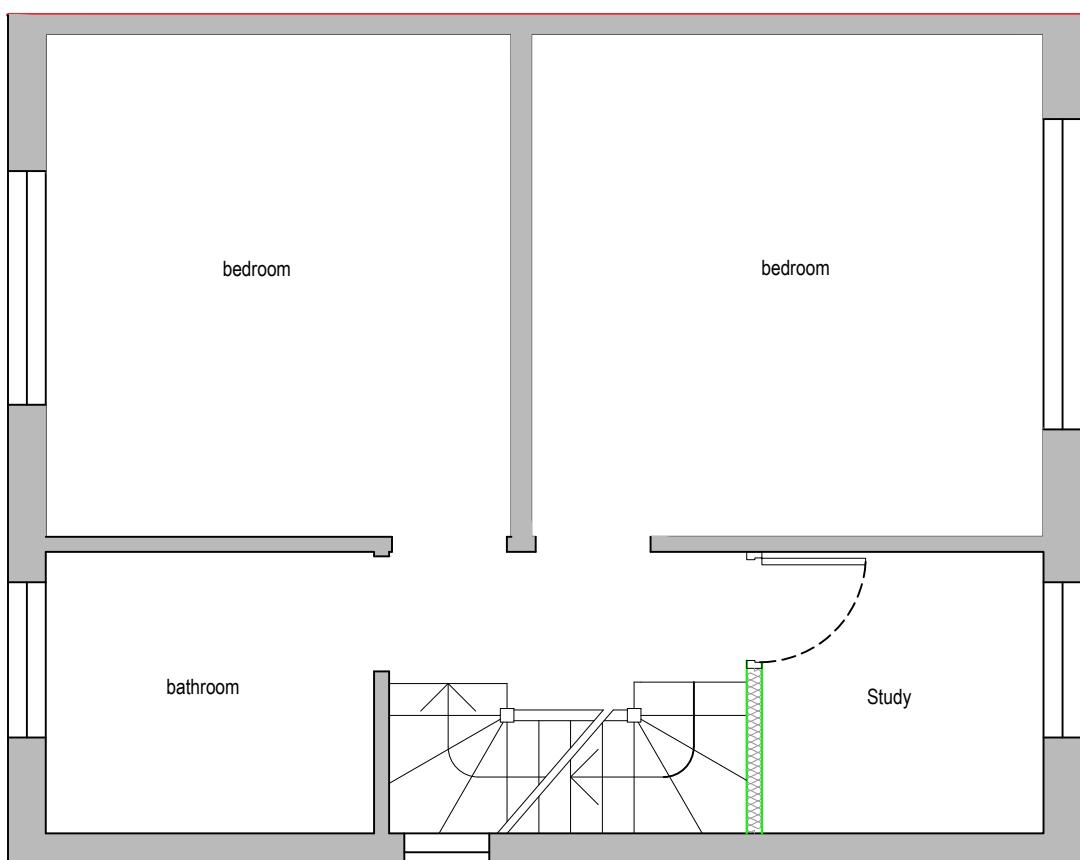

metres 1:50 scale

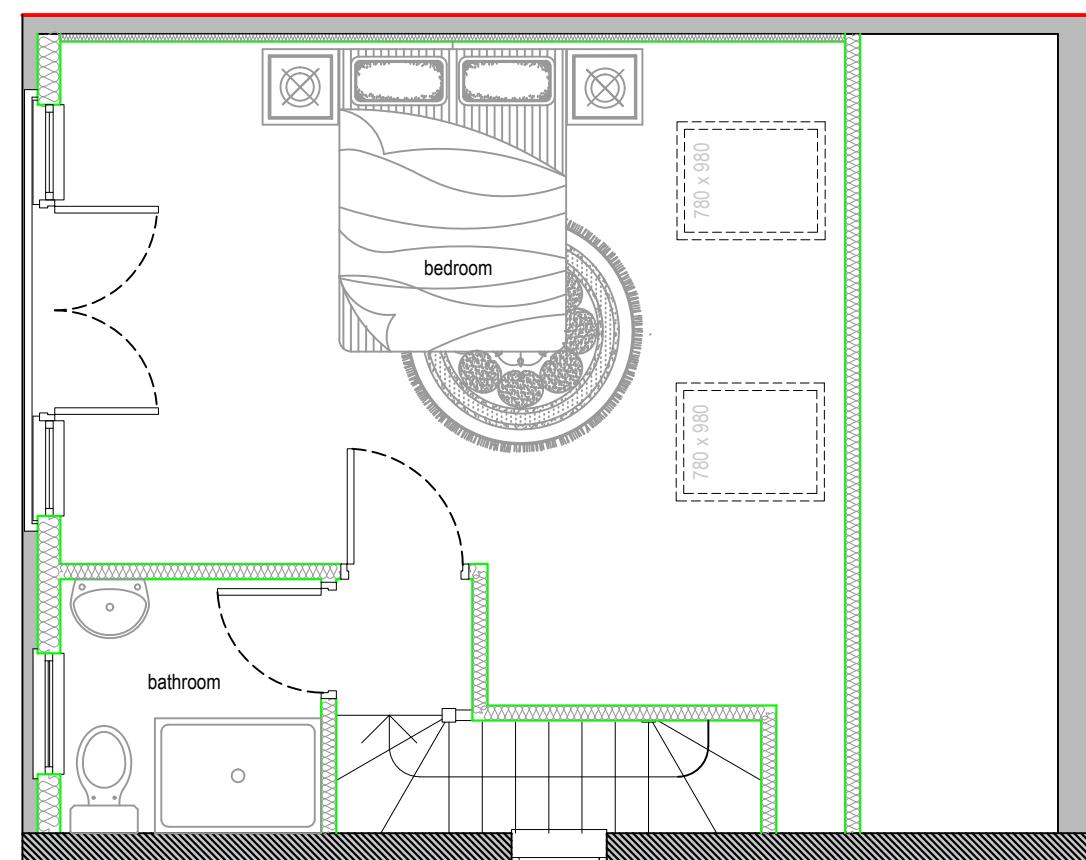

metres 1:50 scale

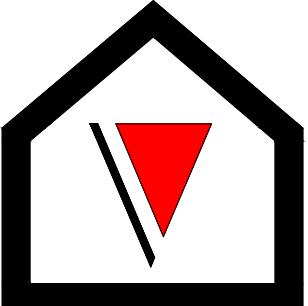

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LEGENDS:


EXISTING:	PROPOSED:
Existing Wall	Cavity Wall
Internal Wall	Internal Wall
Site Boundary	Site Boundary
Windows	Windows
Doors	Doors

Drawing Title:
Existing First Floor, Proposed First & Loft Floor Plans

Scale: 1:50, 1:100 Paper Size: A3

REVISION/ COMMENTS :		
No:	Comments:	Date:

Drawn By: VP
Job Ref: 24137
Date: Nov 2024
Drawing No. LW - 01

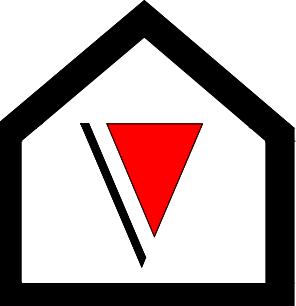

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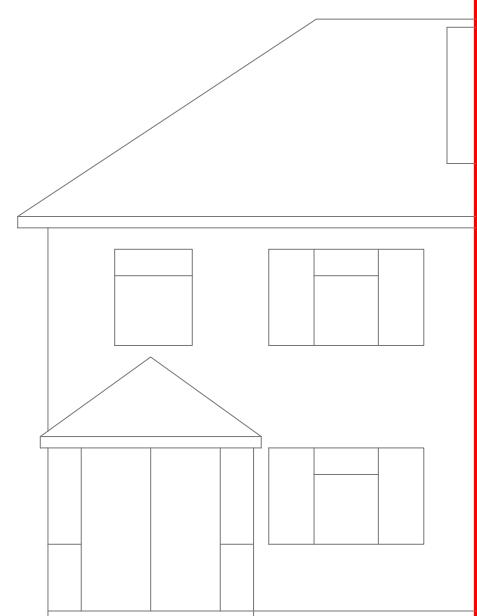
LEGENDS:

EXISTING:	PROPOSED:
Existing Wall	Cavity Wall
Internal Wall	Internal Wall
Site Boundary	Site Boundary
Windows	Windows
Doors	Doors

Drawing Title:
Existing Elevations
Scale: 1:100 Paper Size: A3


REVISION/ COMMENTS :		
No:	Comments:	Date:

Drawn By: VP
Job Ref: 24137
Date: Nov 2024
Drawing No. LW - 02




Existing Front Elevation

0 1 2 3 4 5
metres 1:100 scale

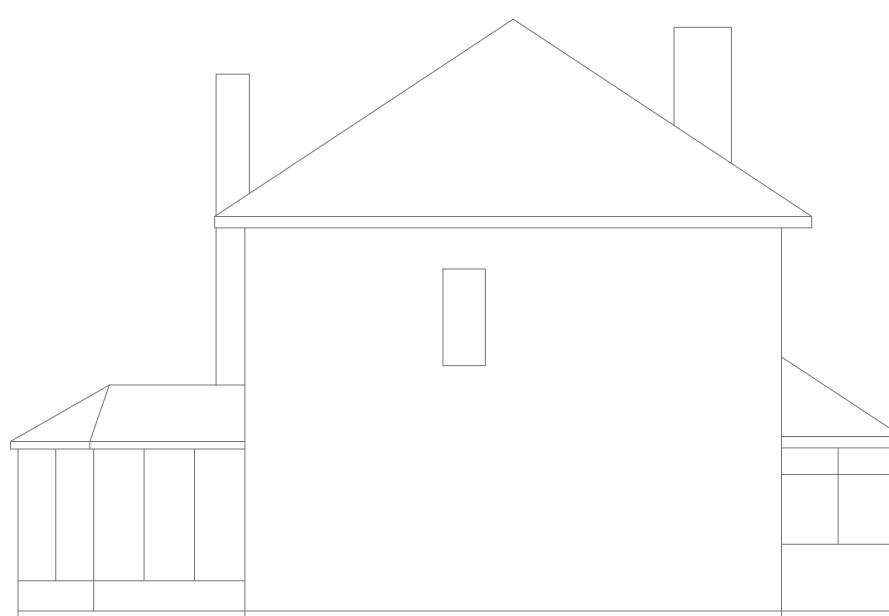

Existing Side Elevation

0 1 2 3 4 5
metres 1:100 scale

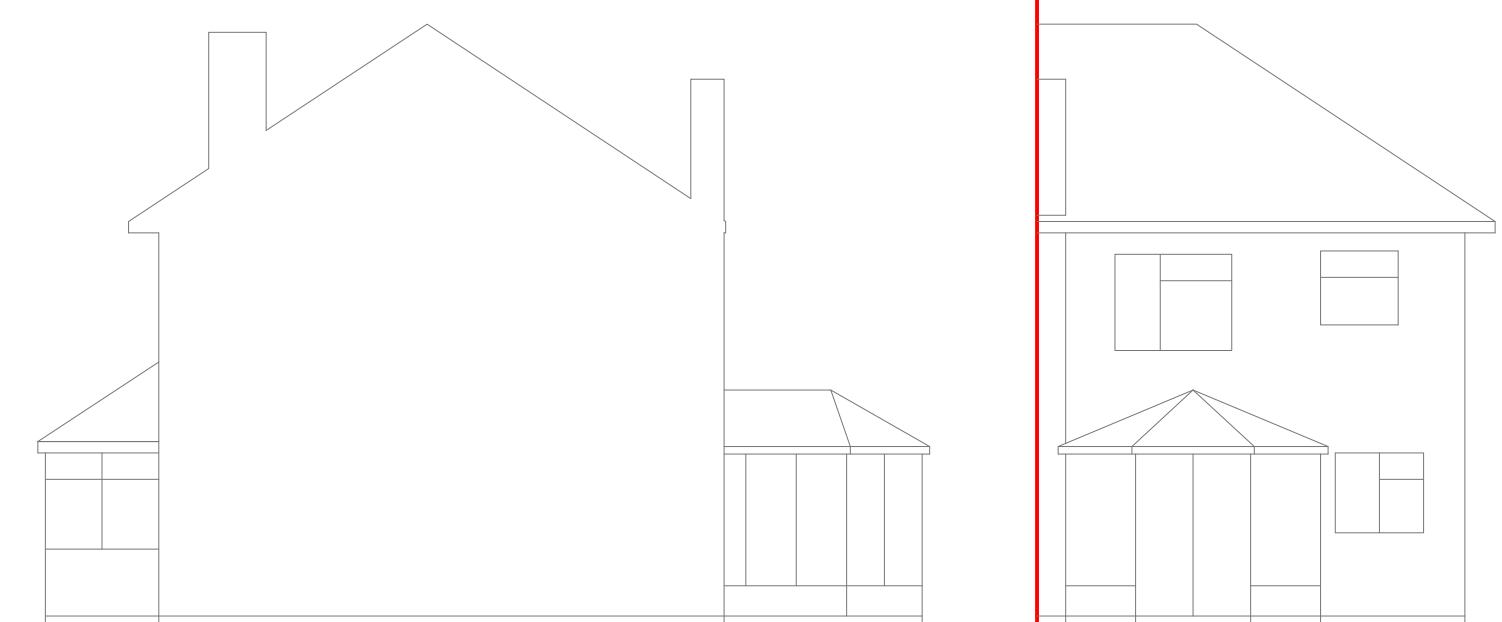


Existing Side Elevation

0 1 2 3 4 5
metres 1:100 scale

Existing Rear Elevation

0 1 2 3 4 5
metres 1:100 scale

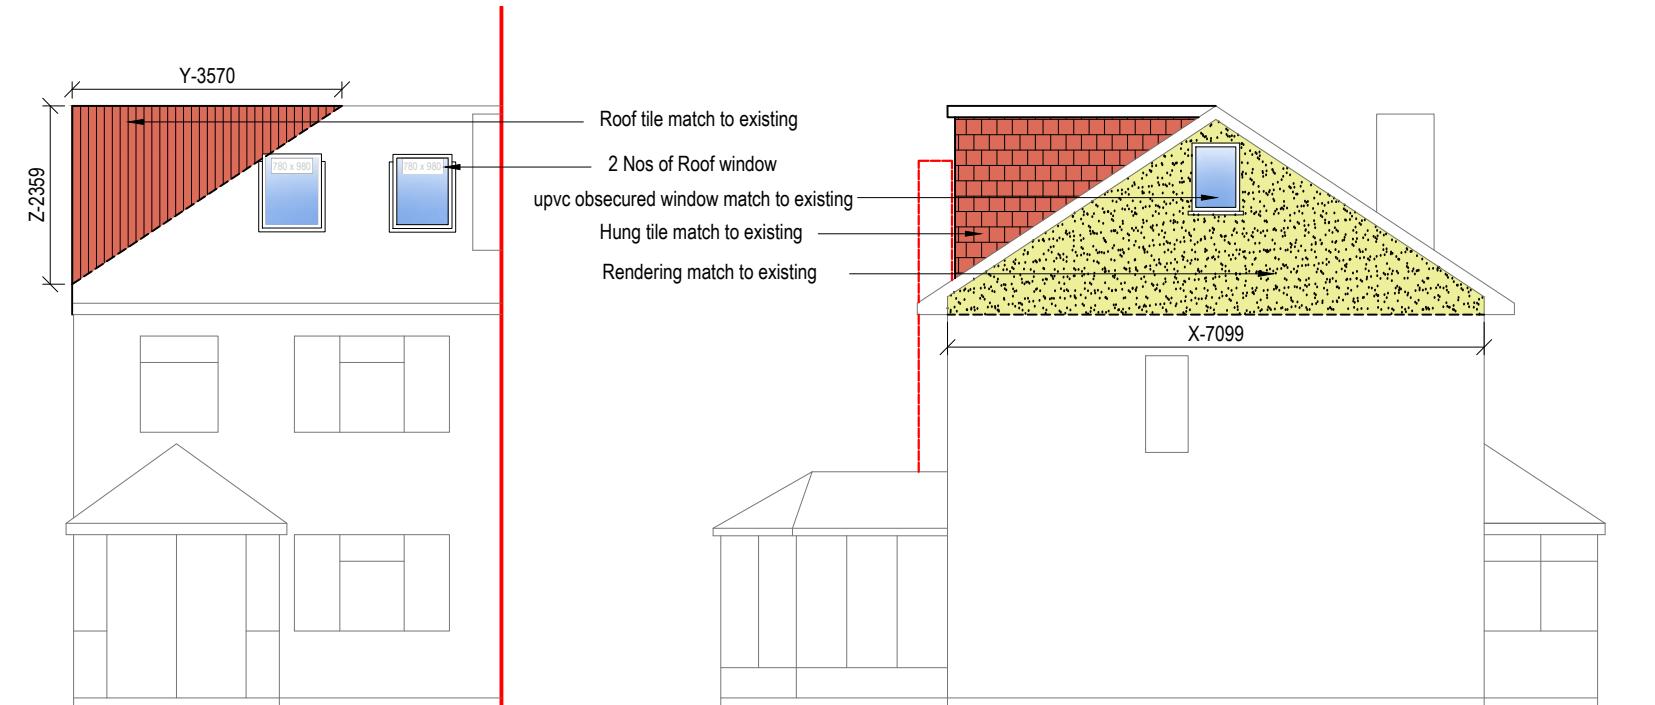

Proposed Front Elevation

0 1 2 3 4 5
metres 1:100 scale

Proposed Side Elevation

0 1 2 3 4 5
metres 1:100 scale

VOLUME CALCULATION :-


1. HIP TO GABLE :-

$$X-7.099 \times Y- 3.570 \times Z- 2.359 \times \frac{1}{6} = 9.964 \text{ M}^3$$

2. DORMER :-

$$A-3.450 \times B-2.280 \times C-5.510 \times \frac{1}{2} = 21.670 \text{ M}^3$$

$$\text{TOTAL} :- 9.964 + 21.670 = 31.634 \text{ M}^3$$

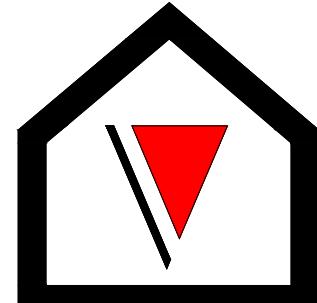

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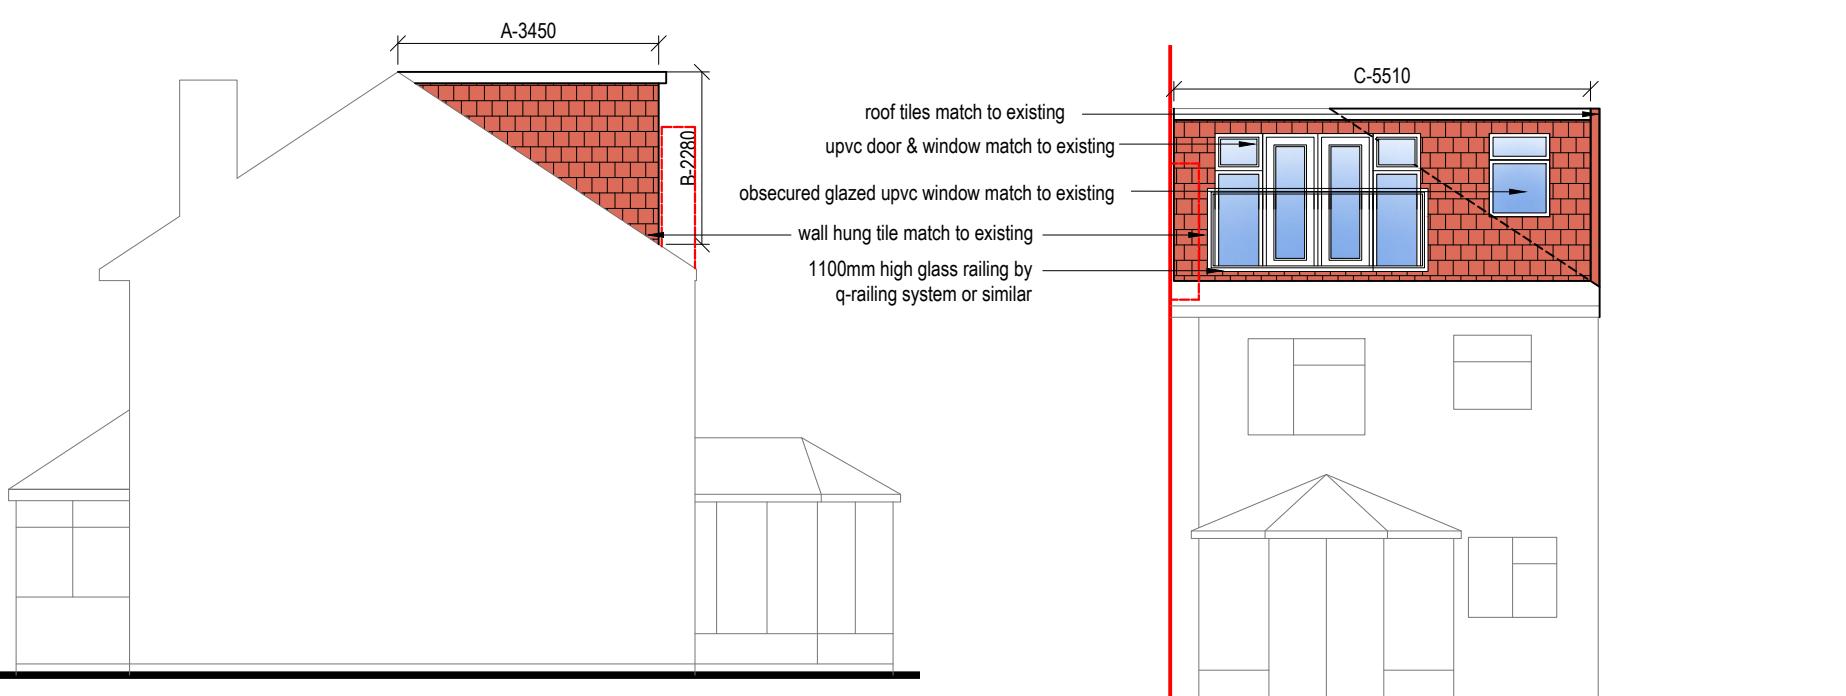
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Existing Wall	Cavity Wall
Internal Wall	Internal Wall
Site Boundary	Site Boundary
Windows	Windows
Doors	Doors

Drawing Title:		
Proposed Elevations		
Scale: 1:100	Paper Size: A3	

REVISION/ COMMENTS :		
No:	Comments:	Date:

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Job Ref:	24137
Date:	Nov 2024
Drawing No.	LW - 03



Proposed Side Elevation

0 1 2 3 4 5
metres 1:100 scale

Proposed Rear Elevation

0 1 2 3 4 5
metres 1:100 scale

NOTE:

ANY WINDOW INSERTED ON WALL OR ROOF SLOPE
FORMING A SIDE ELEVATION OF THE DWELLING
SHALL BE:

1. OBSECURE P GLAZED
2. NON- OPENING UNLESS THE PARTS OF THE
WINDOW WHICH CAN BE OPENED ARE MORE
THAN 1.7 METERS ABOVE THE FLOOR OF THE
ROOM IN WHICH THE WINDOW IS INSTALLED.
3. ROOF WINDOW WILL NOT PROTRUDE MORE
THAN 150MM