


All materials used in the proposed will match existing materials


Roof lights will not protrude more than 150mm above the roof line.

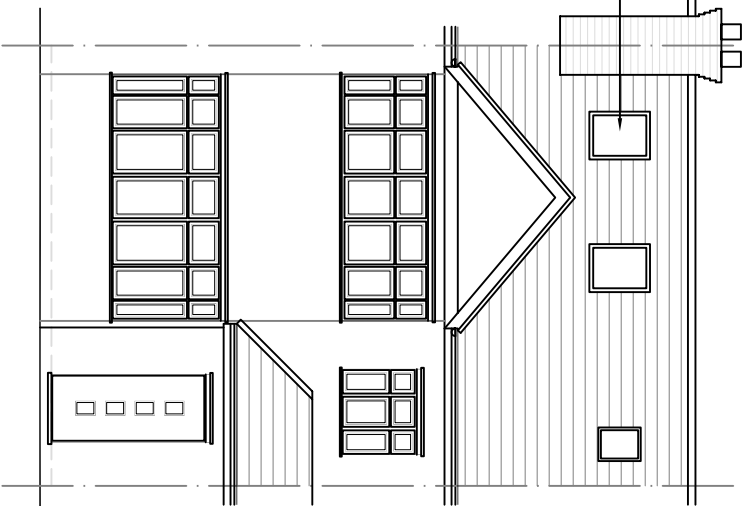

Front Elevation




Rear Elevation

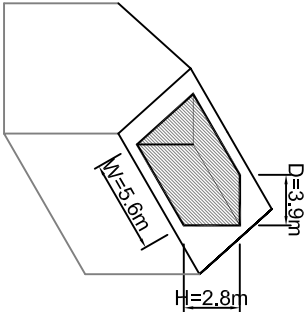


Volume of Rear Dormer  
Width x Height x Depth


$$\frac{5.6 \times 2.8 \times 3.9}{2} = 30.6\text{m}^3$$

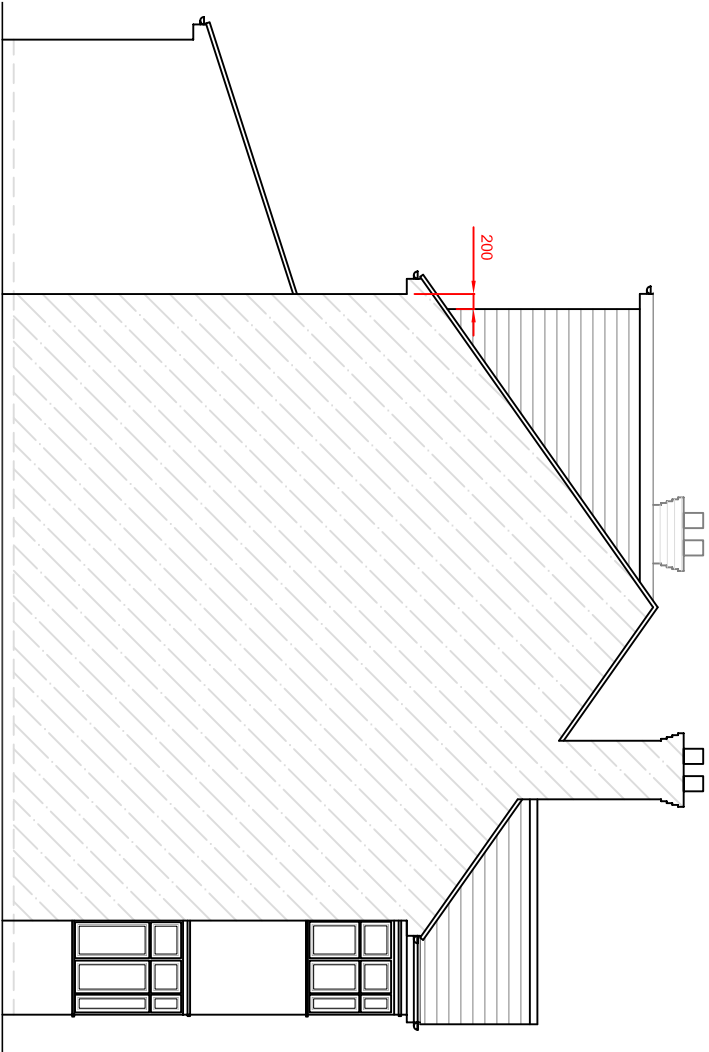

Side Elevation (LHS)

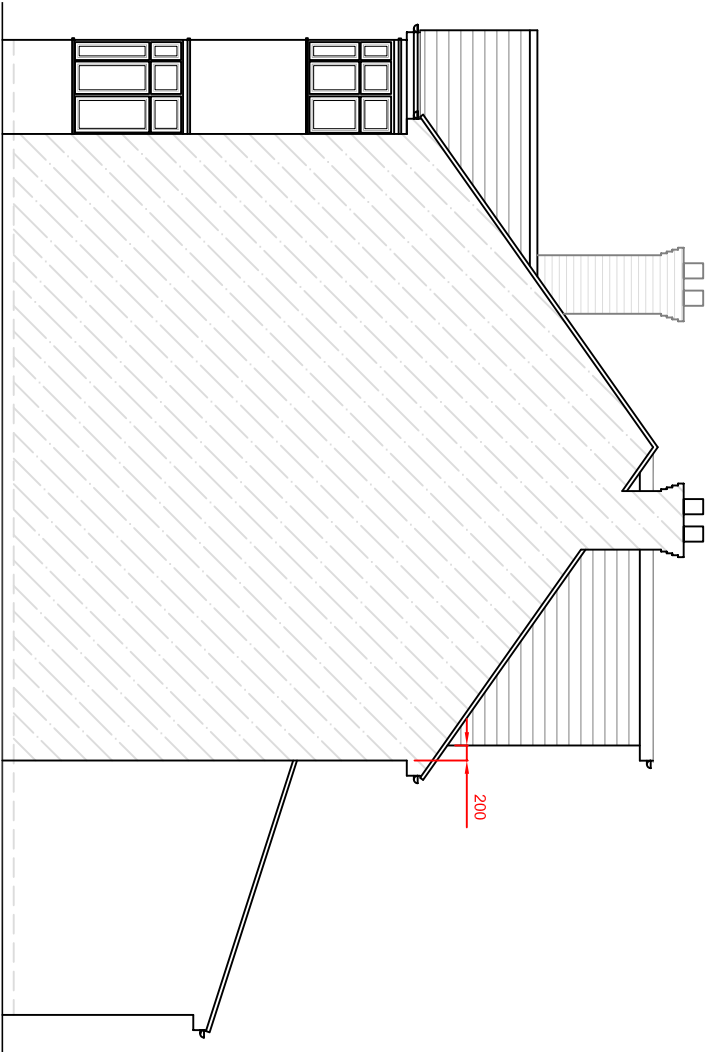

Side Elevation (RHS)

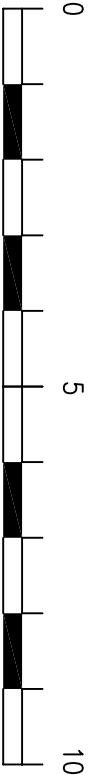

Millimetres Scale 1 to 100

rev			
These drawings should be approved by local Authority			
No dimensions to be scaled from this drawing. All dimensions to be checked on site. This drawing is copyright and should not be reproduced without permission of the Architects.			
client: <b>Mr. Mike Hyde</b>			
project: <b>50 Torrington Road</b>			
<b>Ruislip</b>			
<b>HA4 0AT</b>			
drawing:			

Proposed Elevations

scale: 1:100	date: Sept 2022	drawn:
03 / 05		rev: