



Existing Ground Floor Plan
Scale 1:100

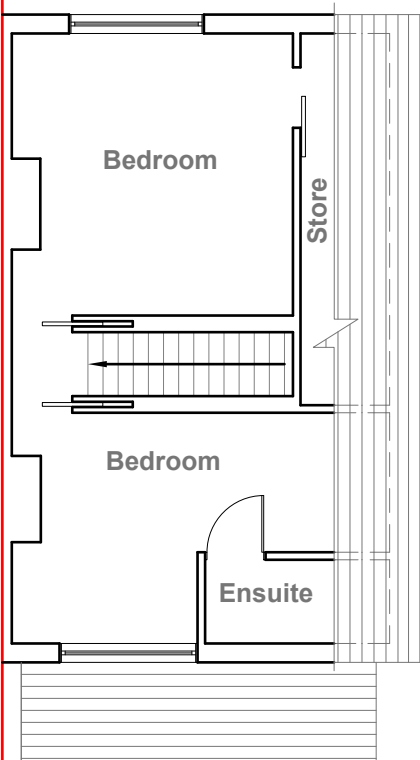


Existing First Floor Plan
Scale 1:100



Existing Front Elevation
Scale 1:100

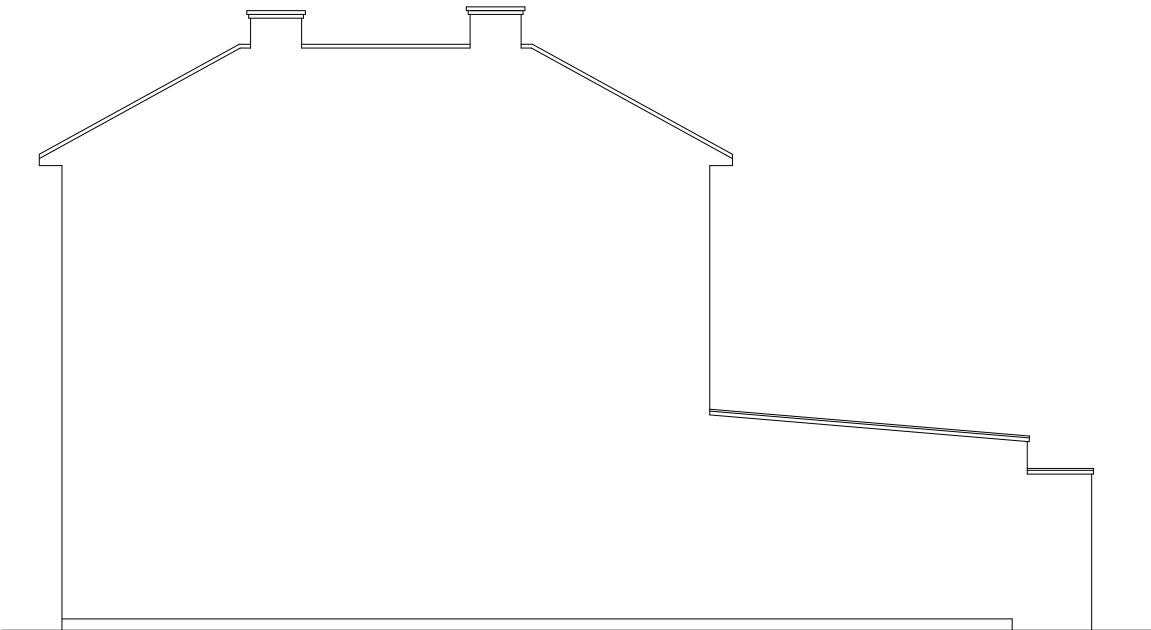

Existing Side Elevation
Scale 1:100

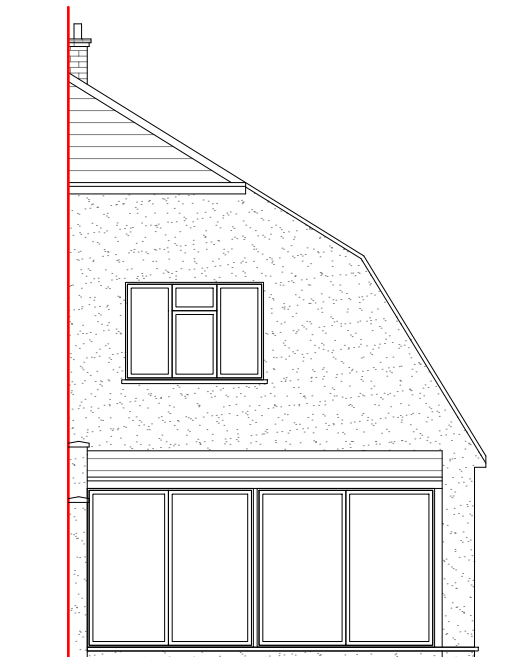

Existing Rear Elevation
Scale 1:100



Existing Side Elevation
Scale 1:100

- GENERAL NOTES:
1. ALL DIMENSIONS ARE IN MILLIMETER.
 2. VERIFY ALL DIMENSIONS AND CONDITIONS BEFORE BUILDING OR STARTING CONSTRUCTION. NOTIFY THE DESIGNER IMMEDIATELY OF ANY DISCREPANCY OR VARIATION.
 3. ALL WORK TO COMPLY WITH CURRENT BUILDING REGULATIONS AND CODES OF PRACTICE




Title:

Existing Floor Plans

Site Address	Scale: 1:100 @A3
8 Hardinge Close, Uxbridge. UB8 3BZ	Date: 11/08/2022
	Drawing No.: 2022/110 -01
	Drawn By: RO

Revision Date:	Faluck Patel
e:mail - faluckpatel@yahoo.com (M) +44 (0) 7871 466 254	

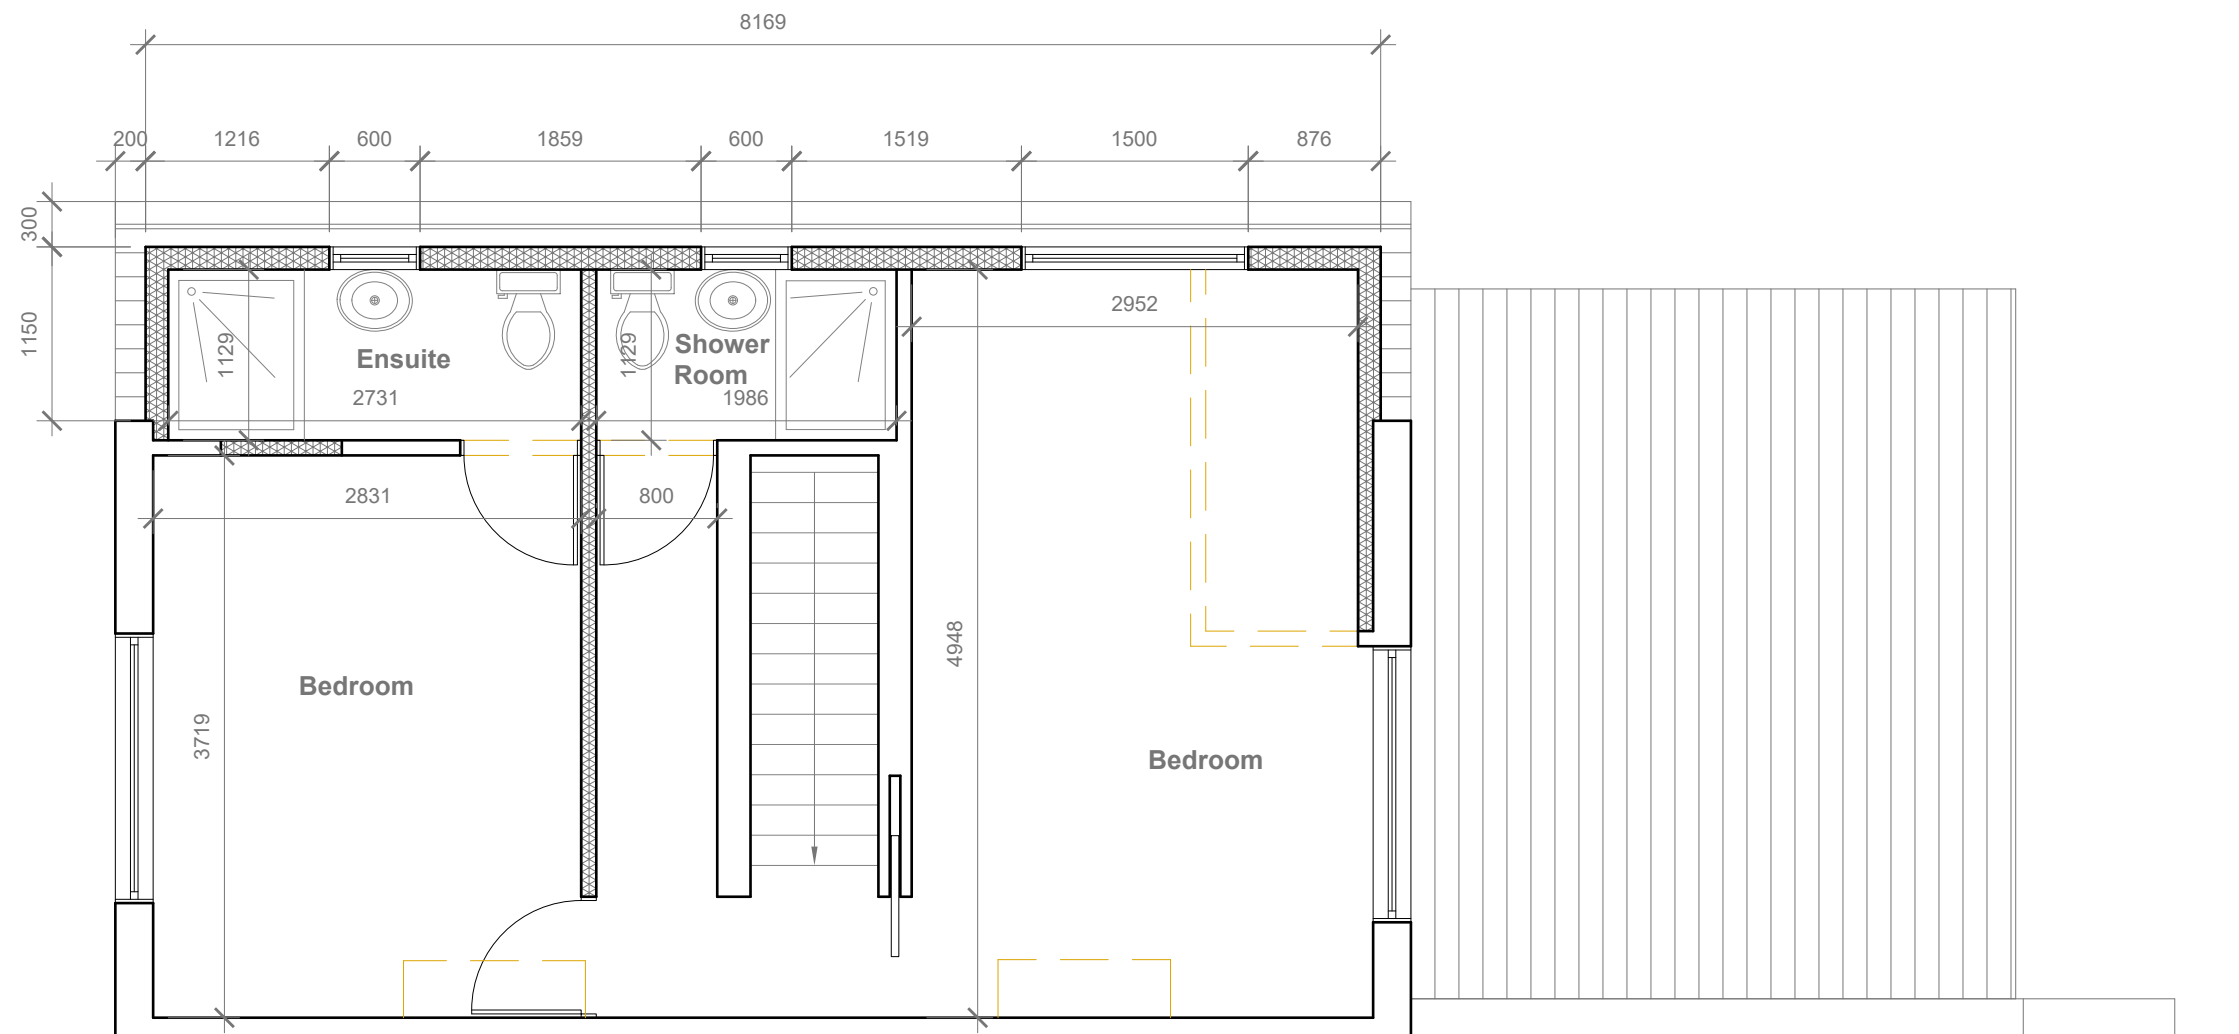

Proposed First Floor Plan
Scale 1:50

GENERAL NOTES:
1. ALL DIMENSIONS ARE IN MILLIMETER.
2. VERIFY ALL DIMENSIONS AND CONDITIONS BEFORE BUILDING OR STARTING CONSTRUCTION. NOTIFY THE DESIGNER IMMEDIATELY OF ANY DISCREPANCY OR VARIATION.
3. ALL WORK TO COMPLY WITH CURRENT BUILDING REGULATIONS AND CODES OF PRACTICE

Title:
Proposed First Floor Plan

Site Address
8 Hardinge Close,
Uxbridge.
UB8 3BZ


Scale: 1:50 @A3
Date: 11/08/2022
Drawing No.:
2022/110 -02PD
Drawn By:
RO

Revision Date:
e:mail -
faluckpatel@yahoo.com
(M) +44 (0) 7871 466 254


**Faluck
Patel**

Proposed External Finish
Materials to Match Existing
External Finish Materials

Proposed Flank Wall Window to be Obscure
Glazed and Non Opening below 1.7m from
FFL

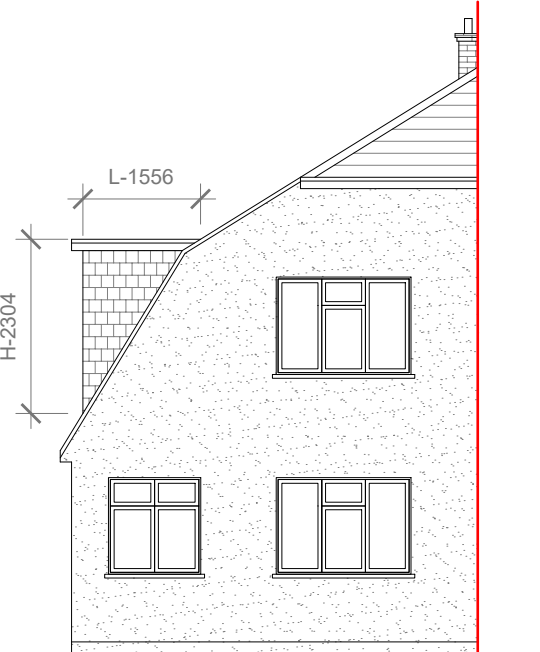

Proposed Front Elevation
Scale 1:100

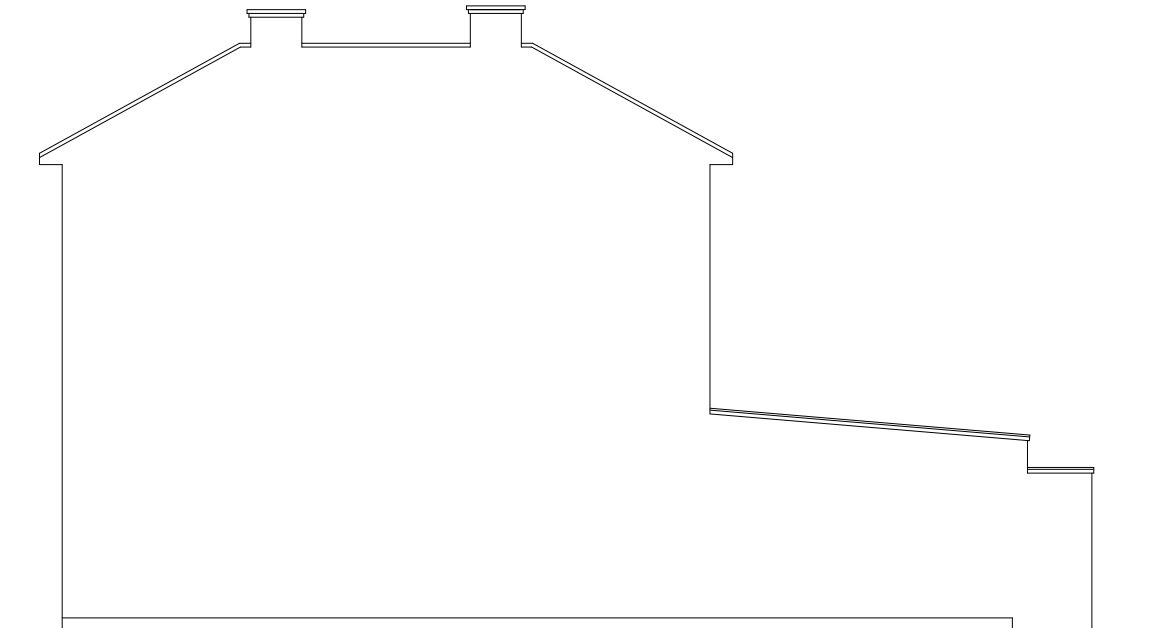

Proposed Side Elevation
Scale 1:100


DORMER VOLUME =

W X H X L / 2

8.169 X 2.304 X 1.556/ 2

29.28 / 2

V1 = 14.64 CU.MT. < 50.00 CU.MT.

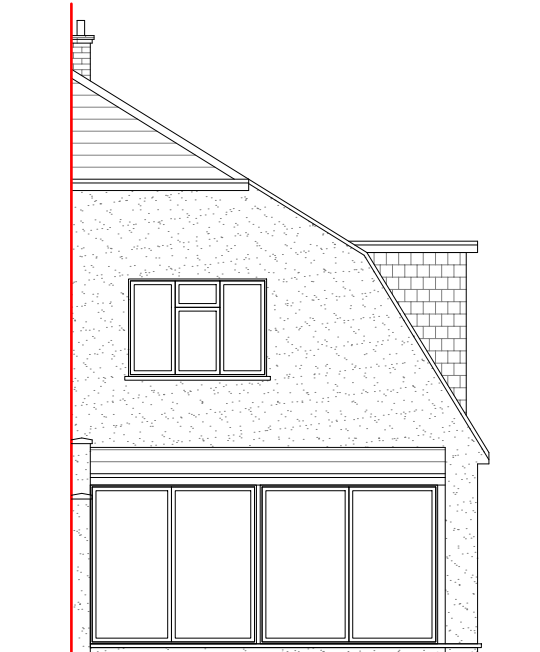

Proposed Front Elevation
Scale 1:100



Proposed Side Elevation
Scale 1:100



GENERAL NOTES:
1. ALL DIMENSIONS ARE IN MILLIMETER.
2. VERIFY ALL DIMENSIONS AND CONDITIONS BEFORE BUILDING OR STARTING CONSTRUCTION. NOTIFY THE DESIGNER IMMEDIATELY OF ANY DISCREPANCY OR VARIATION.
3. ALL WORK TO COMPLY WITH CURRENT BUILDING REGULATIONS AND CODES OF PRACTICE

Title:

Proposed Elevations


Site Address
8 Hardinge Close,
Uxbridge.
UB8 3BZ

Scale: 1:100 @A3
Date: 11/08/2022
Drawing No.: 2022/110 -03PD
Drawn By: RO

Revision Date:


e:mail -
faluckpatel@yahoo.com
(M) +44 (0) 7871 466 254

Faluck
Patel

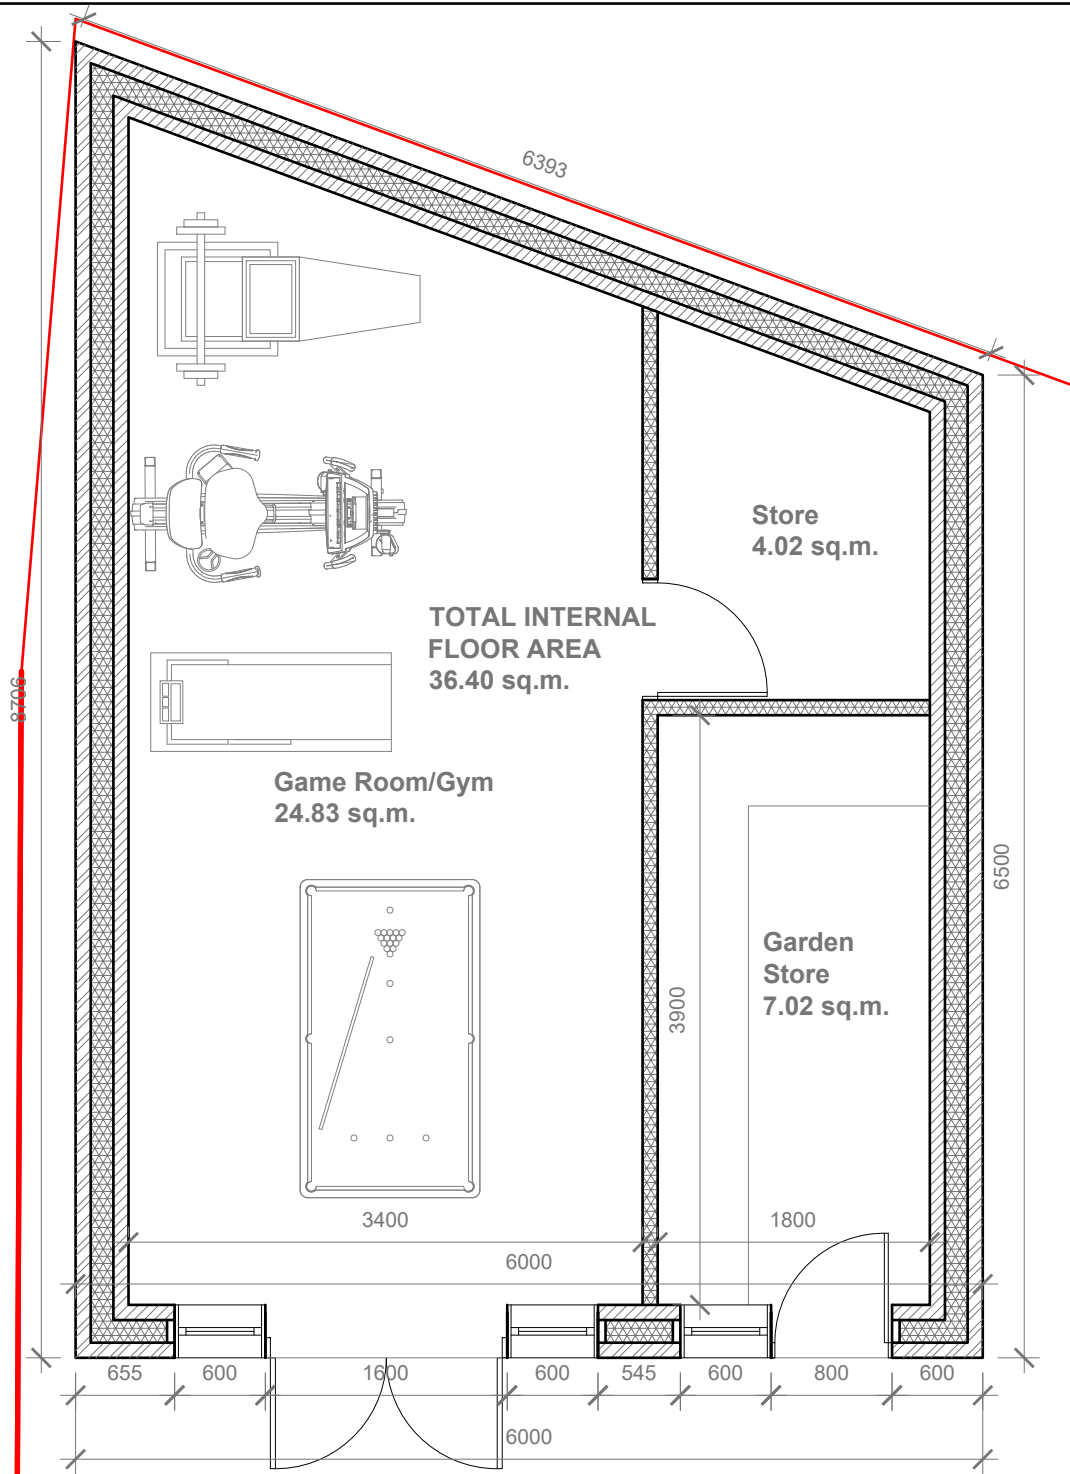


Proposed Outbuilding Plan

Scale 1:50

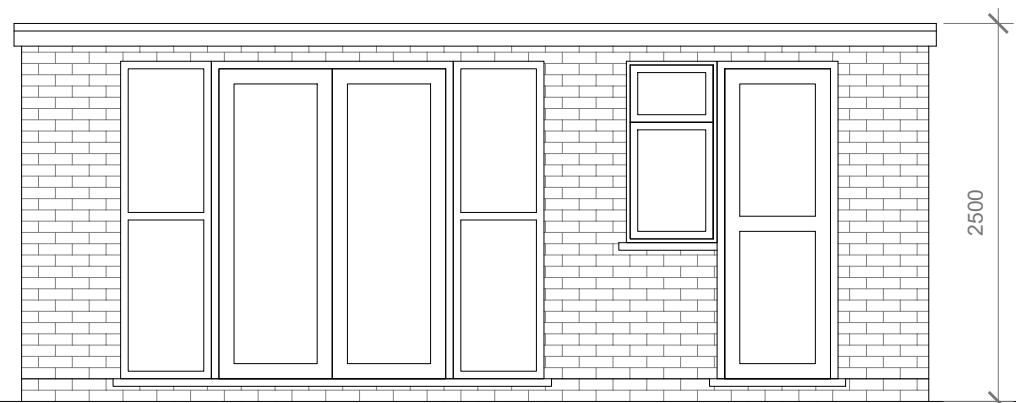


Proposed Front Elevation

Scale 1:50

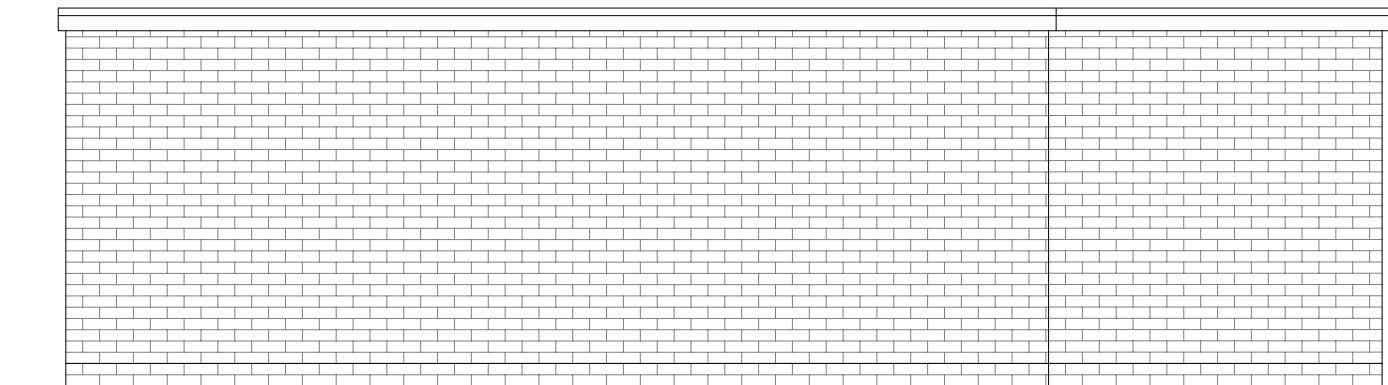


Proposed Side Elevation

Scale 1:50

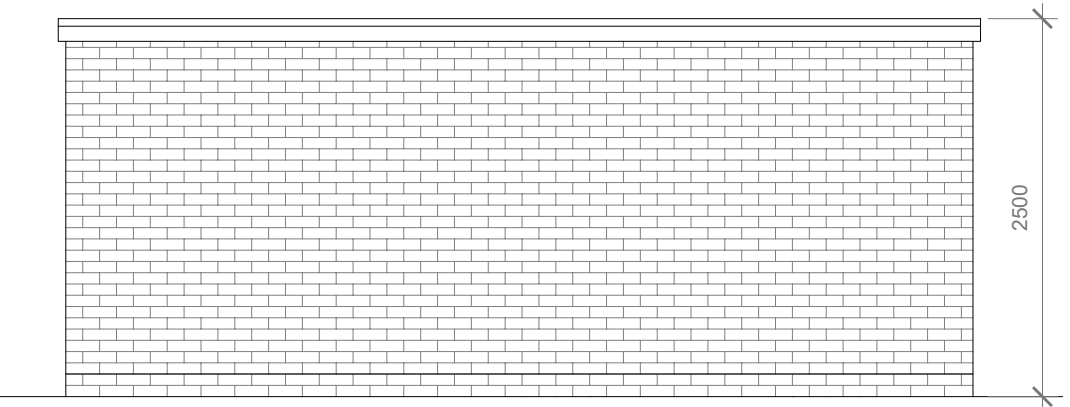

Proposed Rear Elevation

Scale 1:50

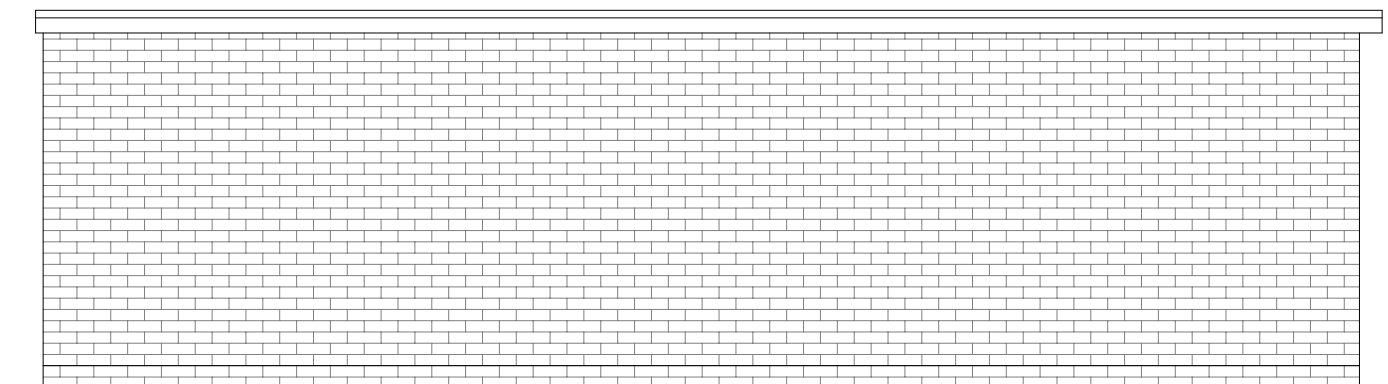

Proposed Side Elevation

Scale 1:50

- GENERAL NOTES:
1. ALL DIMENSIONS ARE IN MILLIMETER.
 2. VERIFY ALL DIMENSIONS AND CONDITIONS BEFORE BUILDING OR STARTING CONSTRUCTION. NOTIFY THE DESIGNER IMMEDIATELY OF ANY DISCREPANCY OR VARIATION.
 3. ALL WORK TO COMPLY WITH CURRENT BUILDING REGULATIONS AND CODES OF PRACTICE



Title:

Proposed Outbuilding Plan & Elevations

Site Address	Scale: 1:50 @A3
8 Hardinge Close, Uxbridge. UB8 3BZ	Date: 11/08/2022
	Drawing No.: 2022/110 -04/PD
	Drawn By: RO

Revision Date:	Faluck Patel
e:mail - faluckpatel@yahoo.com (M) +44 (0) 7871 466 254	