

Existing Ground Floor Plan

Scale 1:100




Existing Front Elevation

Scale 1:100



Existing Side Elevation

Scale 1:100

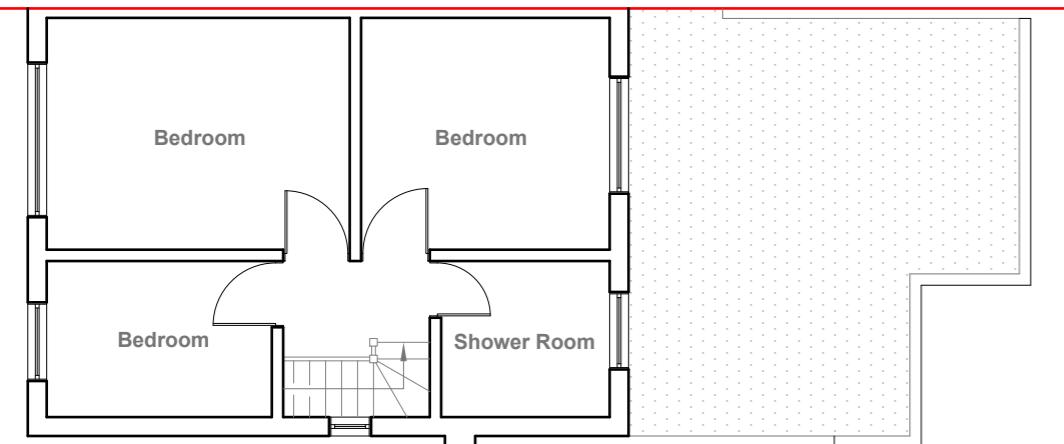


Existing First Floor Plan

Scale 1:100



Existing Rear Elevation

Scale 1:100

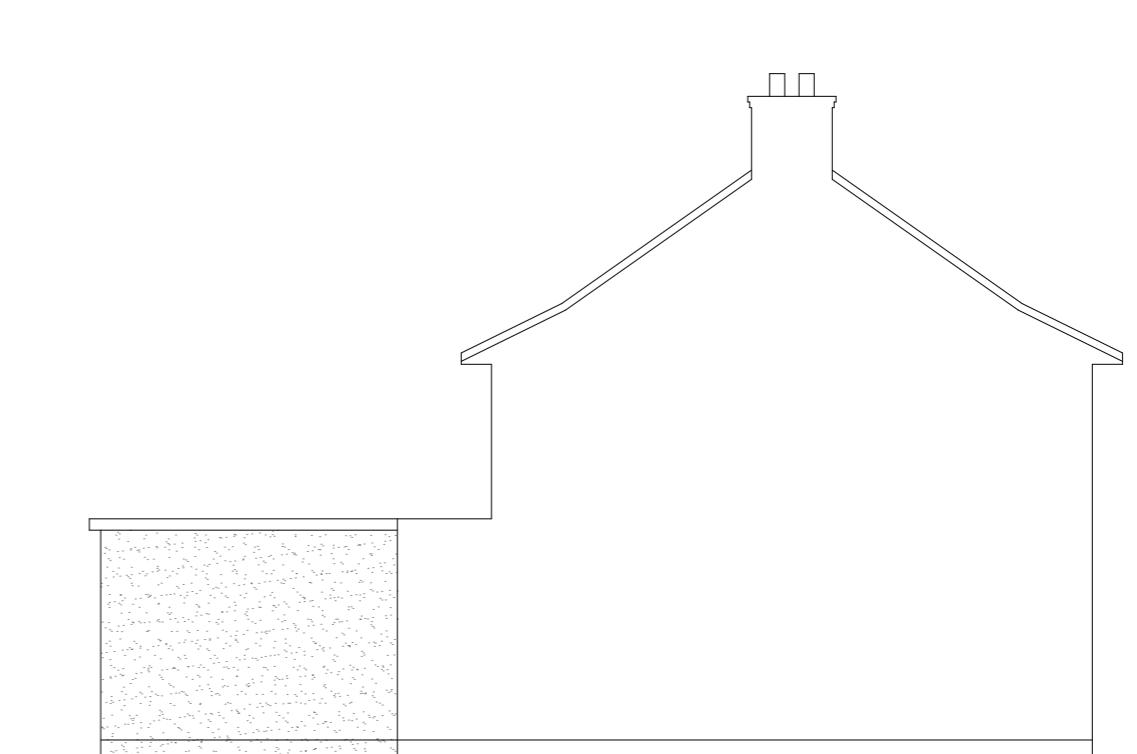

Existing Side Elevation

Scale 1:100

GENERAL NOTES:

1. ALL DIMENSIONS ARE IN MILLIMETER.
2. VERIFY ALL DIMENSIONS AND CONDITIONS BEFORE BUILDING OR STARTING CONSTRUCTION. NOTIFY THE DESIGNER IMMEDIATELY OF ANY DISCREPANCY OR VARIATION.
3. ALL WORK TO COMPLY WITH CURRENT BUILDING REGULATIONS AND CODES OF PRACTICE



Title

Existing Floor Plans & Elevations

Site Address
10 Goshawk
Gardens,
Hayes,
UB4 8LA

Scale: 1:100 @A3
Date: 20/02/2024
Drawing No.:
2024/029 -01
Drawn By:

revision Date:
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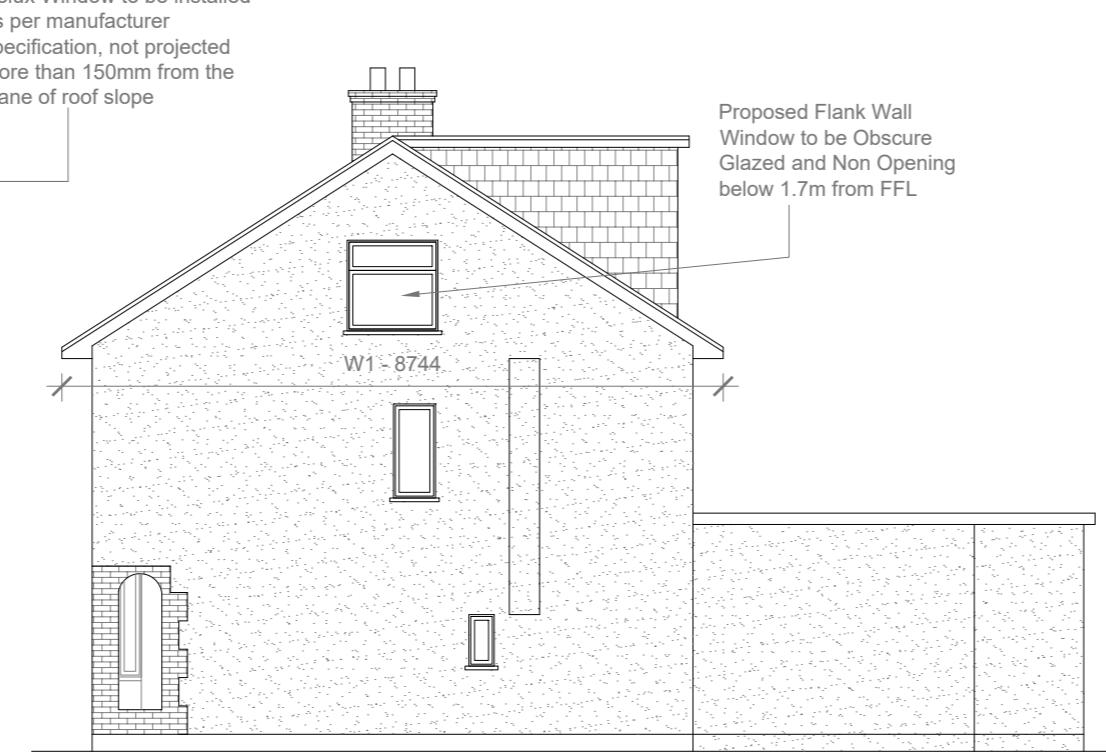


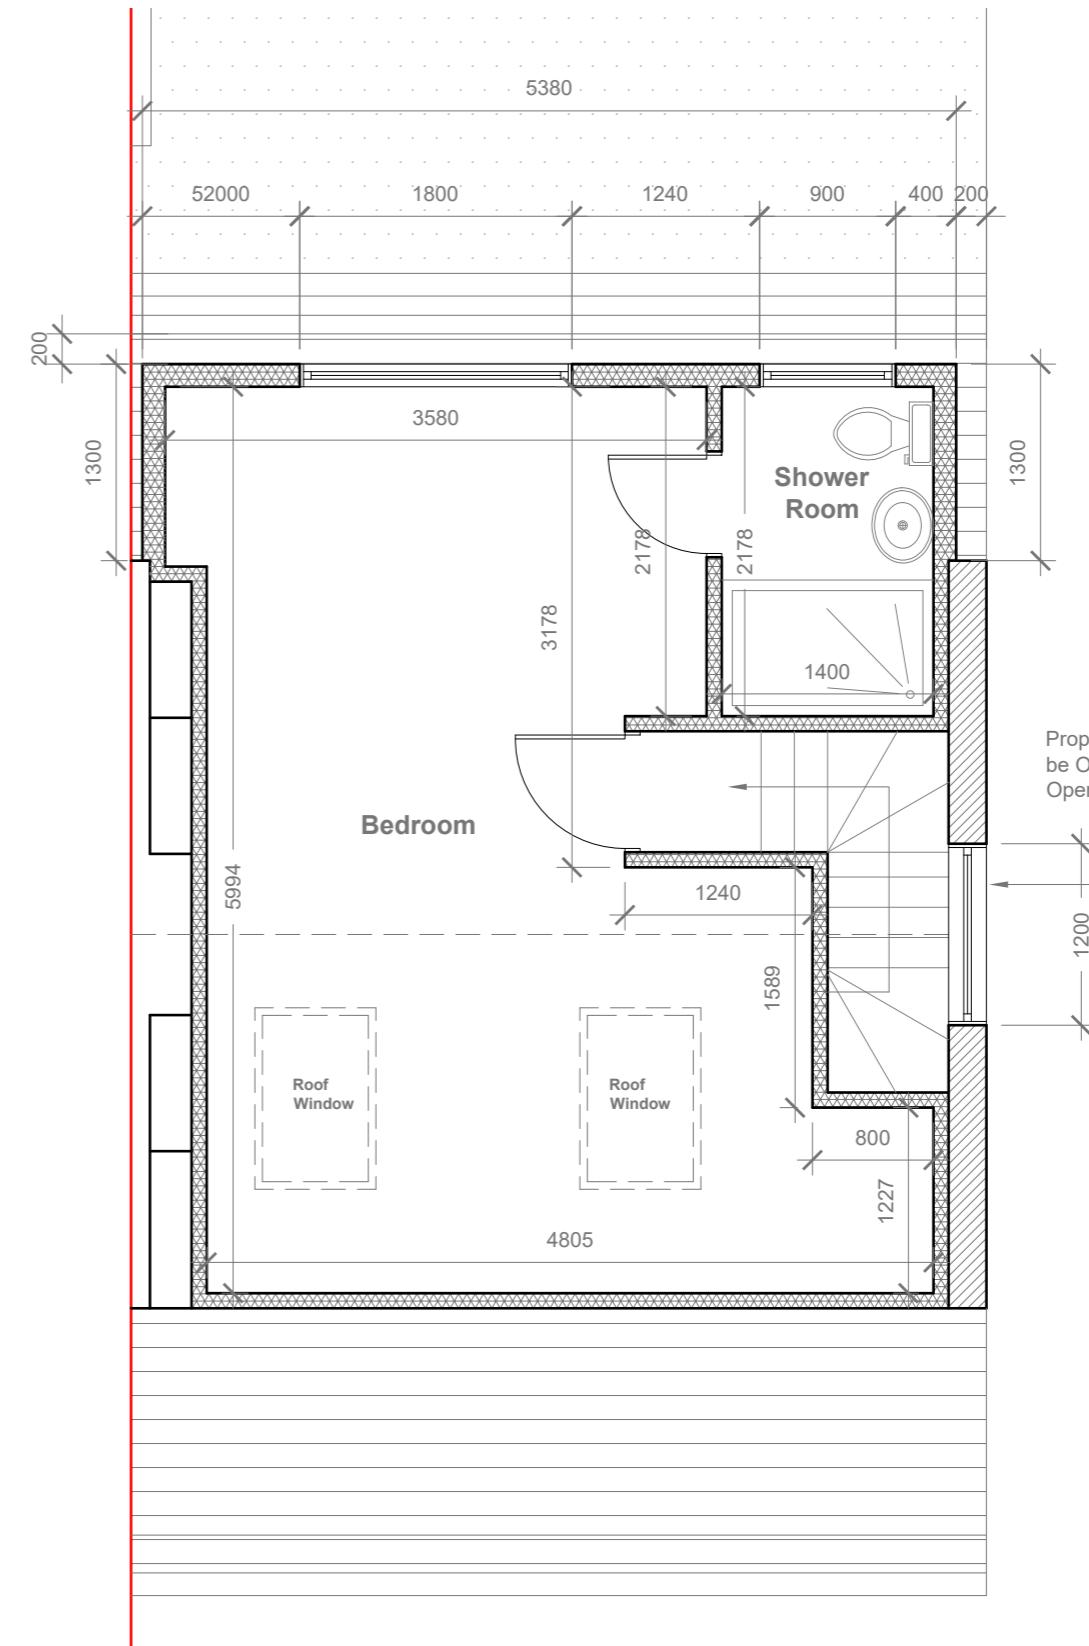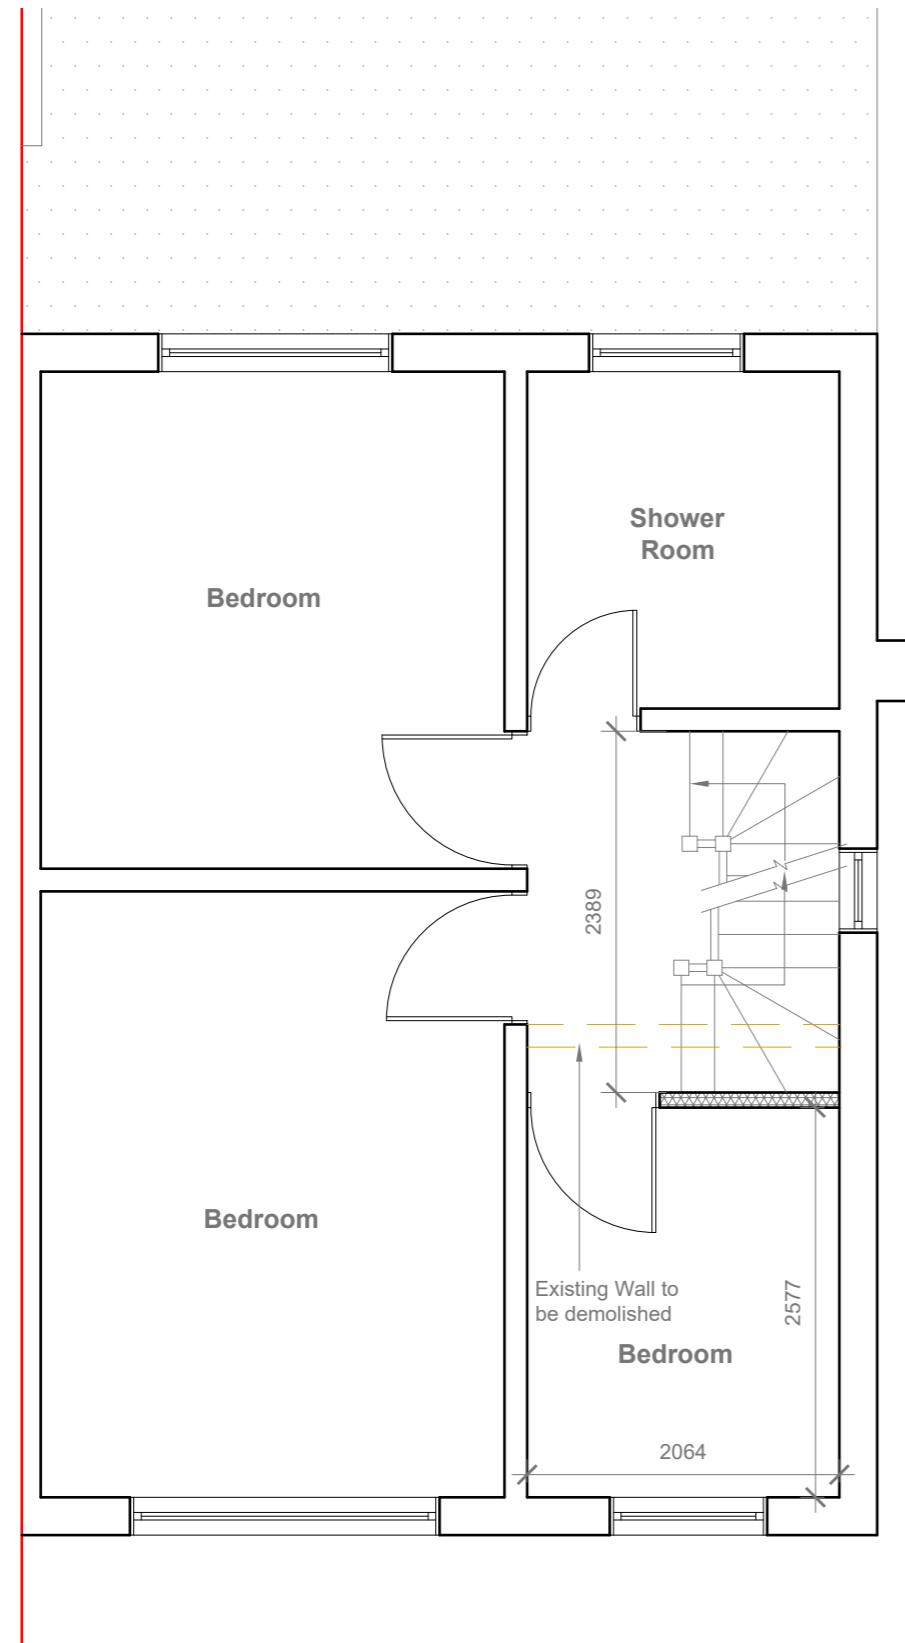Proposed First Floor Plan & Loft Floor Plan

Proposed External Finish Materials to Match Existing External Finish Materials




Proposed Front Elevation
Scale 1:100



Proposed Side Elevation
Scale 1:100



Proposed Rear Elevation
Scale 1:100

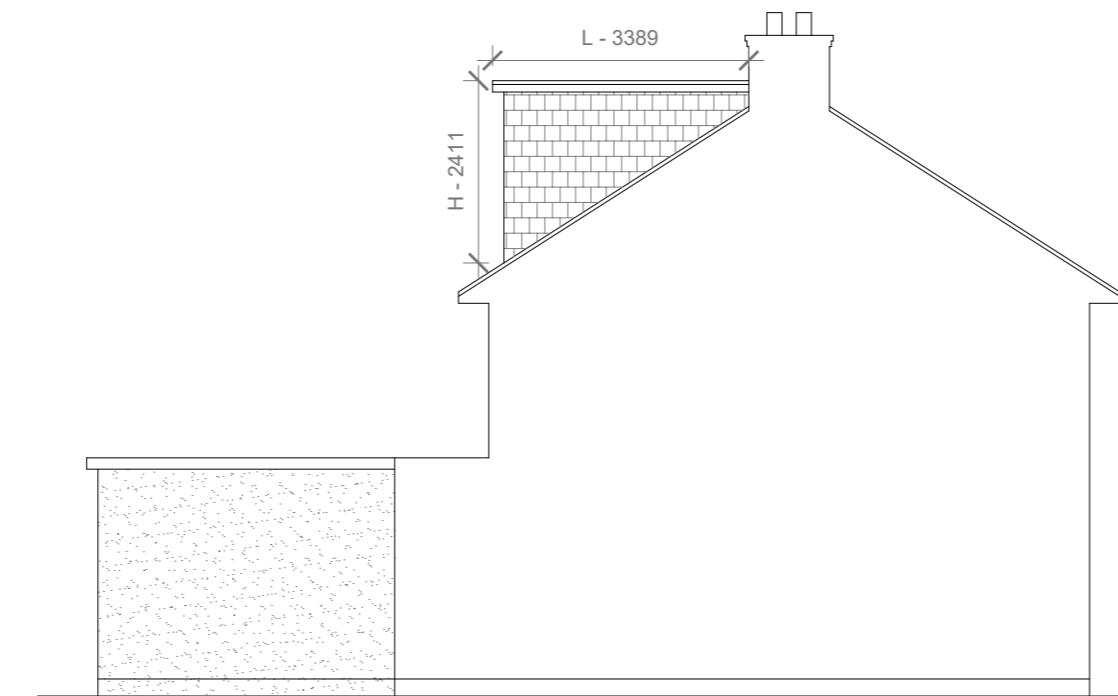

Proposed Side Elevation
Scale 1:100

REAR DORMER VOLUME =

$$V1 = \frac{W \times H \times L}{2}$$

$$5.480 \times 2.411 \times 3.389 / 2$$

$$44.78 / 2$$

$$22.39 \text{ CU.MT.}$$

HIP TO GABLE ROOF VOLUME =

$$V2 = \frac{W1 \times H1 \times L1}{6}$$

$$8.744 \times 2.944 \times 4.022 / 6$$

$$103.54 / 6$$

$$17.567 \text{ CU.MT.}$$

TOTAL ROOF VOLUME =

$$V1 + V2$$

$$22.39 + 17.567$$

$$39.957 \text{ CU.MT.} < 50.00 \text{ CU.MT.}$$

10 Meter
5
2
1
0

1:100

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Title:

Proposed Elevations

Site Address
10 Goshawk
Gardens,
Hayes,
UB4 8LA

Scale: 1:100 @A3
Date: 20/02/2024
Drawing No.: 2024/029 -03

Revision Date:
Drawn By:
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