

ORDNANCE SURVEY GRID

NOTES

- 1) ALL DIMENSIONS TO BE CHECKED ON SITE AND NOT SCALED FROM THIS DRAWING.
- 2) HOLLIS SHALL BE INFORMED IN WRITING OF ANY CHANGES MADE TO THIS DRAWING.
- 3) ALL DIMENSIONS ARE IN METRES ONLY.
- 4) THE ORIGIN AND ORIENTATION OF THE SURVEY GRID REFER TO THE ORDNANCE SURVEY GRID.
- 5) ALL LEVELS ARE BASED ON A GPS TIE TO THE OSGM15(CB) GEODID MODEL.

KEY

A	Alarm	H8	Hand Basin
A/C	Air Conditioner	HR	Handrail
AH	Arch Height	IC	Inspection Cover
Al.	Arch	IRF	Iron Rolling Fence
ASH	Arch Spring Height	IRB	Iron Rolling Box
ASL	Arch Spring Level	JB	Job Box
ATM	Automated Teller Machine	L	Light
B	Bolton	LB	Leisure Bin
BGP	Break Glass Point	LM	Maximum
Br	Brick	M	Minimum
BW	Brick Wall Height	OB	Open Boarded Fence
BSL	Brick Soffit Level	OSBM	Ordnance Survey Bench Mark
BW	Brick Wall	P	Post
BW	Brick Wall	PL	Pavement Light
CBF	Close Boarded Fence	PLF	Pavement Light Fence
CBF	Close Boarded Fence	PS	Paving Stones
CCT	Closed Circuit Television	PP	Post and Wire Fence
CH	Chimney	RD	Rod
Chy	Chimney	RDGM	Recessed Door Mat
CF	Cast Iron Fence	RH	Roller
CL	Cover Level	RSD	Roller Shutter Door
CL	Chain Link Fence	RSJ	Rolled Steel Joint
Col	Column	RSW	Roller Shutter Window
Conc	Concrete	SB	Sign Board
Cov	Cover	SM	Signage Mark
CPS	Concrete Paving Slabs	SP	Security Fence
Cup	Cupboard	SH	Spring Height
DN	Drip	SL	Spring Length
DP	Down Pipe	SO	Smoke Outlet
DHC	Duct Height	SP	Sign Post
DH	Duct Height	SS	Sign Sensor
EJB	Electrical Junction Box	T	Telephone
EM	Emergency	TM	Threshold Bench Mark
ESG	Electrical Switchgear	TL	Top Of Wall
FA	Fire Alarm	TLW	Top Of Wall
FB	Fire Alarm Box	U	Unable To Lift
FC	Floor To Cill Height	Y	Vehicle Charging Point
FE	Floor	VP	Vent Pipe
FIR	Fire Hose Reel	WP	Water Pipe
FL	Floor Level	WCL	Window Cill Level
Fls	Flights	WHL	Window Head Level
G	Gully	WM	Water Meter
GM	Gas Meter		
GV	Gas Valve		
H	Height		

FLOOR PLAN SYMBOLS

25.50	Spot Level
3.20	Floor To Soffit Height
27.50	Floor To False Ceiling Height
25.00	Soffit Level
23.00	False Ceiling Level
Stair Arrow (points up)	Stair Arrow
Structural Overhead Slope (points up)	Structural Overhead Slope
Non-Structural Overhead Slope (points up)	Non-Structural Overhead Slope
Roof Slope (points down)	Roof Slope
Structural Ceiling Vault/Half Vault	Structural Ceiling Vault/Half Vault
Non-Structural Ceiling Vault/Half Vault	Non-Structural Ceiling Vault/Half Vault

REVISIONS

C01	09.09.22	Drawing layout updated.	NH
REV.	DATE	AMENDMENTS	INITIAL

THIS DRAWING IS FOR THE FOLLOWING PURPOSE ONLY:
 PRELIMINARY TENDER CONSTRUCTION
 SKETCH MEASURED SURVEY CONTRACT

TITLE

EXISTING FLOOR PLAN

CLIENT

Royal London Asset Management Ltd
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PROJECT NAME

Pasadena Centre
 Pasadena Close
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DATE 05.08.2022 DRAWN BY SPP


SCALE 1:200 @A1 CHECKED JB

PROJECT LINE ORIGINATOR VOLUME/ZONE/BLDG LEVEL

111794 105 HLS 00 01

FILE DISCRETE/TYPE NUMBER STATUS REVISION

M2 B 10200 A1 C01

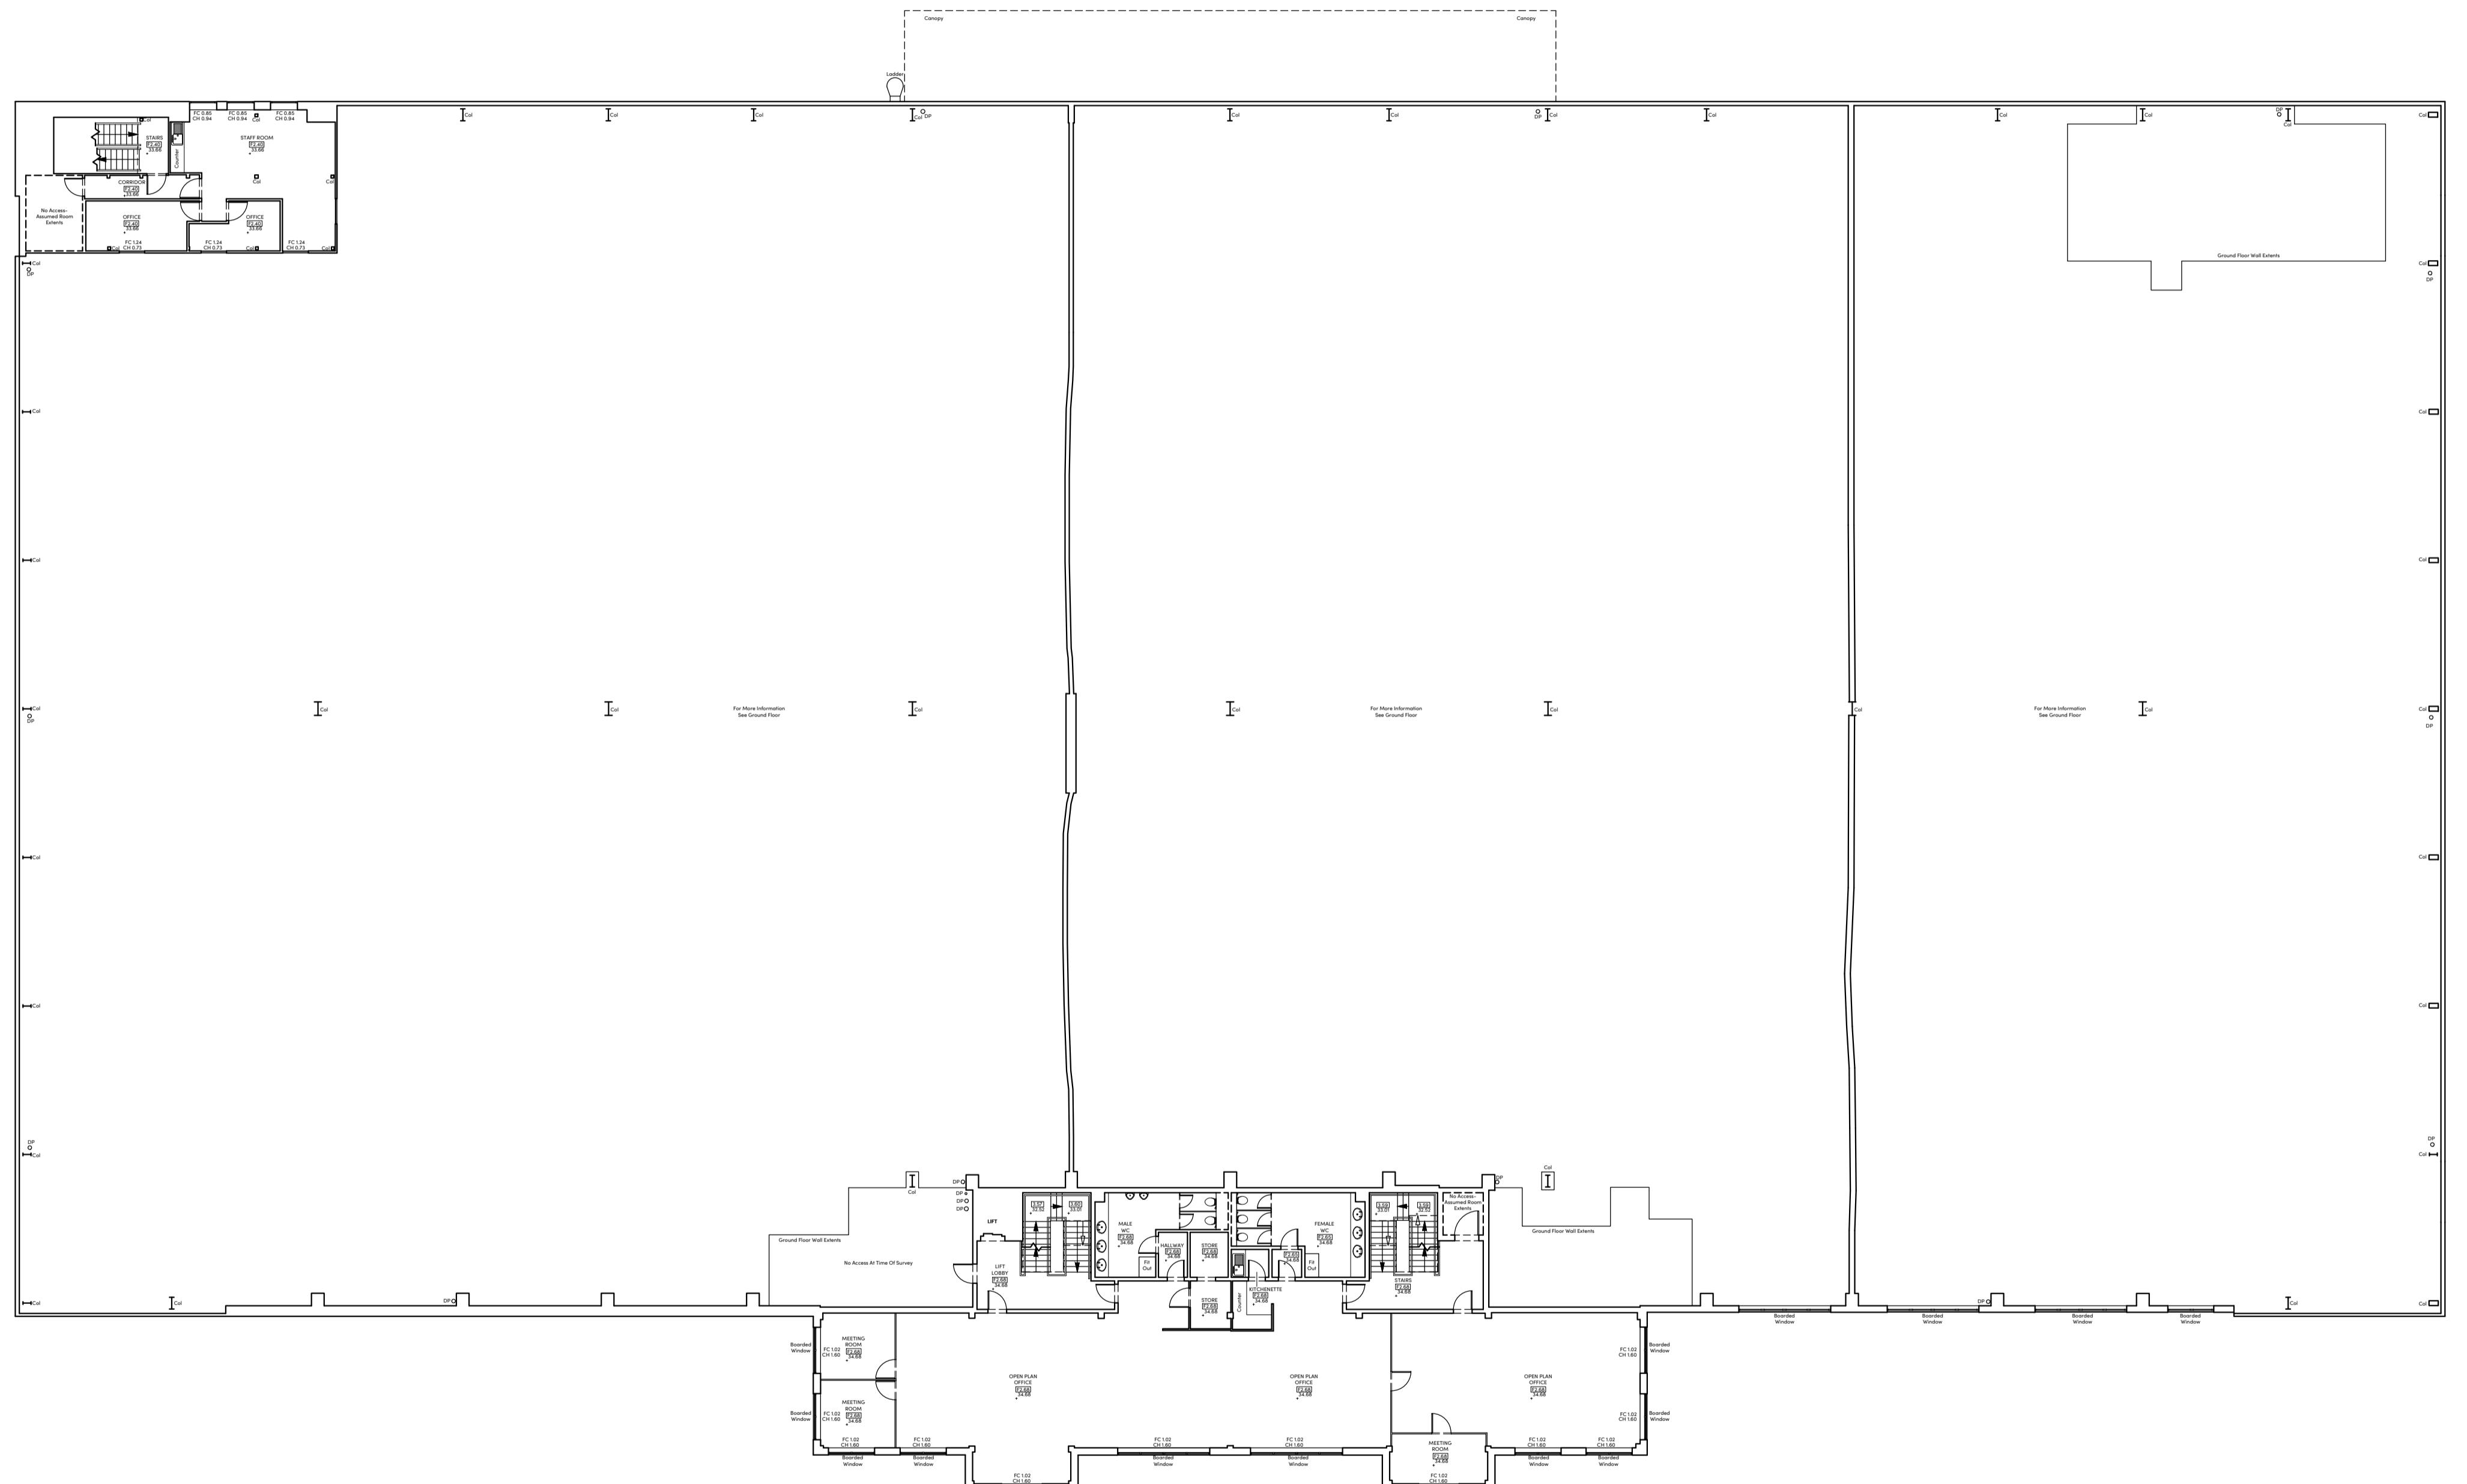

FIRST FLOOR

Scale Bar (m)

0 1 2 3 4 5 6 7 8 9 10 11 12